
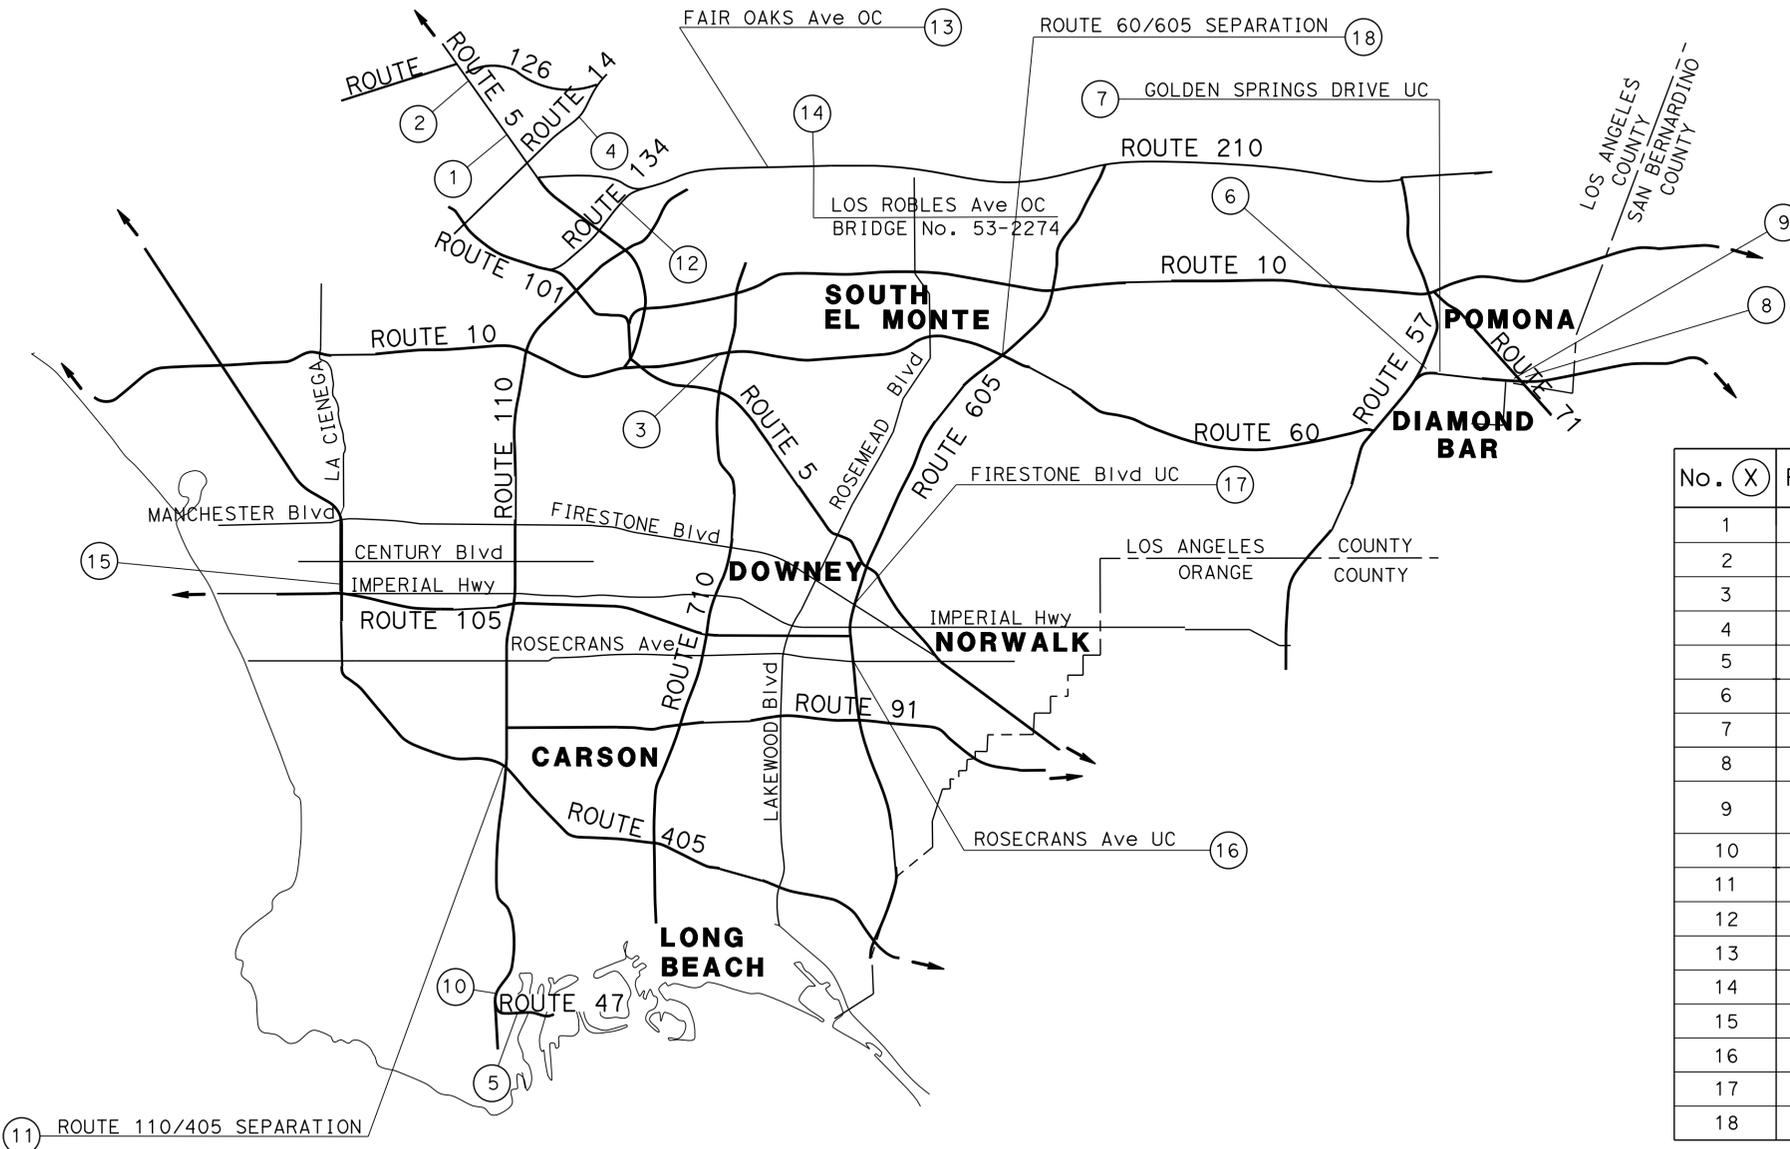


SHEET No.	DESCRIPTION
1	TITLE AND LOCATION MAP
2-19	LAYOUTS
20-30	CONSTRUCTION DETAILS
31-32	UTILITY PLANS
33-41	CONSTRUCTION AREA SIGNS
42-45	TRAFFIC HANDLING PLANS
46	SUMMARY OF QUANTITIES
47-51	HIGHWAY PLANTING
52-72	REVISED AND NEW STANDARD PLANS

THE STANDARD PLANS LIST APPLICABLE TO THIS CONTRACT IS INCLUDED IN THE NOTICE TO BIDDERS AND SPECIAL PROVISIONS BOOK.

STATE OF CALIFORNIA ACSTP-X037(162)E
DEPARTMENT OF TRANSPORTATION
PROJECT PLANS FOR CONSTRUCTION ON
STATE HIGHWAY
IN LOS ANGELES COUNTY AT VARIOUS LOCATIONS

TO BE SUPPLEMENTED BY STANDARD PLANS DATED MAY 2006

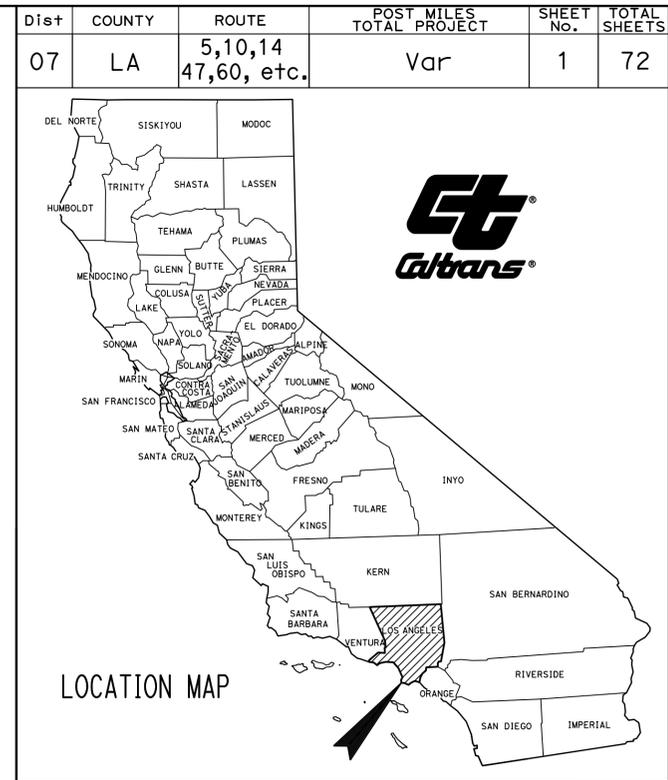


LOCATIONS OF CONSTRUCTION

No. (X)	ROUTE	POST MILE	DESCRIPTION
1	5	53.60	ON ROUTE 5 AT MAGIC MOUNTAIN PARKWAY OFF-RAMPS
2	5	56.30	ON ROUTE 5 AT ROUTE 126 SEPARATION
3	10	21.40	ON WB 10 AT EASTERN Ave OFF-RAMP
4	14	33.40	ON SB ROUTE 14 AT SAND CANYON ROAD ON-RAMP
5	47	0.30	ON SB ROUTE 47 AT HARBOR Blvd OFF-RAMP
6	60	25.60	PARK & RIDE AREA BETWEEN NB ROUTE 57 AND WB ROUTE 60
7	60	26.53	ON ROUTE 60 AT GOLDEN SPRINGS DRIVE
8	60	29.20	ON WB ROUTE 60 AT GAREY Ave OFF-RAMP
9	60	30.40	BETWEEN THE WB ROUTE 60 ON-RAMP AND CONNECTOR RAMP TO EB ROUTE 71 AT GAREY Ave
10	110	0.30	ON SB ROUTE 110 AT MacARTHUR Ave OC
11	110	8.80	ON ROUTE 110 AT ROUTE 405 SEPARATION
12	134	12.60	ON EB ROUTE 134 AT ARROYO SECO SEPARATION
13	210	R25.29	ON ROUTE 210 AT FAIR OAKS Ave OC
14	210	R25.81	ON EB ROUTE 210 AT LOS ROBLES Ave OC
15	405	21.40	ON SB ROUTE 405 AT LA CIENEGA Blvd UC
16	605	6.80	ON ROUTE 605 AT ROSECRANS Ave UC
17	605	R8.40	ON ROUTE 605 AT FIRESTONE Blvd UC
18	605	17.40	ON ROUTE 60/605 SEPARATION

PROJECT MANAGER
OJAS SETHI
 DESIGN ENGINEER
REFUGIO DOMINGUEZ

PROJECT ENGINEER DATE **8/30/12**
 REGISTERED CIVIL ENGINEER
October 22, 2012
 PLANS APPROVAL DATE
THE STATE OF CALIFORNIA OR ITS OFFICERS OR AGENTS SHALL NOT BE RESPONSIBLE FOR THE ACCURACY OR COMPLETENESS OF SCANNED COPIES OF THIS PLAN SHEET.

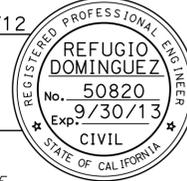

THE CONTRACTOR SHALL POSSESS THE CLASS (OR CLASSES) OF LICENSE AS SPECIFIED IN THE "NOTICE TO BIDDERS."

NO SCALE

DATE PLOTTED => 02-JAN-2013
 TIME PLOTTED => 15:22
 00-00-00

Dist	COUNTY	ROUTE	POST MILES TOTAL PROJECT	SHEET No.	TOTAL SHEETS
07	LA	5,10,14,47,60,etc.	Var	2	72

<i>Refugio Dominguez</i> REGISTERED CIVIL ENGINEER No. 50820 Exp. 9/30/13 CIVIL	8/30/12 DATE 10-22-12 PLANS APPROVAL DATE
---	--


THE STATE OF CALIFORNIA OR ITS OFFICERS OR AGENTS SHALL NOT BE RESPONSIBLE FOR THE ACCURACY OR COMPLETENESS OF SCANNED COPIES OF THIS PLAN SHEET.

NOTES:

- FOR ACCURATE RIGHT OF WAY DATA, CONTACT RIGHT OF WAY ENGINEERING AT THE DISTRICT OFFICE.
- EXISTING UTILITY FACILITIES HAVE NOT BEEN PLOTTED ON THESE PLANS.

LEGEND:

- SLOPE PAVING (CONCRETE)
- 4" SHOTCRETE
- MAINTENANCE VEHICLE PULLOUT
- MULCH
- ROCK BLANKET
- DIRECTION OF TRAFFIC
- WWM WELDED WIRE MESH
- EROSION CONTROL (HYDROSEED)

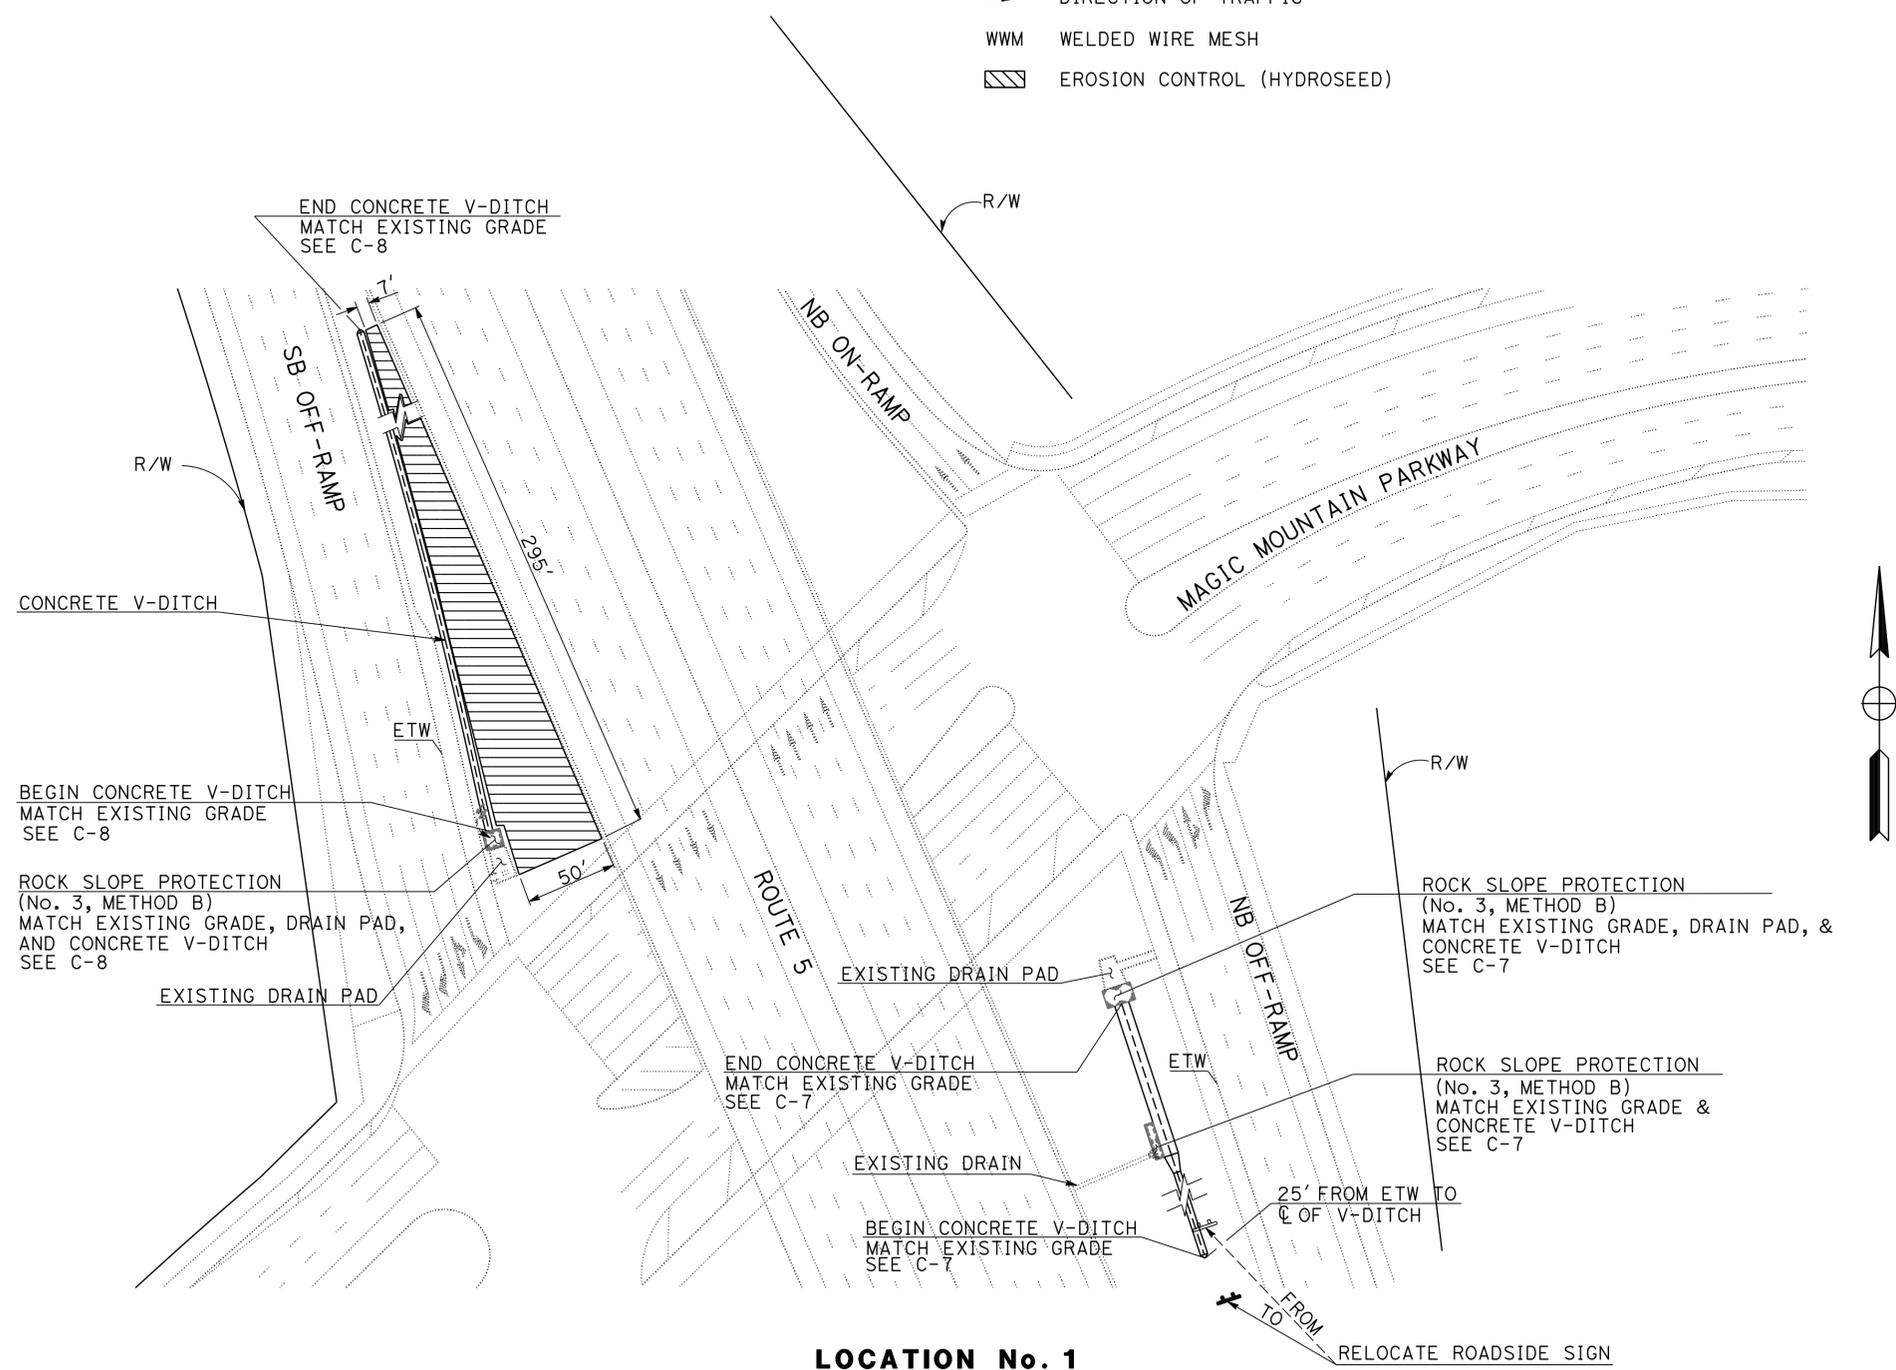

LOCATION No. 1

ON ROUTE 5 AT MAGIC MOUNTAIN PARKWAY OFF-RAMPS
PM 53.60

LAYOUT
SCALE: 1" = 50'

L-1

STATE OF CALIFORNIA - DEPARTMENT OF TRANSPORTATION	FUNCTIONAL SUPERVISOR	DESIGNED BY	REVISOR
Caltrans OFFICE OF DESIGN D	KAREN FONG	MOHAMMAD MOHSENZADEH	MOHAMMAD MOHSENZADEH
		CHECKED BY	DATE
		REFUGIO DOMINGUEZ	REFUGIO DOMINGUEZ

Dist	COUNTY	ROUTE	POST MILES TOTAL PROJECT	SHEET No.	TOTAL SHEETS
07	LA	5,10,14,47,60,etc.	Var	3	72

<i>Refugio Dominguez</i>	8/30/12
REGISTERED CIVIL ENGINEER	DATE
10-22-12	
PLANS APPROVAL DATE	


REGISTERED PROFESSIONAL ENGINEER	REFUGIO DOMINGUEZ
No. 50820	EXP. 9/30/13
CIVIL	STATE OF CALIFORNIA

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STATE OF CALIFORNIA - DEPARTMENT OF TRANSPORTATION	FUNCTIONAL SUPERVISOR	CALCULATED-DESIGNED BY	REVISED BY
Caltrans OFFICE OF DESIGN D	KAREN FONG	CHECKED BY	DATE REVISED
		MOHAMMAD MOHSENZADEH	
		REFUGIO DOMINGUEZ	



LOCATION No. 2
ON ROUTE 5 AT ROUTE 126 SEPARATION
PM 56.30

LAYOUT
SCALE: 1" = 50'

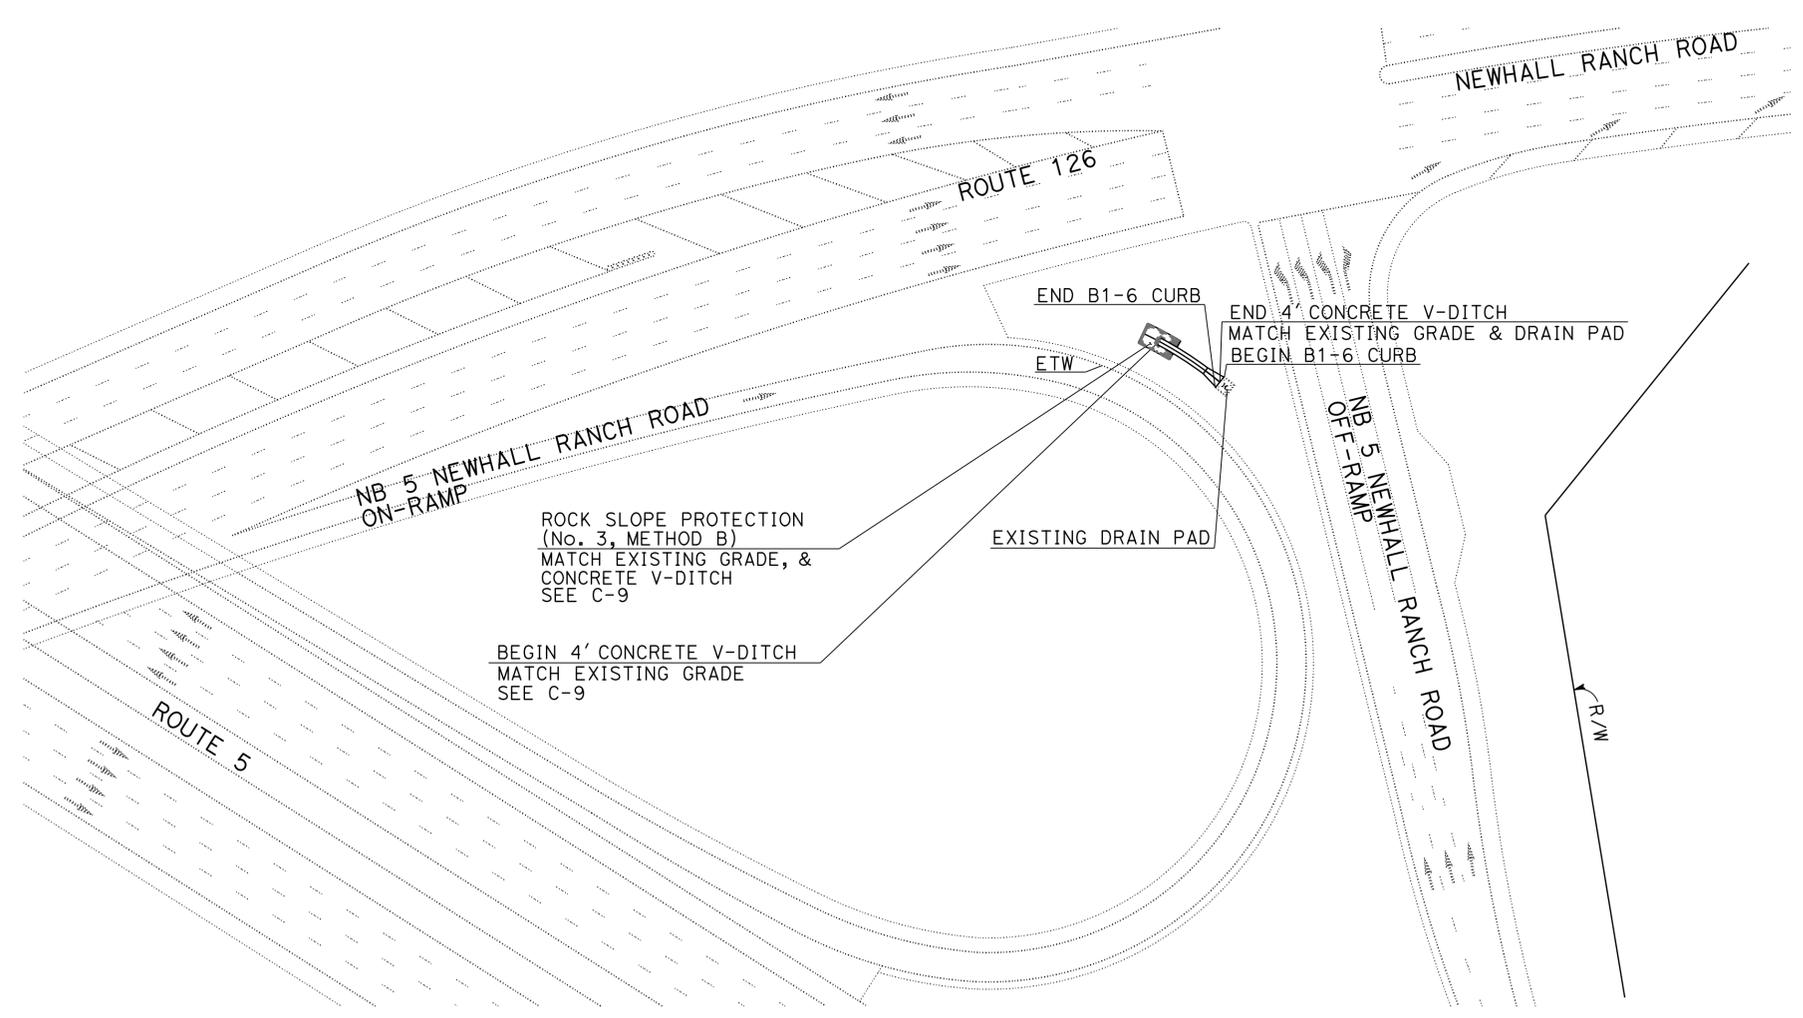L-2

Dist	COUNTY	ROUTE	POST MILES TOTAL PROJECT	SHEET No.	TOTAL SHEETS
07	LA	5,10,14, 47,60,etc.	Var	4	72

Refugio Dominguez 8/30/12
 REGISTERED CIVIL ENGINEER DATE
 10-22-12
 PLANS APPROVAL DATE


REGISTERED PROFESSIONAL ENGINEER
 REFUGIO DOMINGUEZ
 No. 50820
 Exp. 9/30/13
 CIVIL
 STATE OF CALIFORNIA

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NOTES:

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MOHAMMAD MOHSENZADEH	REVISOR
REFUGIO DOMINGUEZ	DATE
CALCULATED-DESIGNED BY	CHECKED BY
FUNCTIONAL SUPERVISOR	
STATE OF CALIFORNIA - DEPARTMENT OF TRANSPORTATION	
Caltrans OFFICE OF DESIGN D	



LOCATION No. 3
 ON WB 10 AT EASTERN Ave OFF-RAMP
 PM 21.40

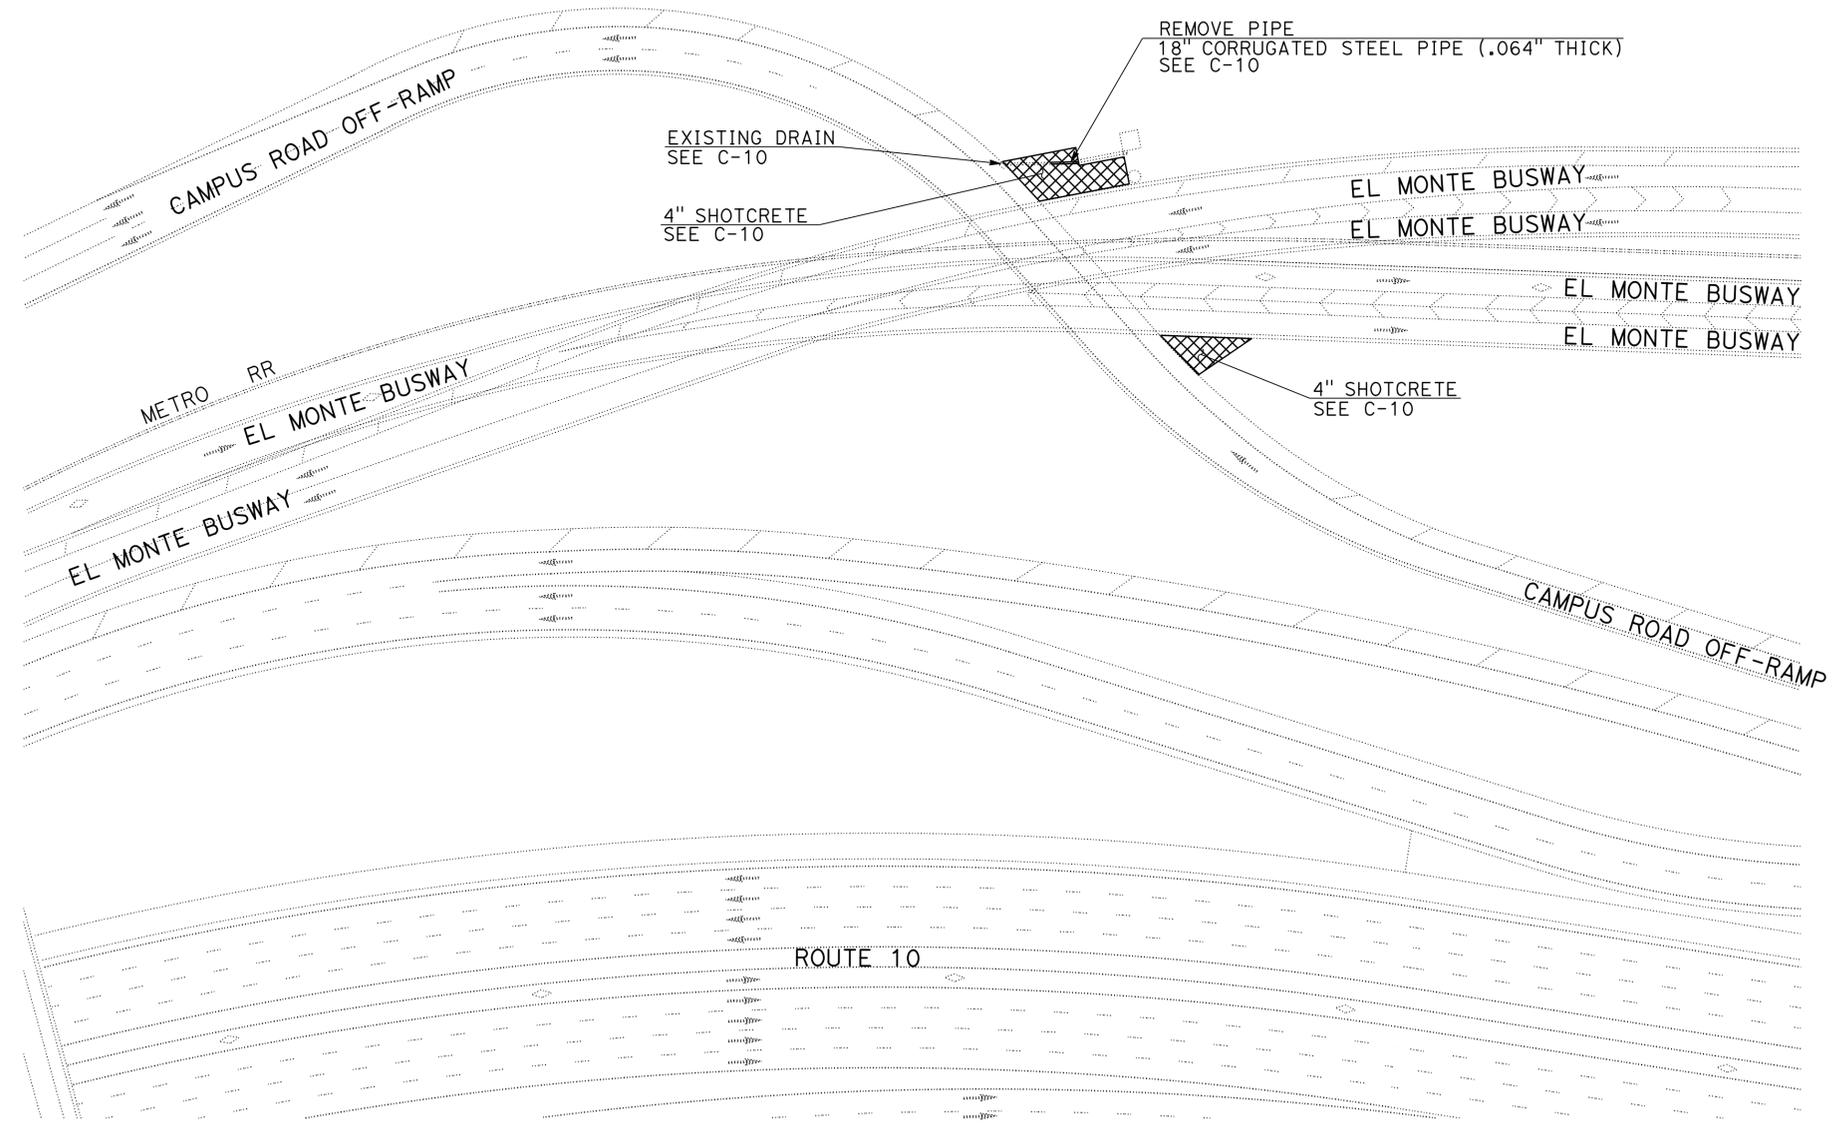LAYOUT
 SCALE: 1" = 50'



L-3

Dist	COUNTY	ROUTE	POST MILES TOTAL PROJECT	SHEET No.	TOTAL SHEETS
07	LA	5,10,14, 47,60,etc.	Var	5	72
Refugio Dominguez REGISTERED CIVIL ENGINEER			8/30/12	DATE	
10-22-12				PLANS APPROVAL DATE	
THE STATE OF CALIFORNIA OR ITS OFFICERS OR AGENTS SHALL NOT BE RESPONSIBLE FOR THE ACCURACY OR COMPLETENESS OF SCANNED COPIES OF THIS PLAN SHEET.					




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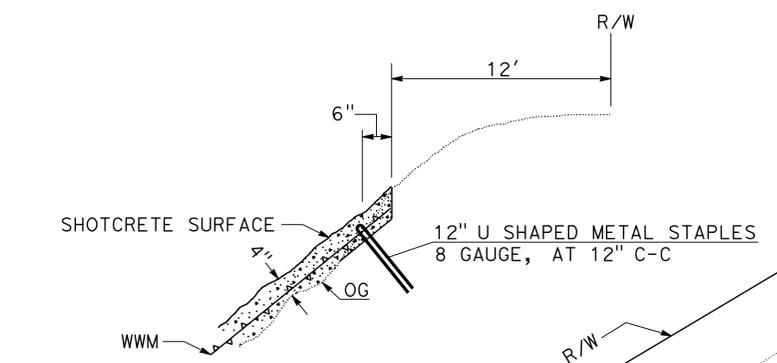
1. FOR ACCURATE RIGHT OF WAY DATA, CONTACT RIGHT OF WAY ENGINEERING AT THE DISTRICT OFFICE.
2. EXISTING UTILITY FACILITIES HAVE NOT BEEN PLOTTED ON THESE PLANS.
3. NAILS MAY BE SPLAYED TO AVOID UNDERGROUND OBSTRUCTIONS. MAINTAIN A MINIMUM 3' CLEARANCE BETWEEN NAIL TIPS.

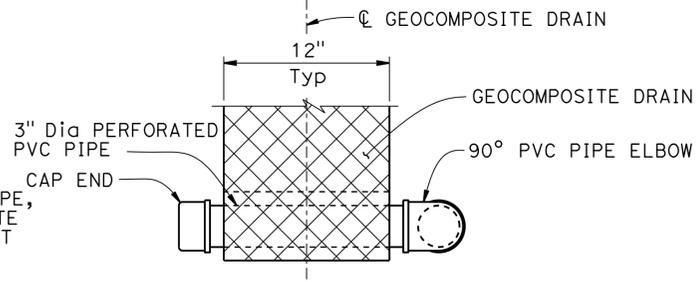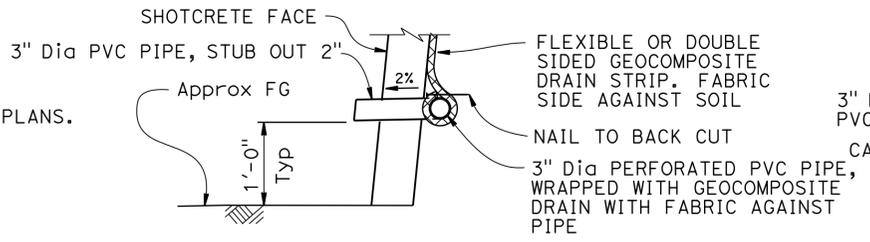


DRAINAGE DETAILS
NO SCALE

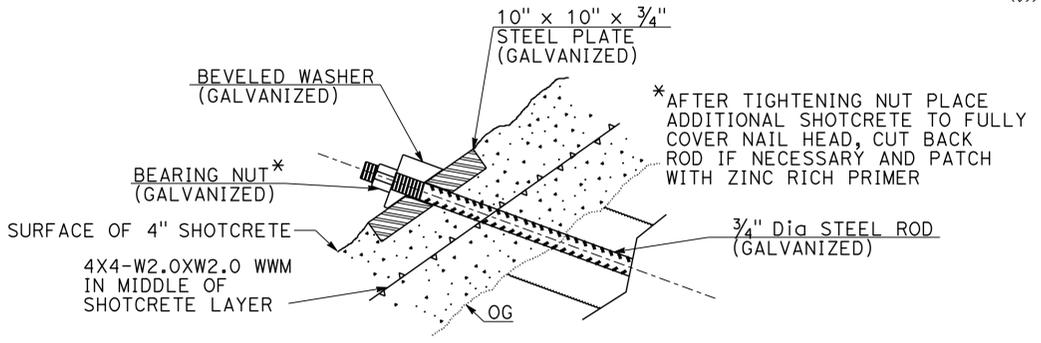


DETAIL 1
NO SCALE




DETAIL 2
NO SCALE

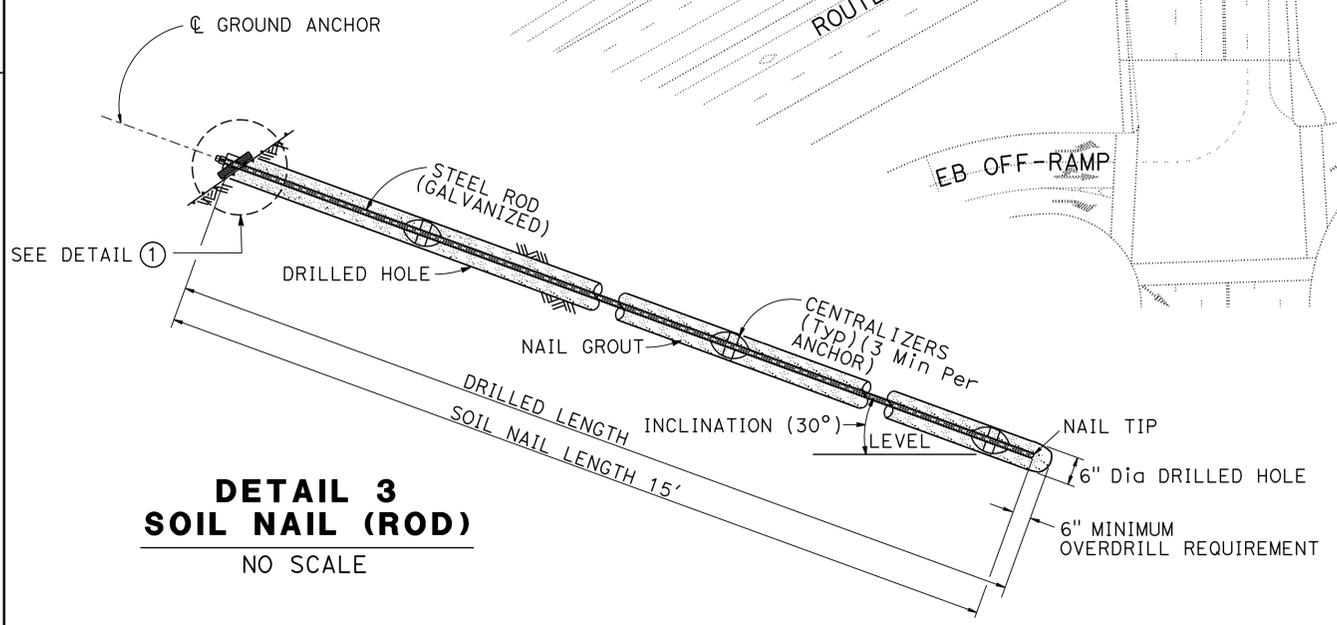

DETAIL 3 SOIL NAIL (ROD)
NO SCALE

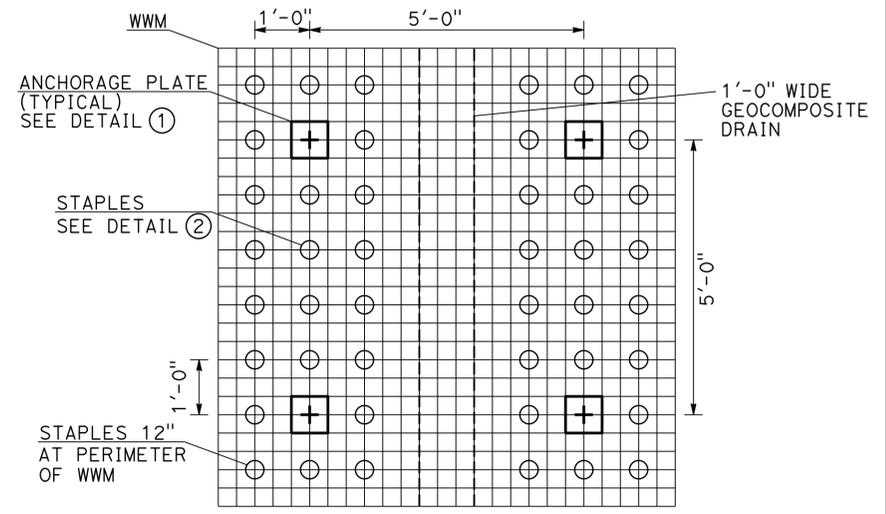

TYPICAL STAPLE, NAIL, AND DRAINAGE LAYOUT
NO SCALE

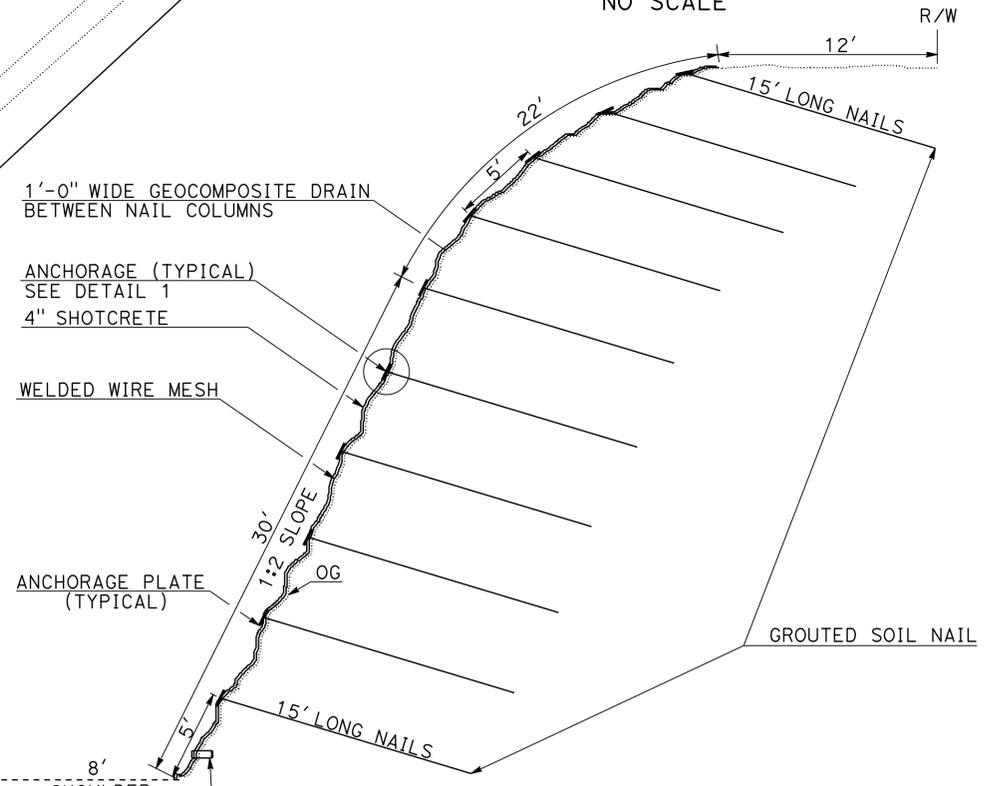

SECTION A-A
NO SCALE

LOCATION No. 4
ON SB ROUTE 14 AT SAND CANYON ROAD ON-RAMP
PM 33.40

LAYOUT
SCALE: 1" = 50'

STATE OF CALIFORNIA - DEPARTMENT OF TRANSPORTATION - OFFICE OF DESIGN D

FUNCTIONAL SUPERVISOR
KAREN FONG

CALCULATED/DESIGNED BY
CHECKED BY

MOHAMMAD MOHSENZADEH
REFUGIO DOMINGUEZ

REVISED BY
DATE REVISED

Dist	COUNTY	ROUTE	POST MILES TOTAL PROJECT	SHEET No.	TOTAL SHEETS
07	LA	5,10,14, 47,60,etc.	Var	6	72

<i>Refugio Dominguez</i>	8/30/12
REGISTERED CIVIL ENGINEER	DATE
10-22-12	
PLANS APPROVAL DATE	


REGISTERED PROFESSIONAL ENGINEER
REFUGIO DOMINGUEZ
No. 50820
Exp. 9/30/13
CIVIL
STATE OF CALIFORNIA

THE STATE OF CALIFORNIA OR ITS OFFICERS OR AGENTS SHALL NOT BE RESPONSIBLE FOR THE ACCURACY OR COMPLETENESS OF SCANNED COPIES OF THIS PLAN SHEET.

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STATE OF CALIFORNIA - DEPARTMENT OF TRANSPORTATION	FUNCTIONAL SUPERVISOR	CALCULATED-DESIGNED BY	REVISOR
Caltrans OFFICE OF DESIGN D	KAREN FONG	CHECKED BY	DATE
		MOHAMMAD MOHSENZADEH	REFUGIO DOMINGUEZ



LOCATION No. 5
ON SB ROUTE 47 AT HARBOR Blvd OFF-RAMP
PM 0.30

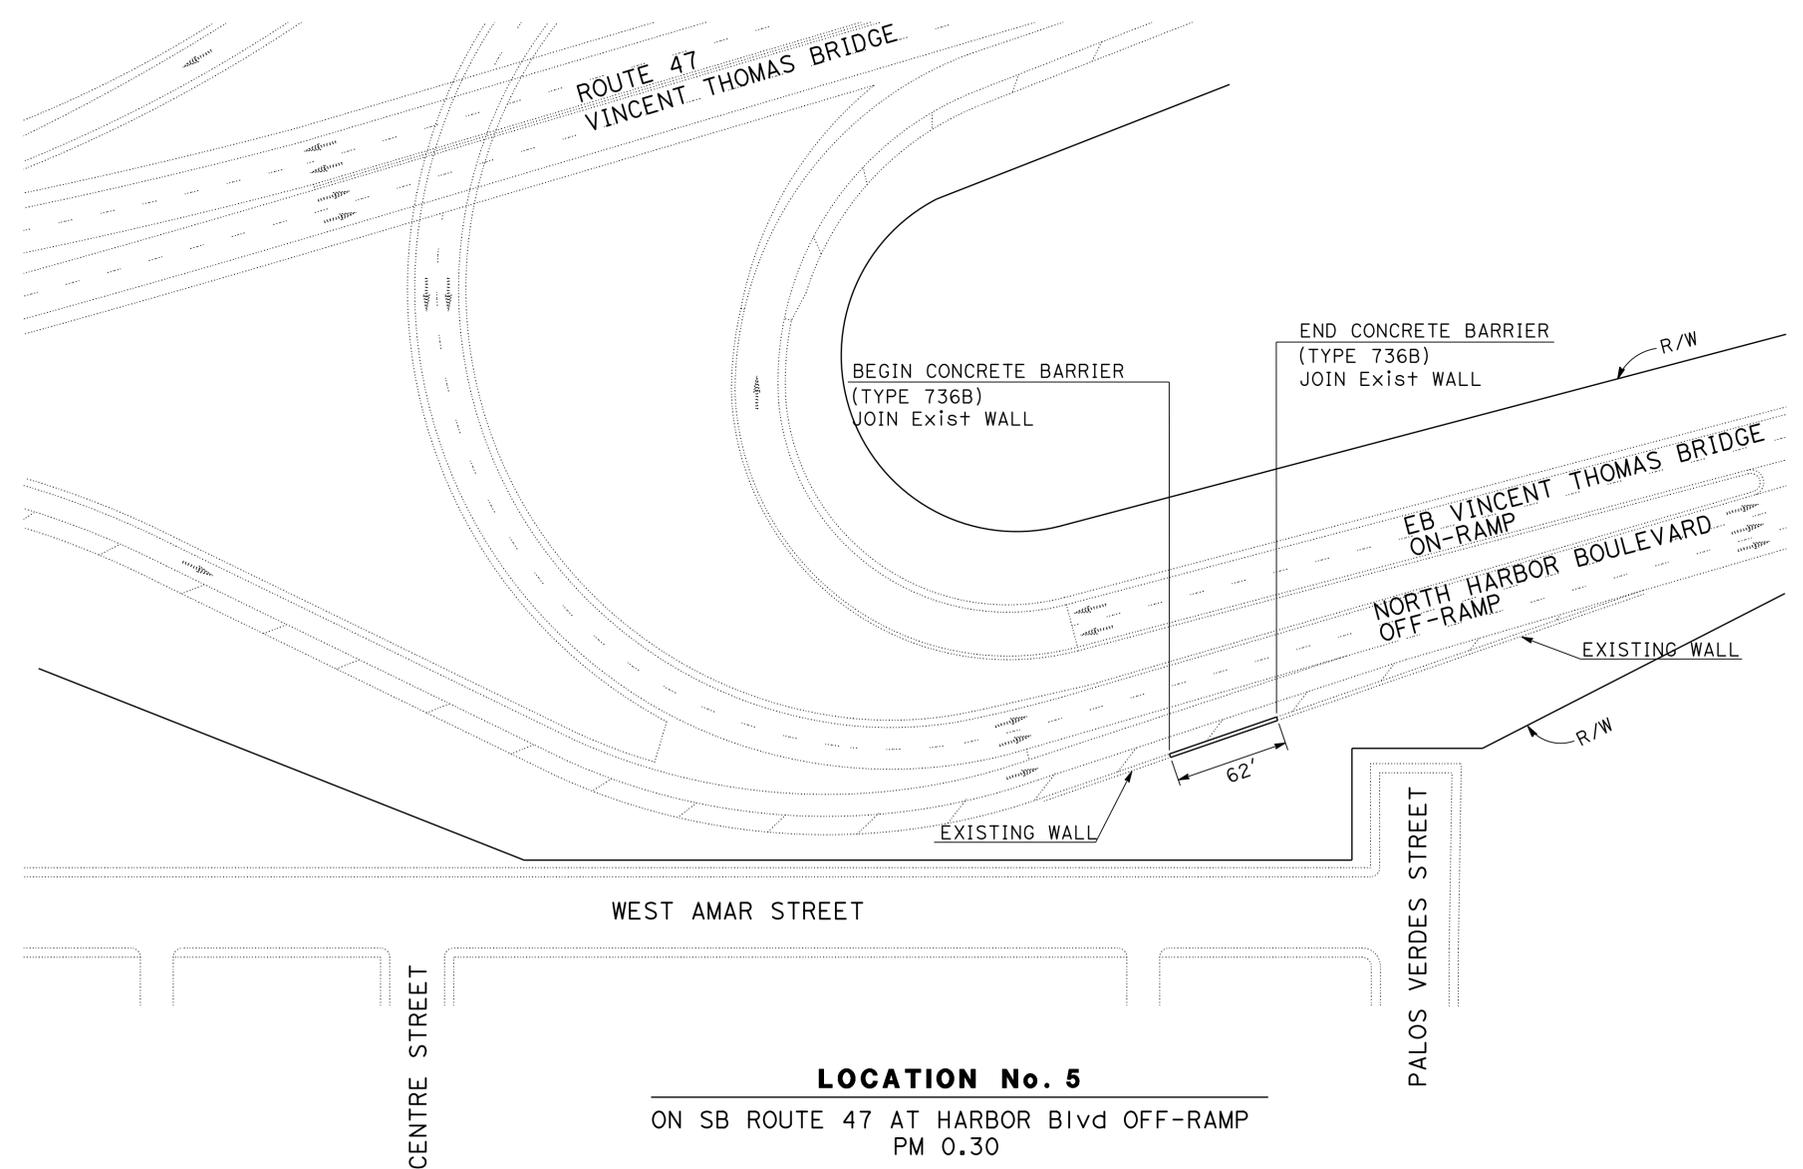LAYOUT
SCALE: 1" = 50'


L-5

Dist	COUNTY	ROUTE	POST MILES TOTAL PROJECT	SHEET No.	TOTAL SHEETS
07	LA	5,10,14, 47,60,etc.	Var	7	72
<i>Refugio Dominguez</i> REGISTERED CIVIL ENGINEER			8/30/12	DATE	
10-22-12 PLANS APPROVAL DATE					
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LOCATION No. 6


PARK & RIDE AREA BETWEEN NB ROUTE 57 AND WB ROUTE 60
PM 25.60

LAYOUT
SCALE: 1" = 50'

L-6

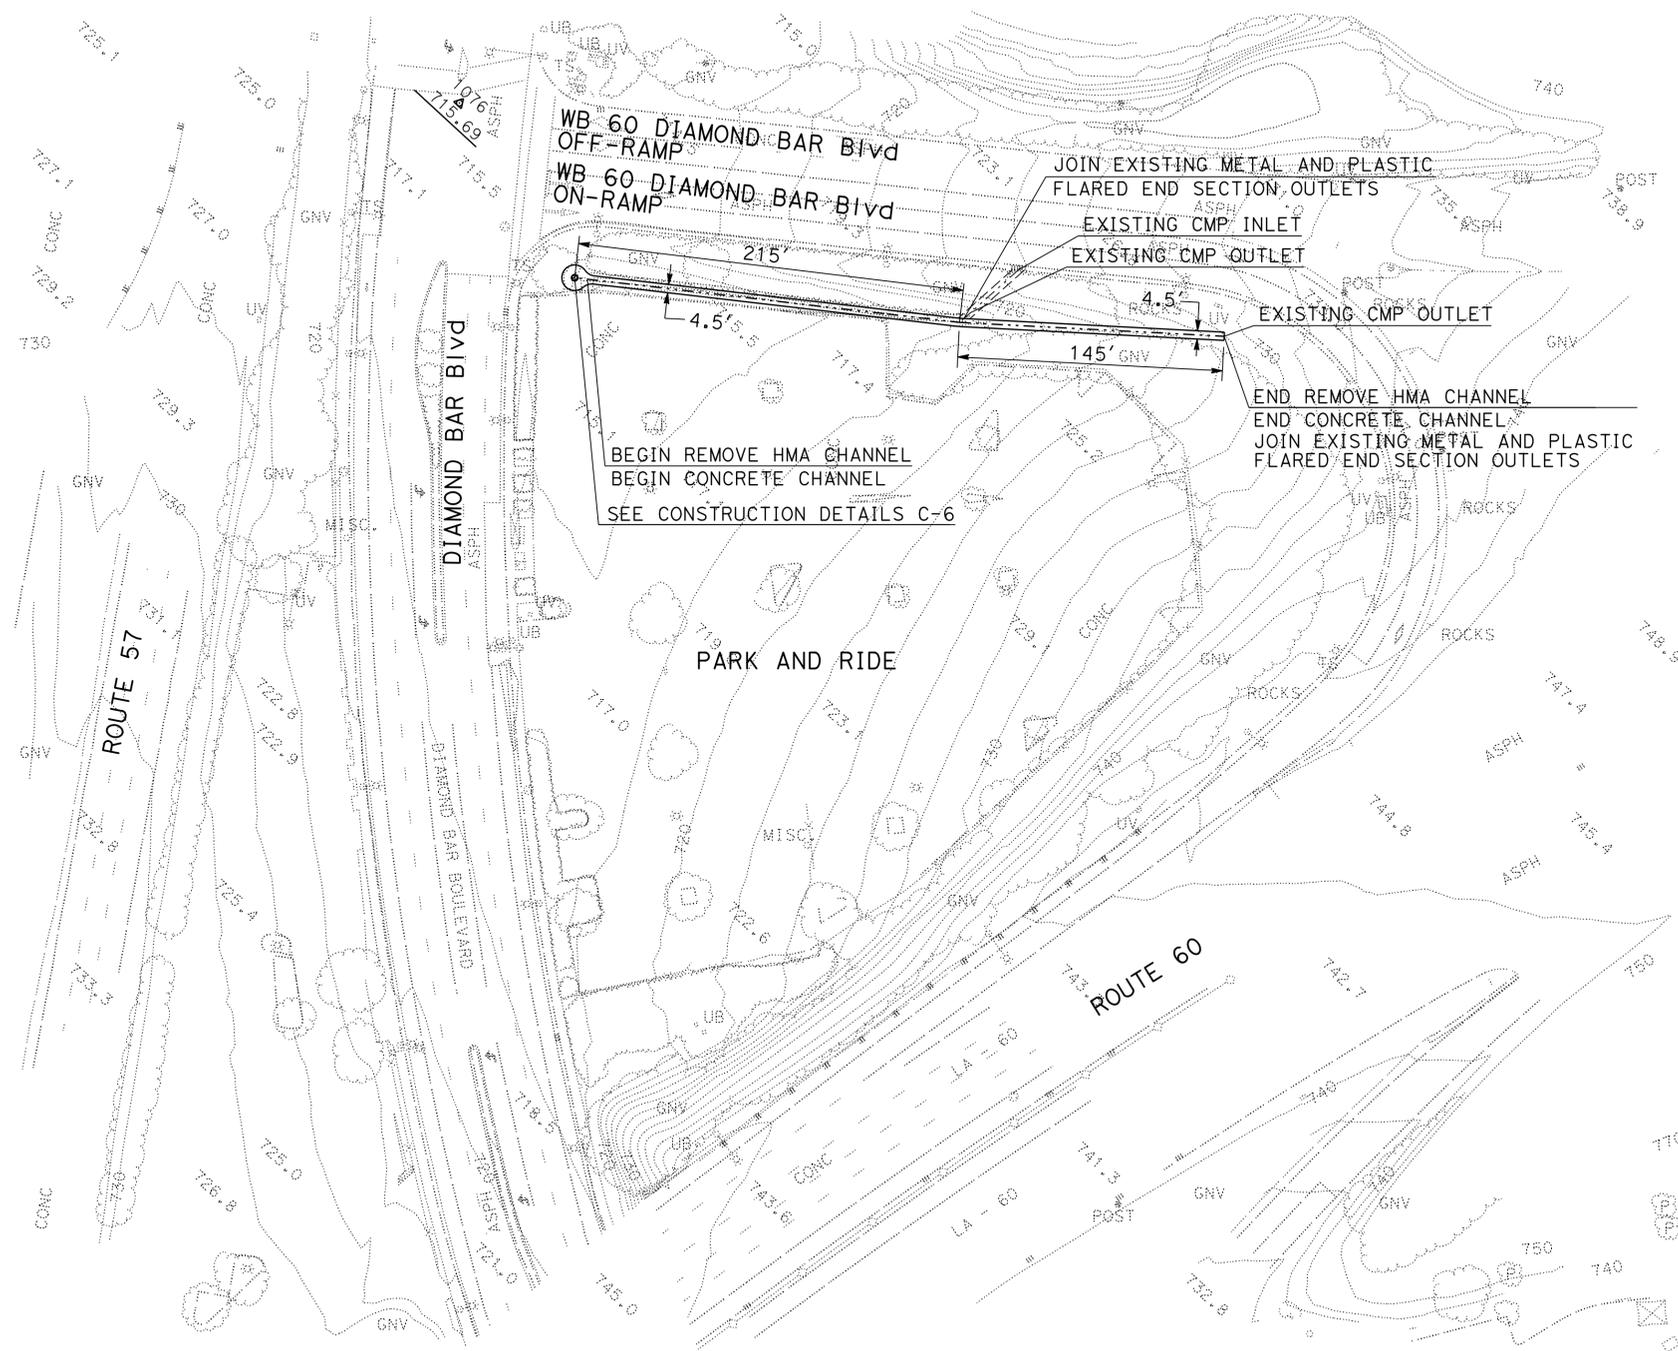
STATE OF CALIFORNIA - DEPARTMENT OF TRANSPORTATION	FUNCTIONAL SUPERVISOR	CALCULATED-DESIGNED BY	REVISOR
Caltrans OFFICE OF DESIGN D	KAREN FONG	CHECKED BY	DATE
		MOHAMMAD MOHSENZADEH	REFUGIO DOMINGUEZ

Dist	COUNTY	ROUTE	POST MILES TOTAL PROJECT	SHEET No.	TOTAL SHEETS
07	LA	5,10,14, 47,60,etc.	Var	8	72
<i>Refugio Dominguez</i> REGISTERED CIVIL ENGINEER			8/30/12	DATE	
10-22-12 PLANS APPROVAL DATE					
THE STATE OF CALIFORNIA OR ITS OFFICERS OR AGENTS SHALL NOT BE RESPONSIBLE FOR THE ACCURACY OR COMPLETENESS OF SCANNED COPIES OF THIS PLAN SHEET.					

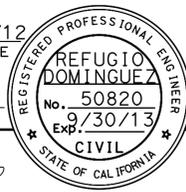


NOTES:


- FOR ACCURATE RIGHT OF WAY DATA, CONTACT RIGHT OF WAY ENGINEERING AT THE DISTRICT OFFICE.
- EXISTING UTILITY FACILITIES HAVE NOT BEEN PLOTTED ON THESE PLANS.

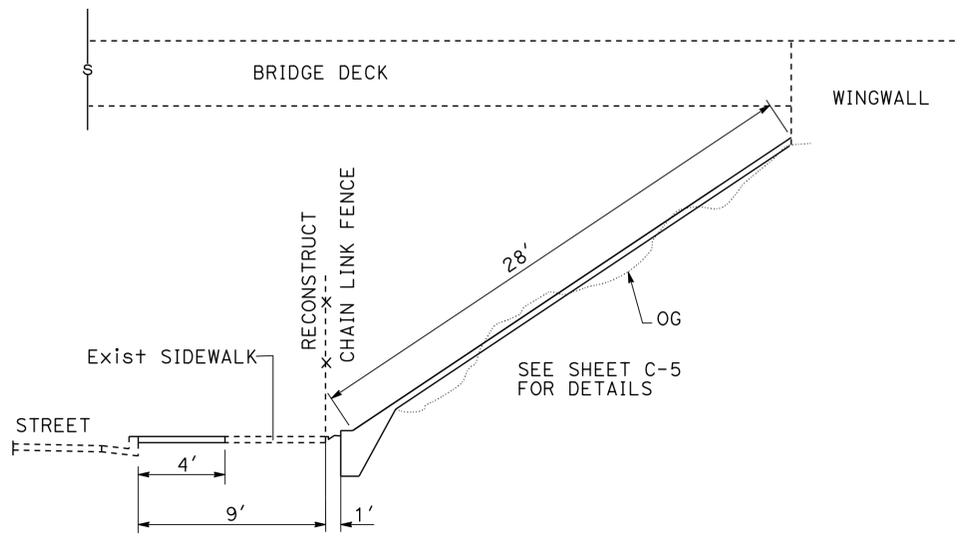

SECTION A-A
NO SCALE

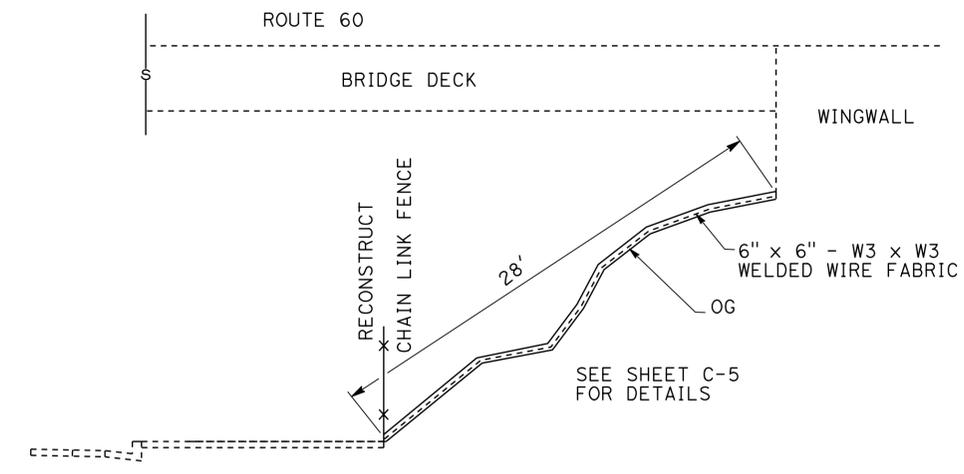

SECTION B-B
NO SCALE

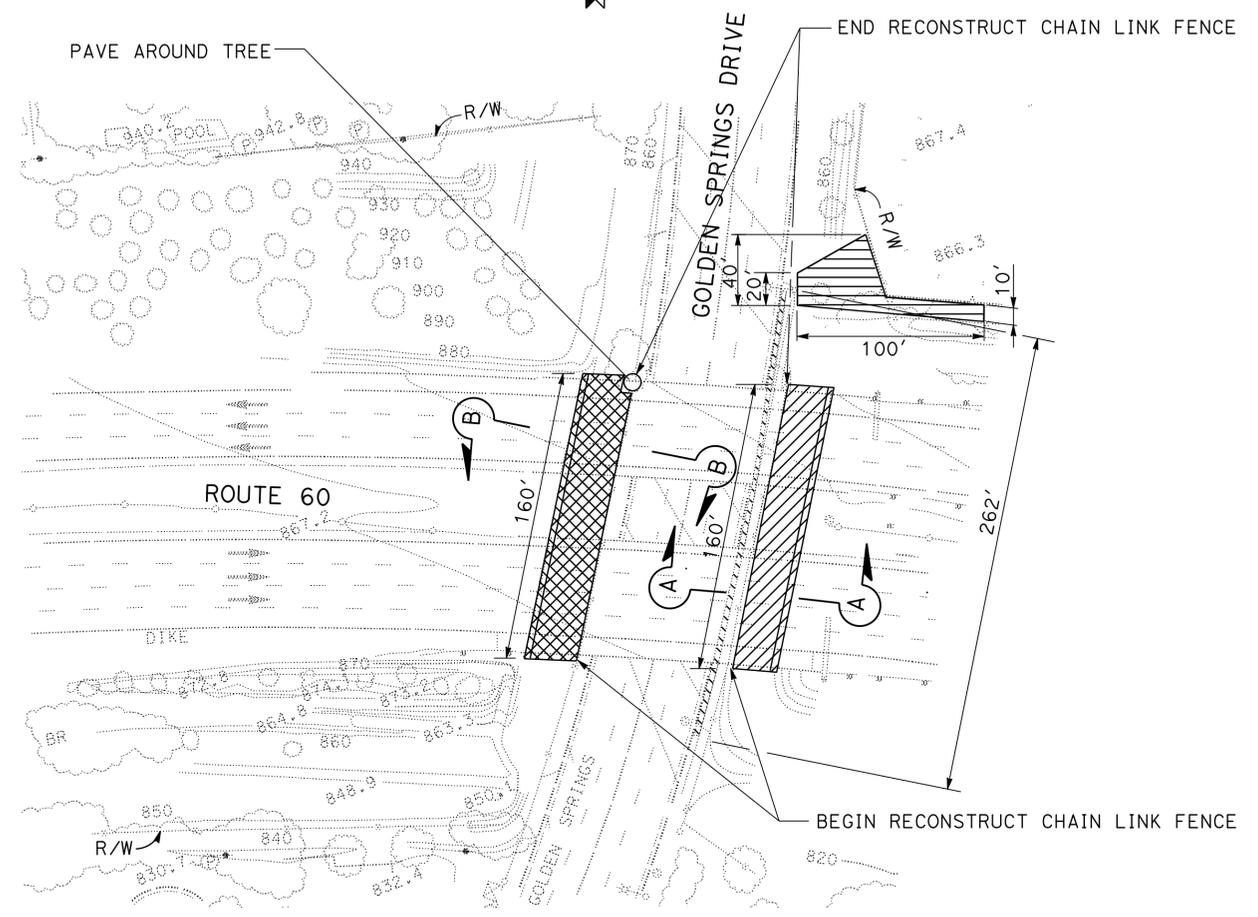

LOCATION No. 7
ON ROUTE 60 AT GOLDEN SPRINGS DRIVE
PM 26.53

LAYOUT
SCALE: 1" = 50'

STATE OF CALIFORNIA - DEPARTMENT OF TRANSPORTATION	FUNCTIONAL SUPERVISOR	REVISOR	DATE
Caltrans OFFICE OF DESIGN D	KAREN FONG	NARENDRA DESAI	
		REFUGIO DOMINGUEZ	


NOTES:

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2. EXISTING UTILITY FACILITIES HAVE NOT BEEN PLOTTED ON THESE PLANS.

Dist	COUNTY	ROUTE	POST MILES TOTAL PROJECT	SHEET No.	TOTAL SHEETS
07	LA	5,10,14, 47,60,etc.	Var	9	72

<i>Refugio Dominguez</i>	8/30/12
REGISTERED CIVIL ENGINEER	DATE
10-22-12	
PLANS APPROVAL DATE	

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LOCATION No. 8

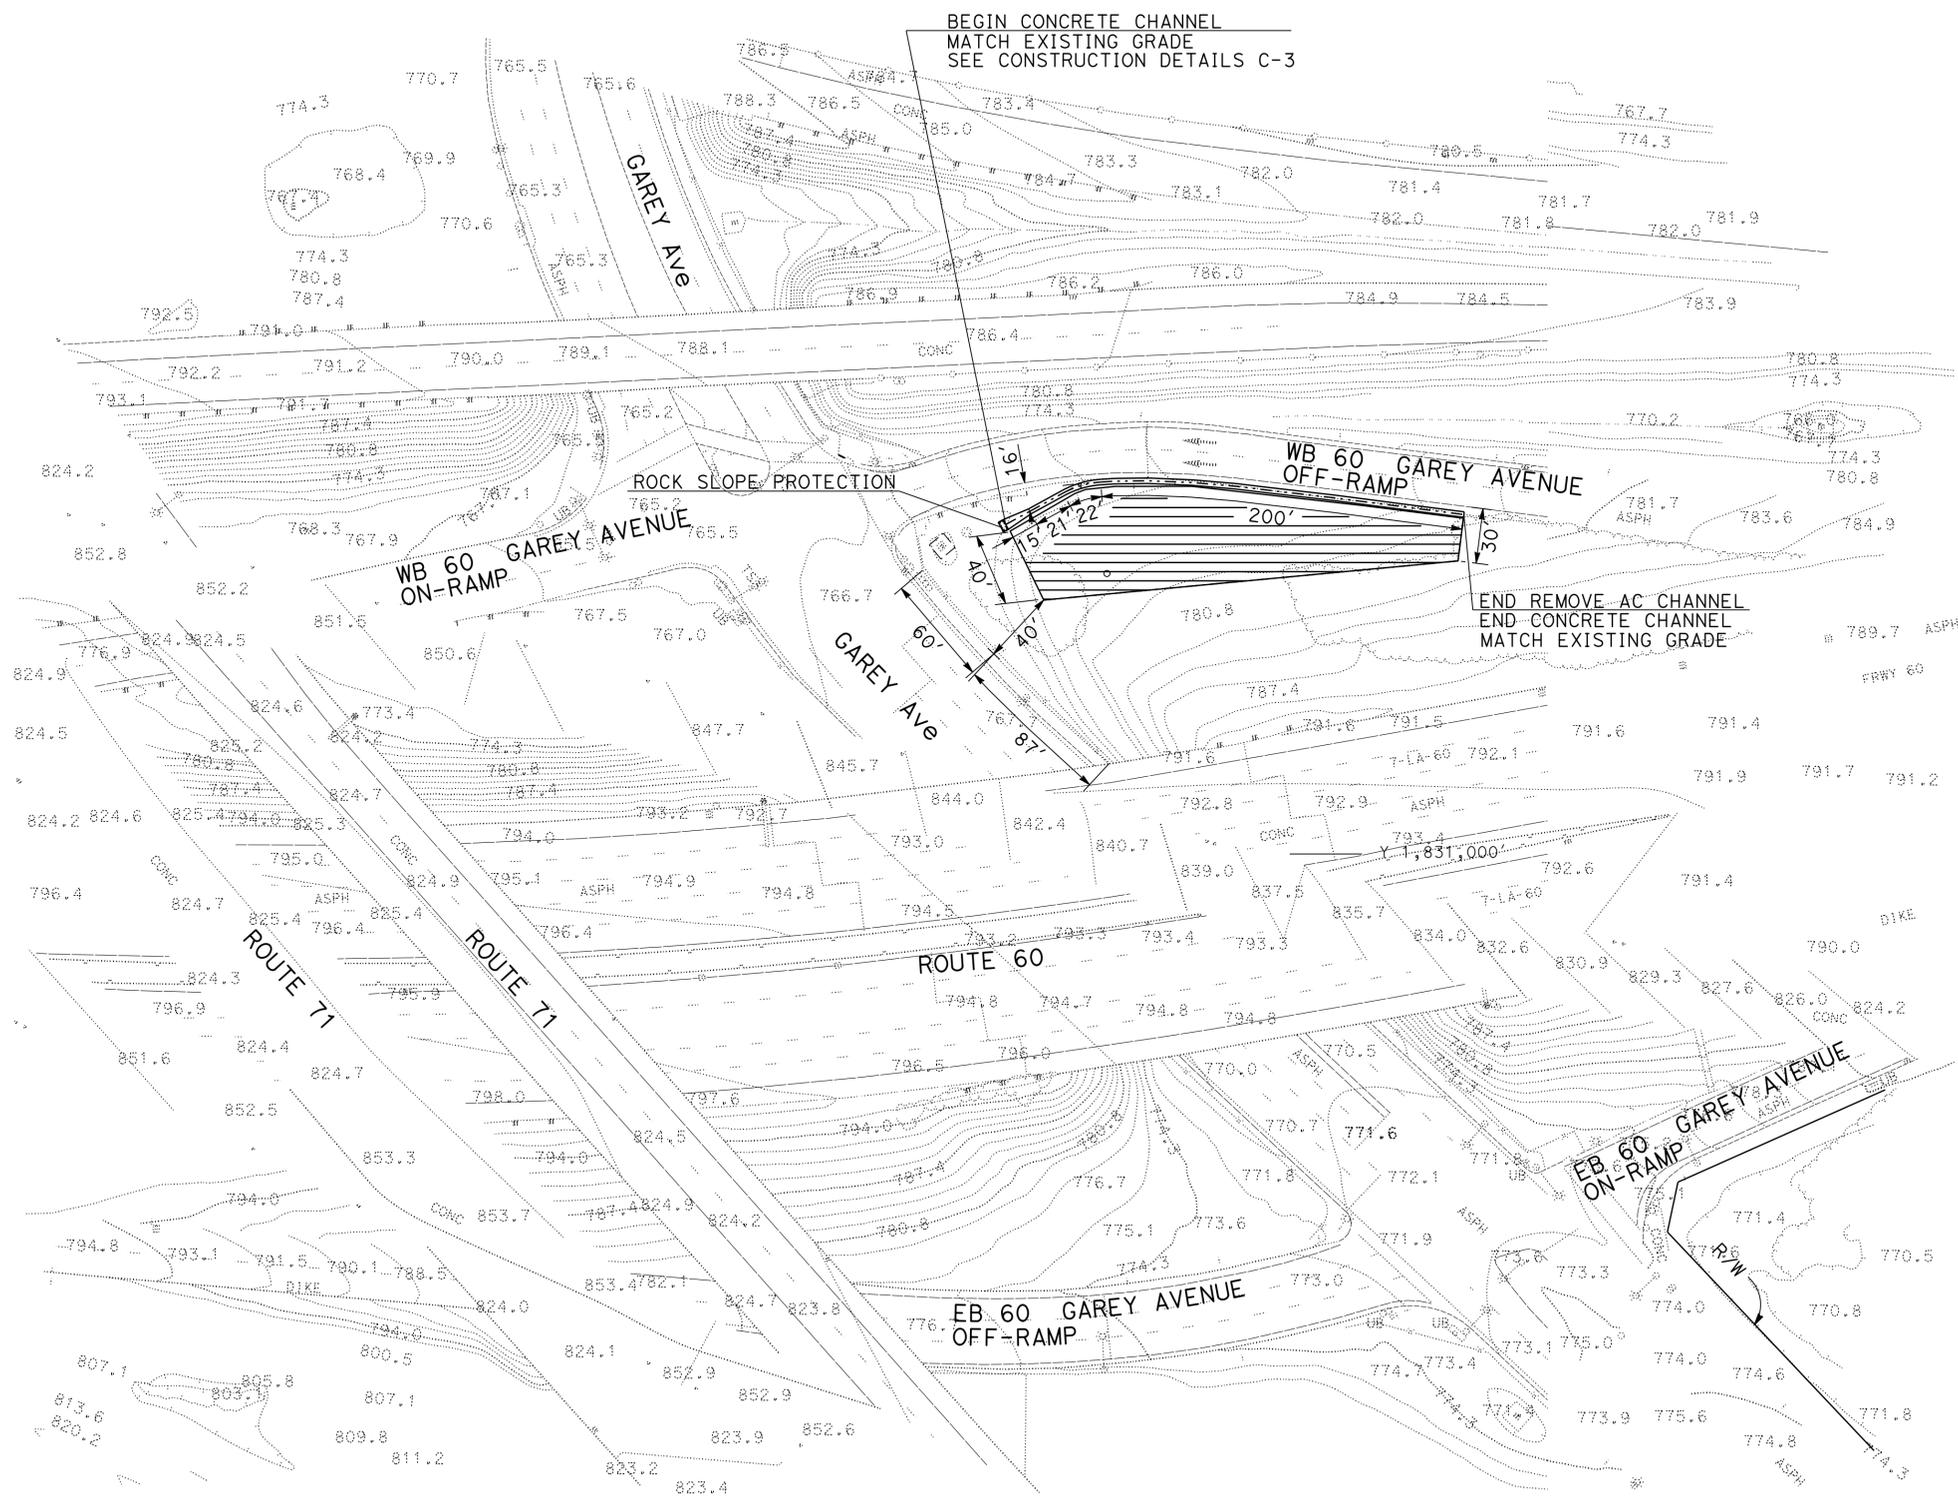ON WB ROUTE 60 AT GAREY Ave OFF-RAMP
PM 29.20

LAYOUT
SCALE: 1" = 50'

STATE OF CALIFORNIA - DEPARTMENT OF TRANSPORTATION	OFFICE OF DESIGN D
FUNCTIONAL SUPERVISOR	KAREN FONG
CALCULATED-DESIGNED BY	CHECKED BY
MOHAMMAD MOHSENZADEH	REFUGIO DOMINGUEZ
REVISED BY	DATE REVISED

NOTES:

1. FOR ACCURATE RIGHT OF WAY DATA, CONTACT RIGHT OF WAY ENGINEERING AT THE DISTRICT OFFICE.
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Dist	COUNTY	ROUTE	POST MILES TOTAL PROJECT	SHEET No.	TOTAL SHEETS
07	LA	5,10,14,47,60,etc.	Var	10	72


REGISTERED CIVIL ENGINEER **Refugio Dominguez** No. 50820
 DATE 8-30-12
 PLANS APPROVAL DATE 10-22-12
 EXP. 9/30/13
 CIVIL
 STATE OF CALIFORNIA

THE STATE OF CALIFORNIA OR ITS OFFICERS OR AGENTS SHALL NOT BE RESPONSIBLE FOR THE ACCURACY OR COMPLETENESS OF SCANNED COPIES OF THIS PLAN SHEET.



CURVE DATA

No.	R	Δ	T	L
1	500.00'	25°48'10"	114.53'	225.17'

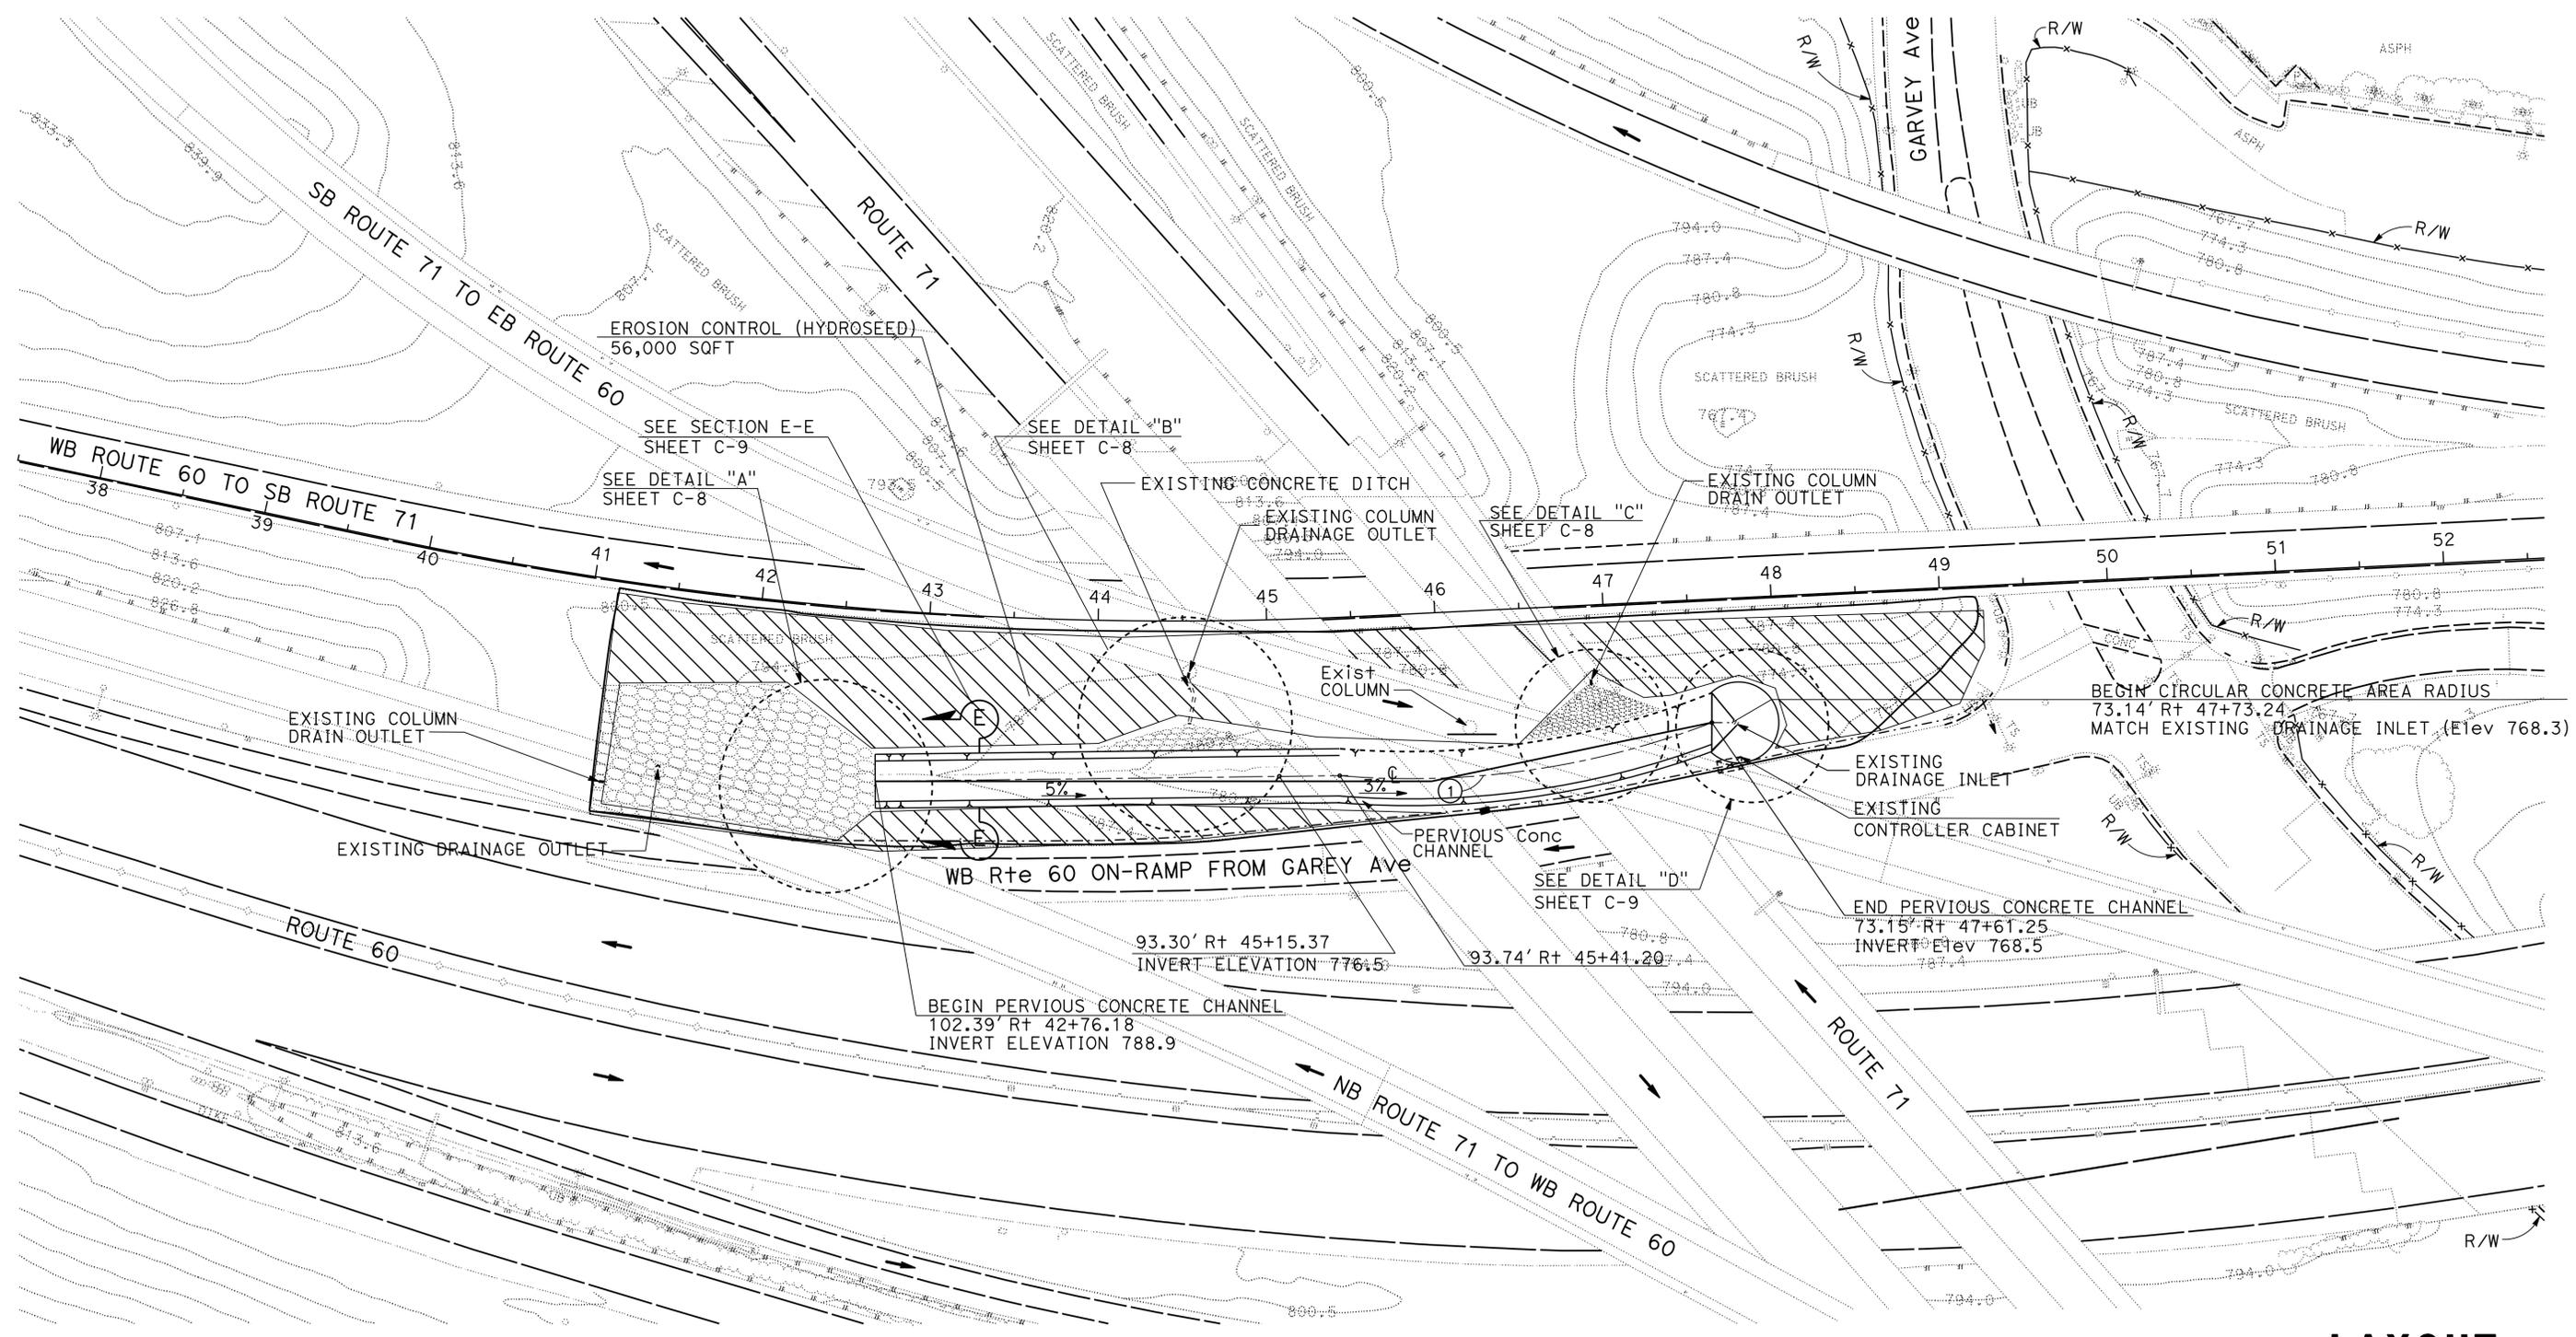

LOCATION No. 9
 BETWEEN THE WB ROUTE 60 ON-RAMP AND CONNECTOR RAMP TO
 EB ROUTE 71 AT GAREY Ave
 PM 30.40

LAYOUT
 SCALE: 1" = 50'

STATE OF CALIFORNIA - DEPARTMENT OF TRANSPORTATION
Caltrans OFFICE OF DESIGN D
 FUNCTIONAL SUPERVISOR: KAREN FONG
 CALCULATED/DESIGNED BY: NGUYEN HUA
 CHECKED BY: REFUGIO DOMINGUEZ
 REVISED BY: NGUYEN HUA
 DATE REVISED: REFUGIO DOMINGUEZ

LAST REVISION: DATE PLOTTED => 02-JAN-2013
 00-00-00 TIME PLOTTED => 19:23

Dist	COUNTY	ROUTE	POST MILES TOTAL PROJECT	SHEET No.	TOTAL SHEETS
07	LA	5,10,14, 47,60,etc.	Var	11	72



<i>Refugio Dominguez</i>	8/30/12
REGISTERED CIVIL ENGINEER	DATE
10-22-12	
PLANS APPROVAL DATE	

REGISTERED PROFESSIONAL ENGINEER
REFUGIO DOMINGUEZ
No. 50820
Exp. 9/30/13
CIVIL
STATE OF CALIFORNIA

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LOCATION No. 10
ON SB ROUTE 110 AT MacARTHUR Ave OC
PM 0.30



LAYOUT
SCALE: 1" = 50'

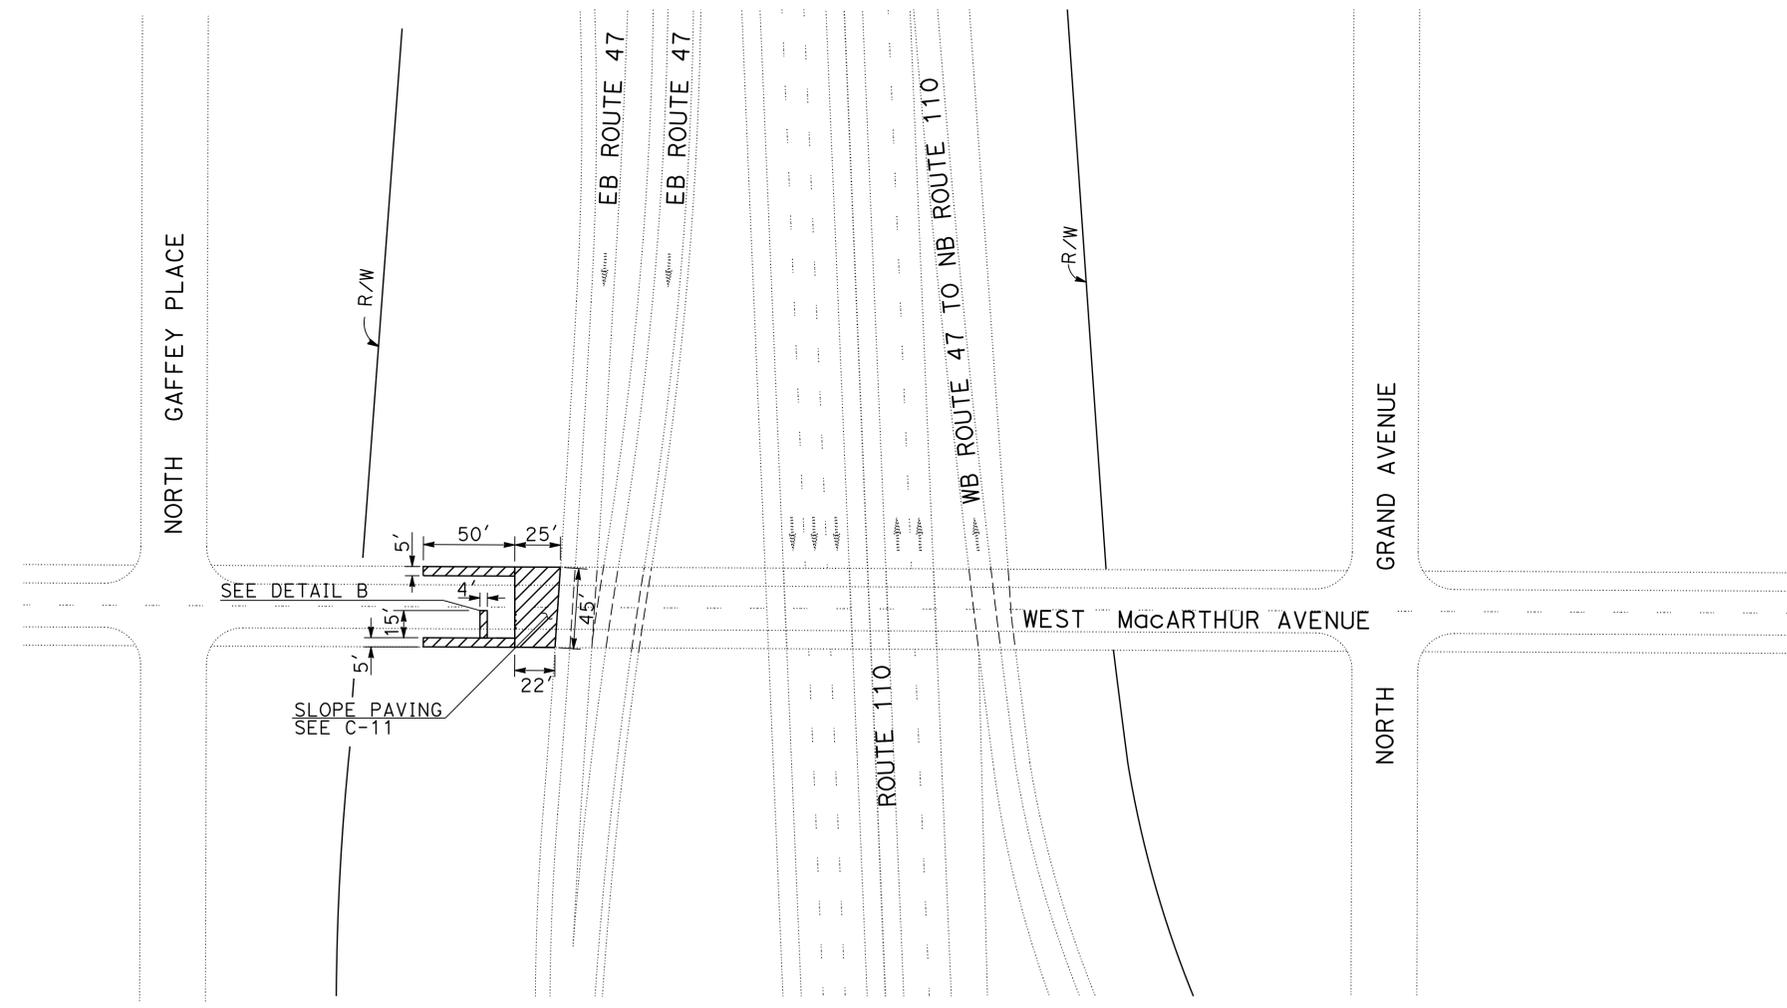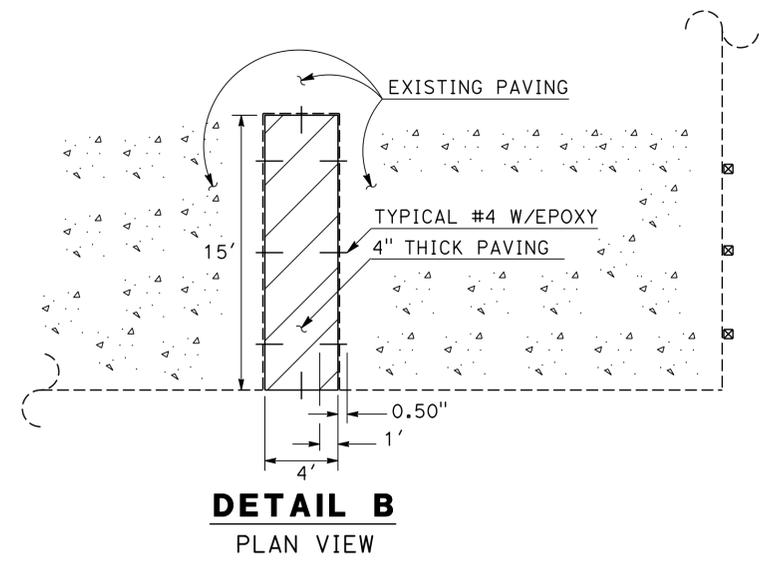L-10

STATE OF CALIFORNIA - DEPARTMENT OF TRANSPORTATION	FUNCTIONAL SUPERVISOR	CALCULATED-DESIGNED BY	REVISED BY
Caltrans OFFICE OF DESIGN D	KAREN FONG	CHECKED BY	DATE REVISED
		MOHAMMAD MOHSENZADEH	
		REFUGIO DOMINGUEZ	

STATE OF CALIFORNIA - DEPARTMENT OF TRANSPORTATION
Caltrans OFFICE OF DESIGN D

FUNCTIONAL SUPERVISOR: KAREN FONG
 CALCULATED/DESIGNED BY: NGUYEN HUA
 CHECKED BY: REFUGIO DOMINGUEZ
 REVISED BY: NGUYEN HUA
 DATE REVISED: REFUGIO DOMINGUEZ


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Dist	COUNTY	ROUTE	POST MILES TOTAL PROJECT	SHEET No.	TOTAL SHEETS
07	LA	5,10,14,47,60,etc.	Var	12	72

Refugio Dominguez 8/30/12
 REGISTERED CIVIL ENGINEER DATE
 10-22-12
 PLANS APPROVAL DATE
 THE STATE OF CALIFORNIA OR ITS OFFICERS OR AGENTS SHALL NOT BE RESPONSIBLE FOR THE ACCURACY OR COMPLETENESS OF SCANNED COPIES OF THIS PLAN SHEET.

REGISTERED PROFESSIONAL ENGINEER
REFUGIO DOMINGUEZ
 No. 50820
 Exp. 9/30/13
 CIVIL
 STATE OF CALIFORNIA



LOCATION No. 11
 ON ROUTE 110 AT ROUTE 405 SEPARATION
 PM 8.80

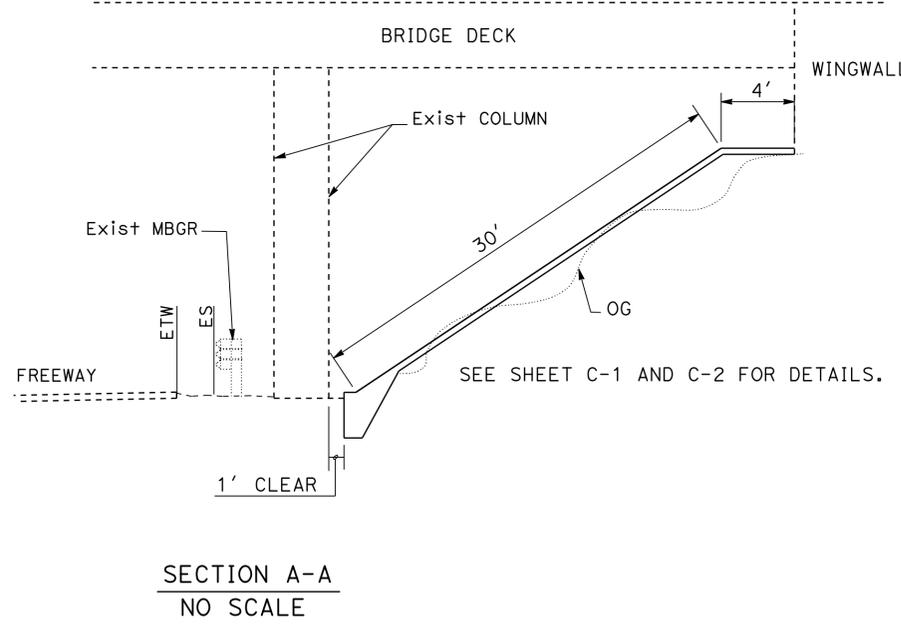LAYOUT
 SCALE: 1" = 50'

Dist	COUNTY	ROUTE	POST MILES TOTAL PROJECT	SHEET No.	TOTAL SHEETS
07	LA	5,10,14, 47,60,etc.	Var	13	72


<i>Refugio Dominguez</i>	8/30/12
REGISTERED CIVIL ENGINEER	DATE
10-22-12	
PLANS APPROVAL DATE	

REGISTERED PROFESSIONAL ENGINEER
REFUGIO DOMINGUEZ
No. 50820
Exp. 9/30/13
CIVIL
STATE OF CALIFORNIA

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LOCATION No. 12
ON EB ROUTE 134 AT ARROYO SECO SEPARATION
PM 12.60

LAYOUT
SCALE: 1" = 50'


L-12

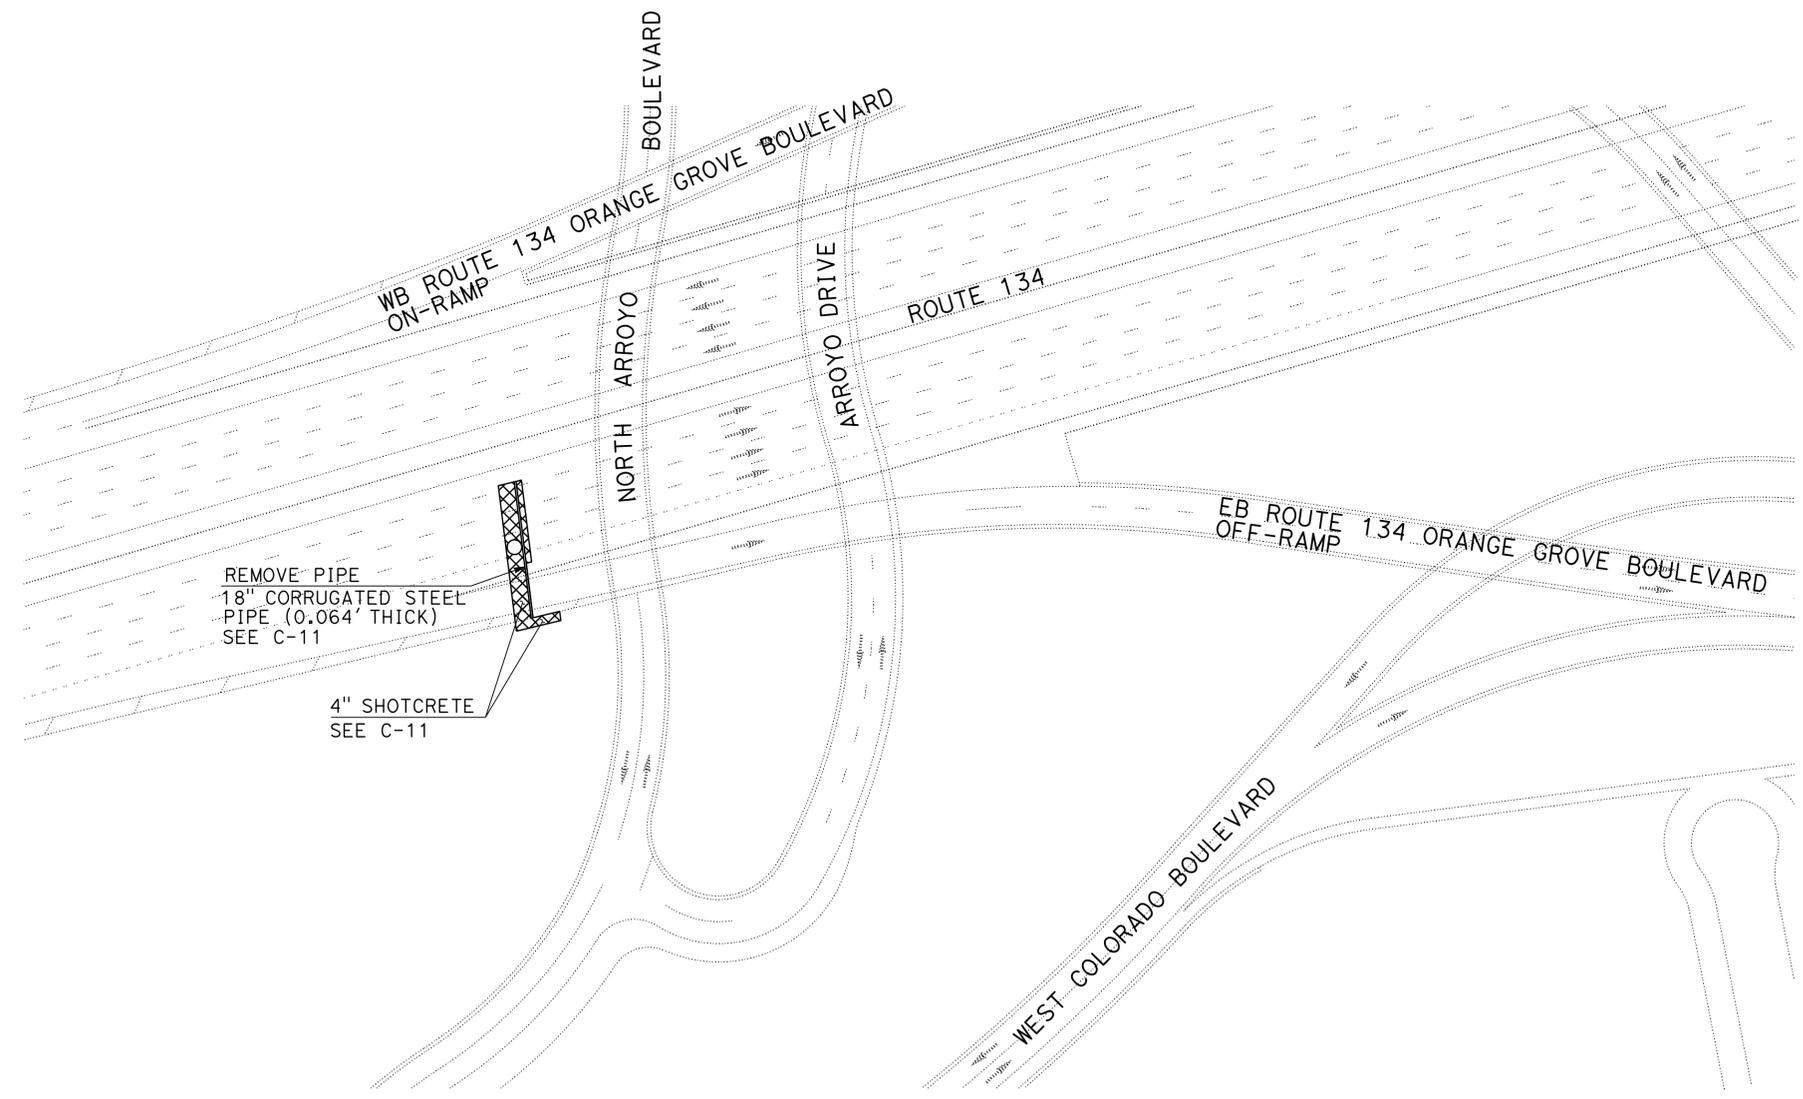STATE OF CALIFORNIA - DEPARTMENT OF TRANSPORTATION	FUNCTIONAL SUPERVISOR	CALCULATED-DESIGNED BY	REVISOR
Caltrans OFFICE OF DESIGN D	KAREN FONG	CHECKED BY	DATE
		MOHAMMAD MOHSENZADEH	REFUGIO DOMINGUEZ

Dist	COUNTY	ROUTE	POST MILES TOTAL PROJECT	SHEET No.	TOTAL SHEETS
07	LA	5,10,14, 47,60,etc.	Var	14	72
		<i>Refugio Dominguez</i> 8/30/12 REGISTERED CIVIL ENGINEER DATE			
10-22-12				PLANS APPROVAL DATE	
<small>THE STATE OF CALIFORNIA OR ITS OFFICERS OR AGENTS SHALL NOT BE RESPONSIBLE FOR THE ACCURACY OR COMPLETENESS OF SCANNED COPIES OF THIS PLAN SHEET.</small>					

NOTES:

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LOCATION No. 13
 ON ROUTE 210 AT FAIR OAKS Ave OC
 PM R25.29

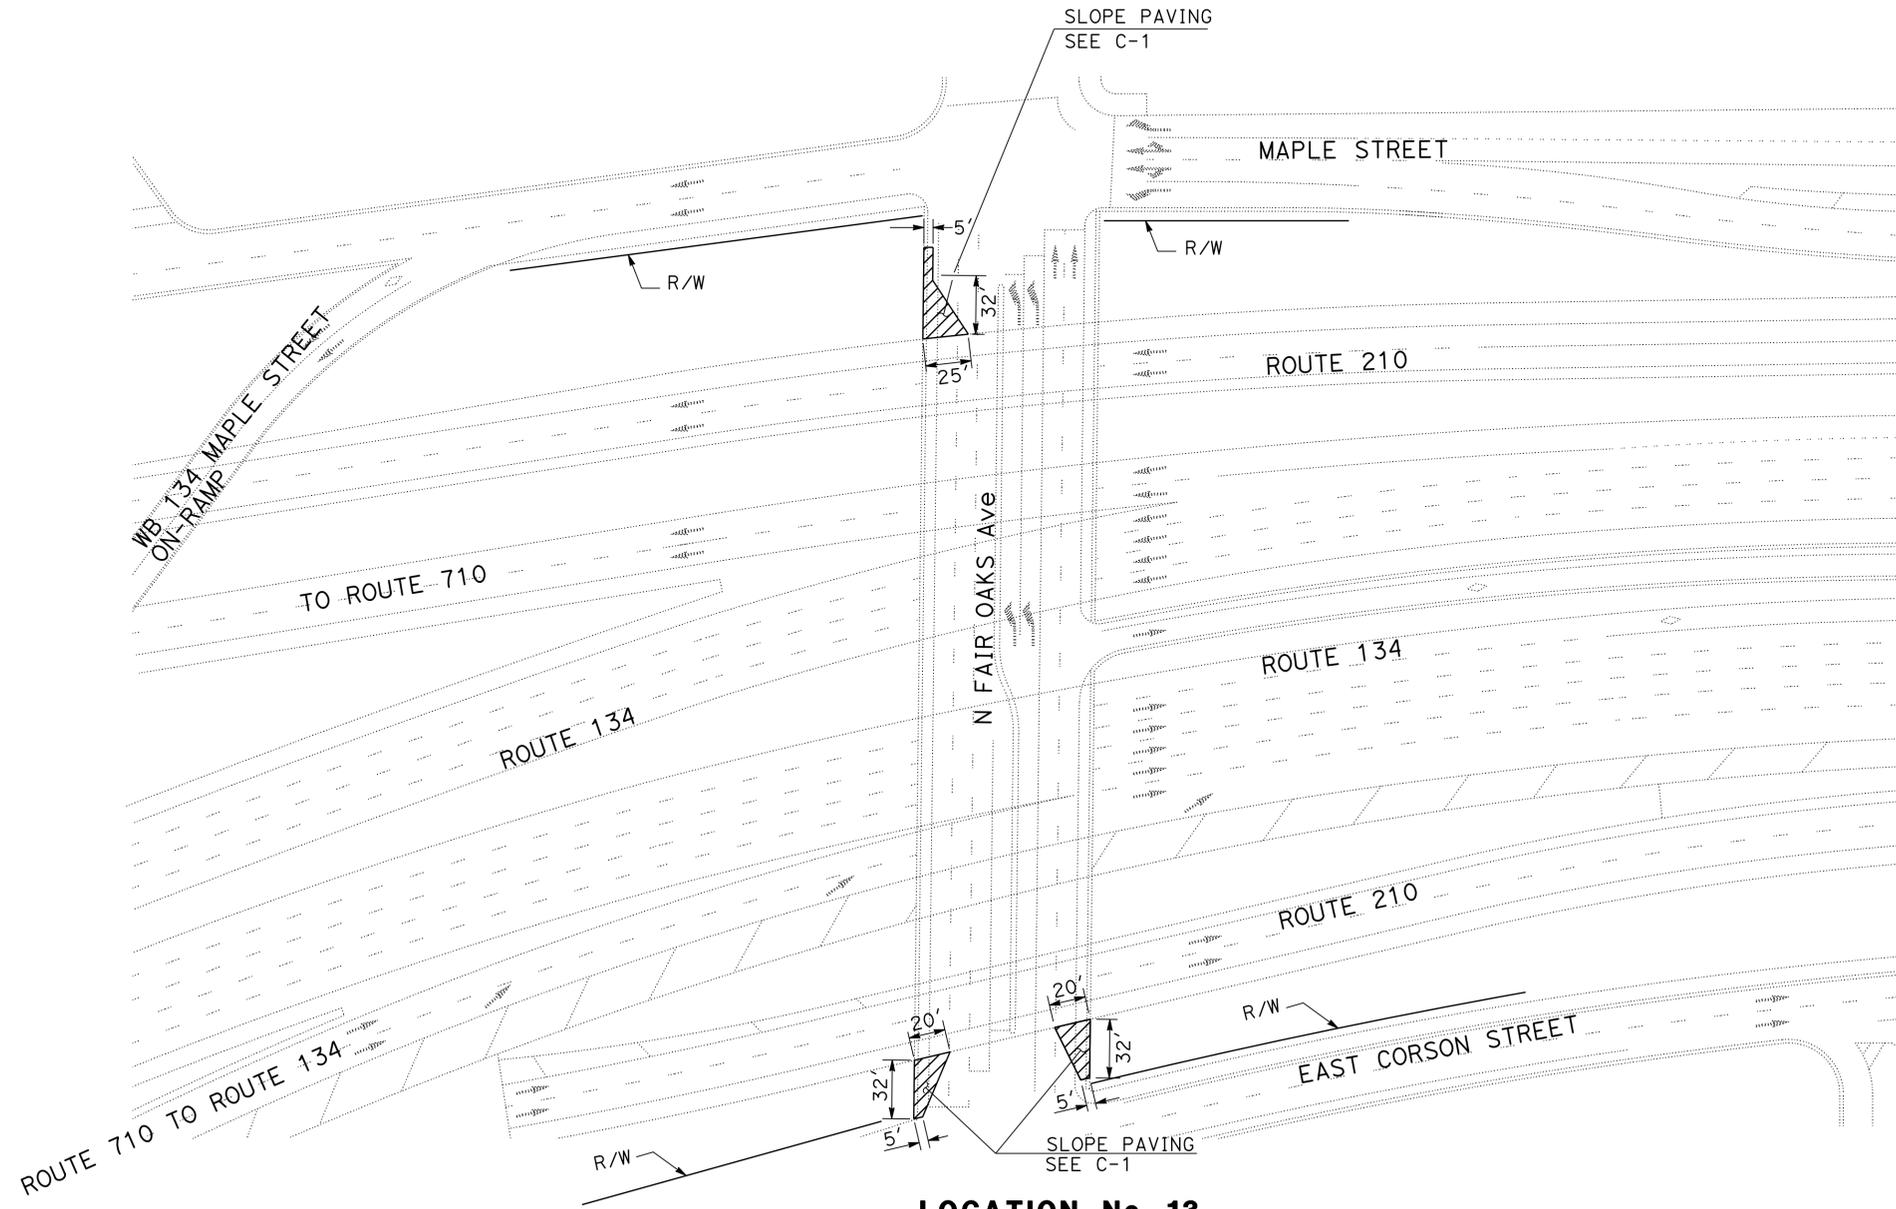LAYOUT
 SCALE: 1" = 50'


L-13

STATE OF CALIFORNIA - DEPARTMENT OF TRANSPORTATION	FUNCTIONAL SUPERVISOR	CALCULATED-DESIGNED BY	REVISOR BY
Caltrans OFFICE OF DESIGN D	KAREN FONG	CHECKED BY	MOHAMMAD MOHSENZADEH
			REFUGIO DOMINGUEZ
			DATE REVISED

Dist	COUNTY	ROUTE	POST MILES TOTAL PROJECT	SHEET No.	TOTAL SHEETS
07	LA	5,10,14, 47,60,etc.	Var	15	72
		<i>Refugio Dominguez</i> 8/30/12 REGISTERED CIVIL ENGINEER DATE			
10-22-12				PLANS APPROVAL DATE	
<small>THE STATE OF CALIFORNIA OR ITS OFFICERS OR AGENTS SHALL NOT BE RESPONSIBLE FOR THE ACCURACY OR COMPLETENESS OF SCANNED COPIES OF THIS PLAN SHEET.</small>					

NOTES:

- FOR ACCURATE RIGHT OF WAY DATA, CONTACT RIGHT OF WAY ENGINEERING AT THE DISTRICT OFFICE.
- EXISTING UTILITY FACILITIES HAVE NOT BEEN PLOTTED ON THESE PLANS.

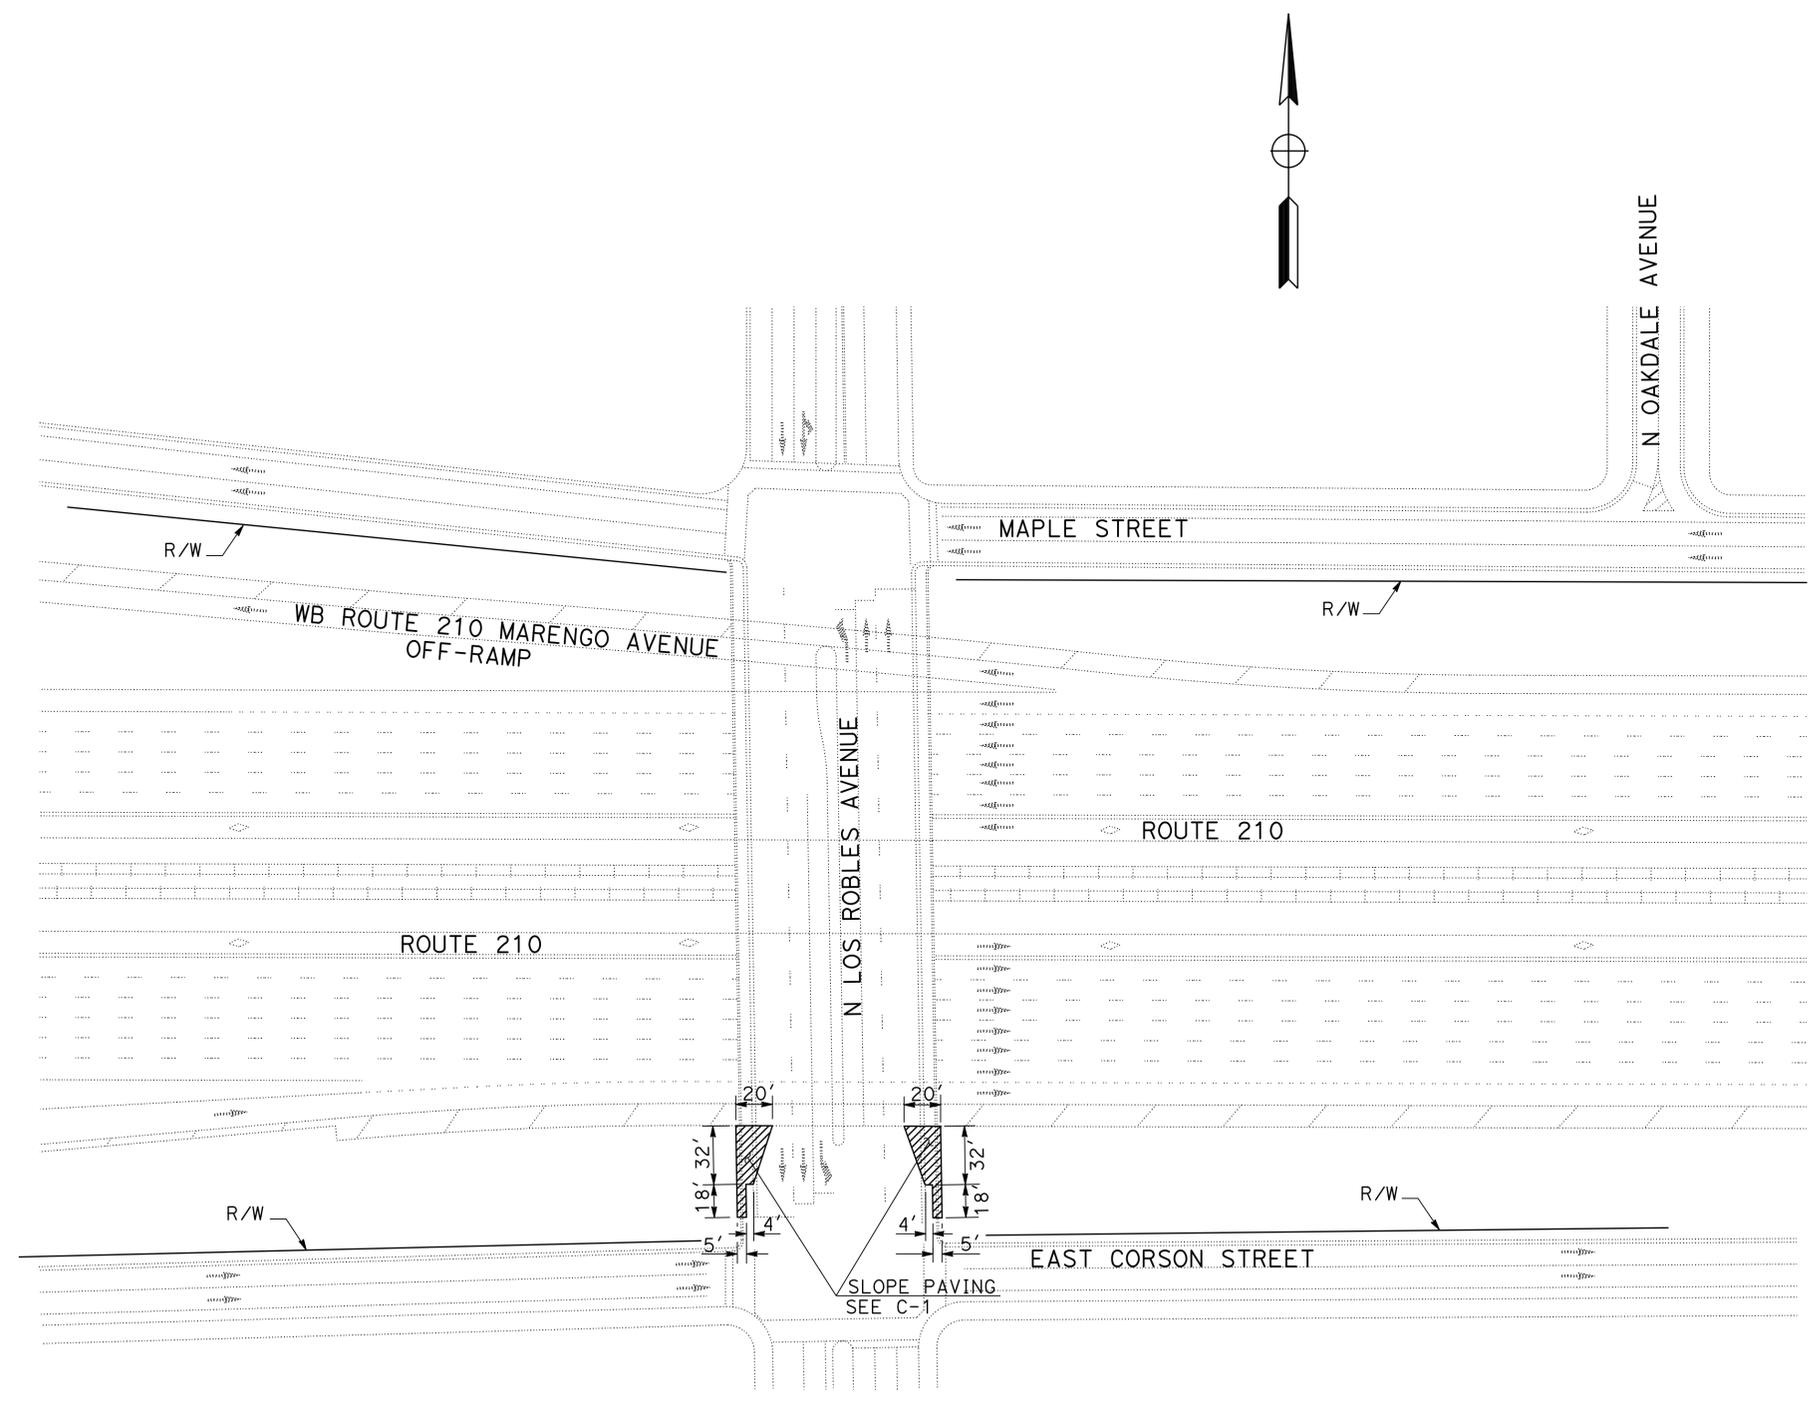

LOCATION No. 14
 ON EB ROUTE 210 AT LOS ROBLES Ave OC
 PM R25.81

LAYOUT
 SCALE: 1" = 50'

L-14

STATE OF CALIFORNIA - DEPARTMENT OF TRANSPORTATION	FUNCTIONAL SUPERVISOR	CALCULATED/DESIGNED BY	REVISOR
Caltrans OFFICE OF DESIGN D	KAREN FONG	CHECKED BY	DATE
		MOHAMMAD MOHSENZADEH	REFUGIO DOMINGUEZ

Dist	COUNTY	ROUTE	POST MILES TOTAL PROJECT	SHEET No.	TOTAL SHEETS
07	LA	5,10,14 47,60,etc.	Var	16	72


8/30/12
 REGISTERED CIVIL ENGINEER DATE
 REFUGIO DOMINGUEZ
 No. 50820
 Exp. 9/30/13
 CIVIL
 STATE OF CALIFORNIA

10-22-12
 PLANS APPROVAL DATE

THE STATE OF CALIFORNIA OR ITS OFFICERS OR AGENTS SHALL NOT BE RESPONSIBLE FOR THE ACCURACY OR COMPLETENESS OF SCANNED COPIES OF THIS PLAN SHEET.

NOTES:

1. FOR ACCURATE RIGHT OF WAY DATA, CONTACT RIGHT OF WAY ENGINEERING AT THE DISTRICT OFFICE.
2. EXISTING UTILITY FACILITIES HAVE NOT BEEN PLOTTED ON THESE PLANS.

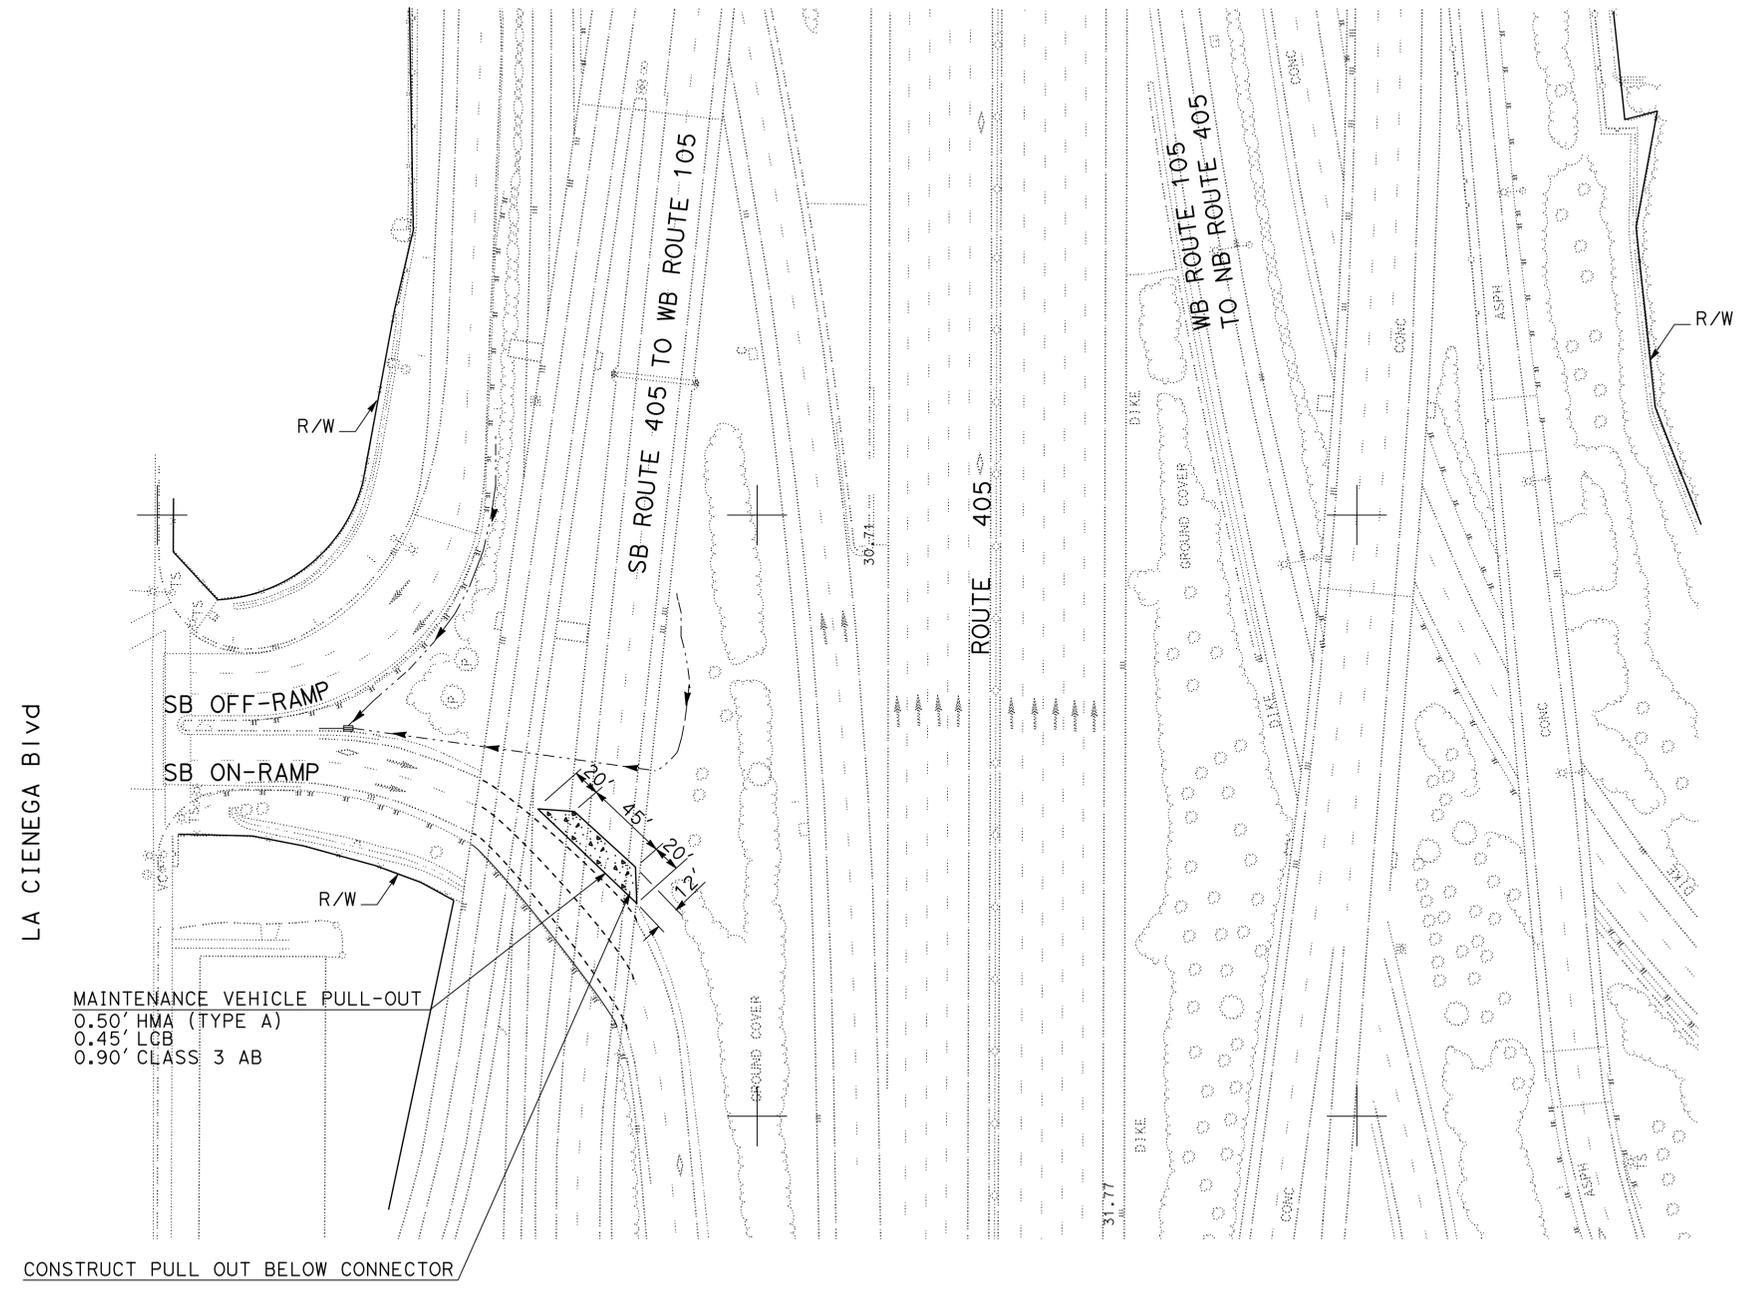


STATE OF CALIFORNIA - DEPARTMENT OF TRANSPORTATION	FUNCTIONAL SUPERVISOR	CALCULATED-DESIGNED BY	REVISOR	DATE
Caltrans OFFICE OF DESIGN D	KAREN FONG	CHECKED BY	RICHARD DOUGHERTY	
			REFUGIO DOMINGUEZ	

LOCATION No. 15
 ON SB ROUTE 405 AT LA CIENEGA Blvd UC
 PM 21.40


LAYOUT
 SCALE: 1" = 50'

L-15


Dist	COUNTY	ROUTE	POST MILES TOTAL PROJECT	SHEET No.	TOTAL SHEETS
07	LA	5,10,14, 47,60,etc.	Var	21	72
<i>Refugio Dominguez</i> REGISTERED CIVIL ENGINEER			8-30-12 DATE	REGISTERED PROFESSIONAL ENGINEER REFUGIO DOMINGUEZ No. 50820 Exp. 9-30-13 CIVIL STATE OF CALIFORNIA	
PLANS APPROVAL DATE _____					
<small>THE STATE OF CALIFORNIA OR ITS OFFICERS OR AGENTS SHALL NOT BE RESPONSIBLE FOR THE ACCURACY OR COMPLETENESS OF SCANNED COPIES OF THIS PLAN SHEET.</small>					

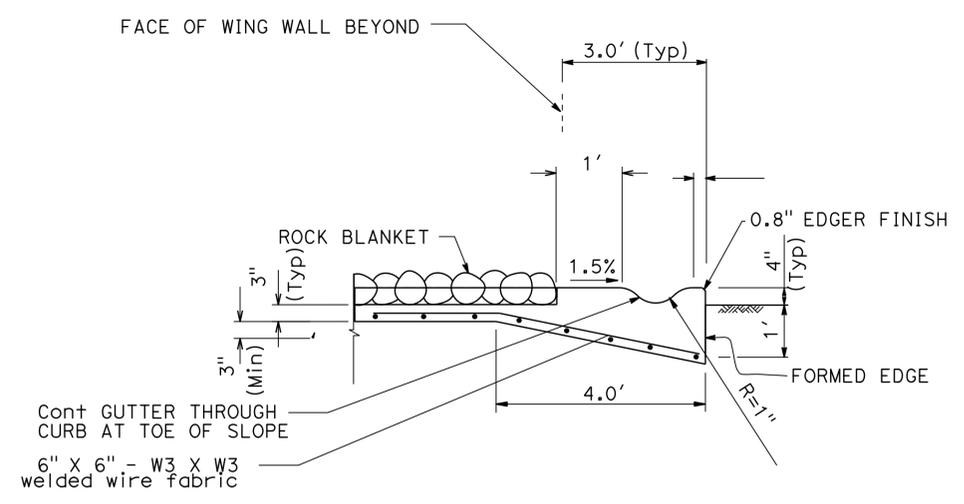


SECTION C - C

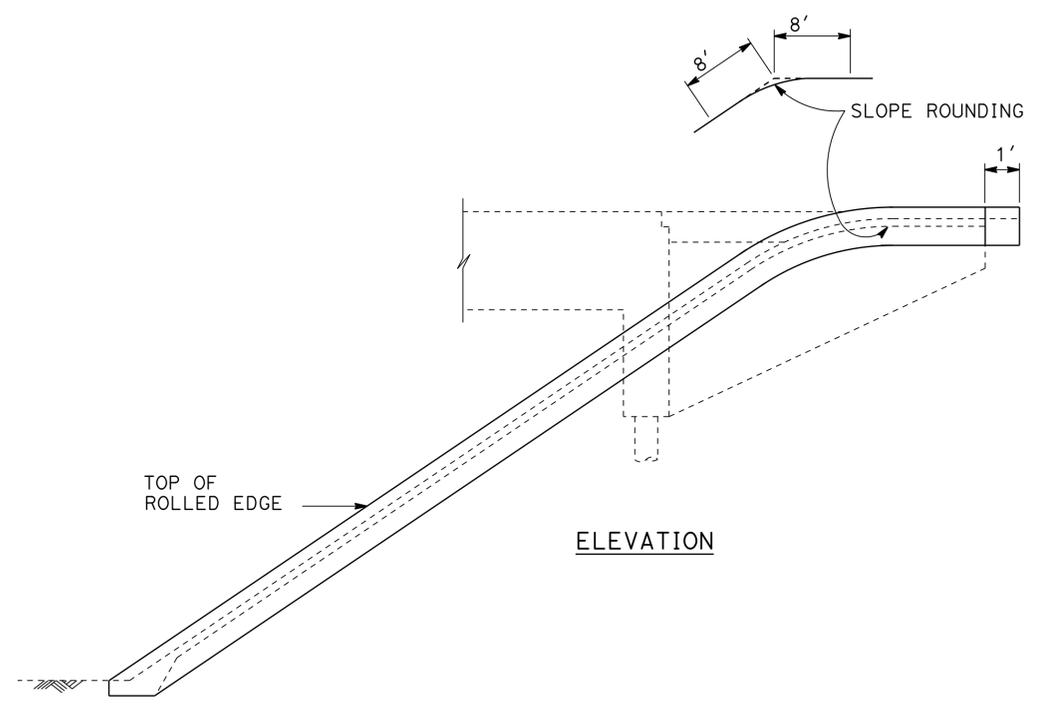


ELEVATION

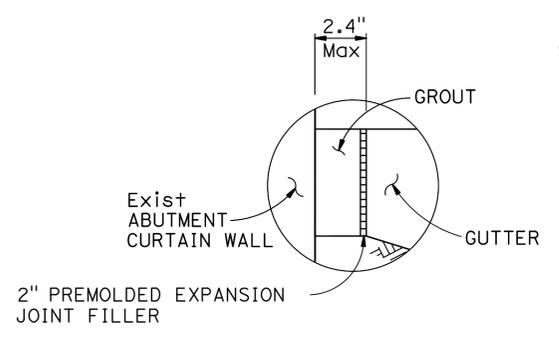


DETAIL "A"

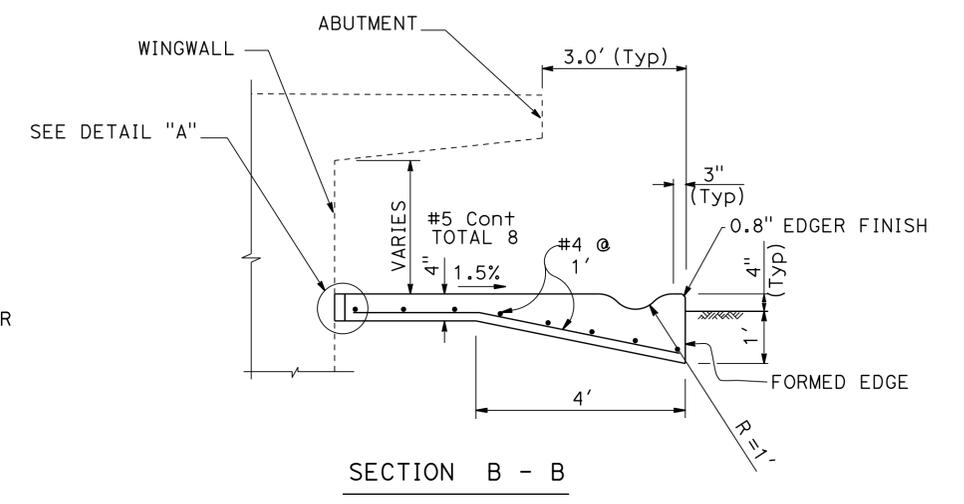

SECTION B - B

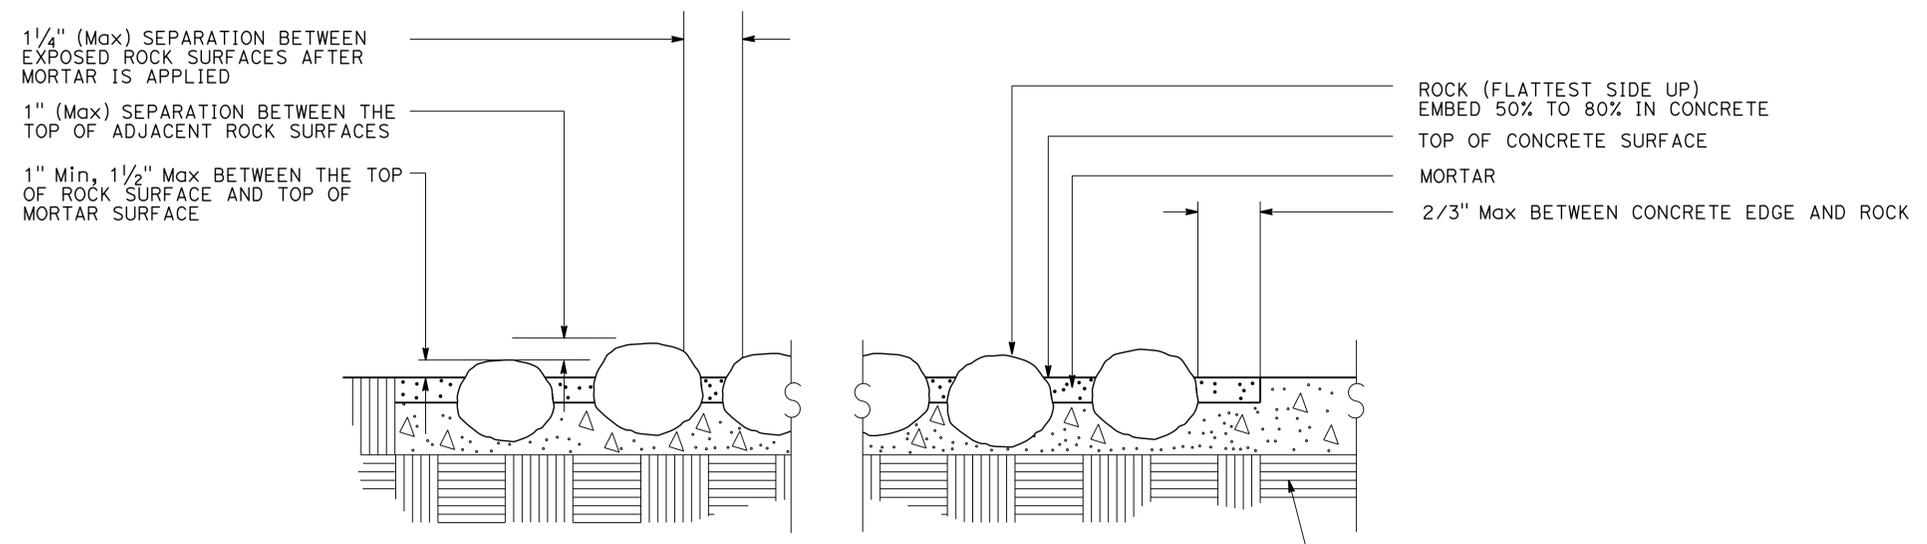

DETAIL B - ROCK BLANKET ON CONCRETE

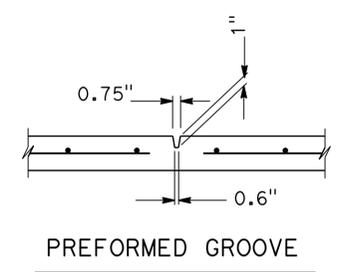

PREFORMED GROOVE

CONSTRUCTION DETAILS
NO SCALE **C-2**

STATE OF CALIFORNIA - DEPARTMENT OF TRANSPORTATION	FUNCTIONAL SUPERVISOR	CALCULATED-DESIGNED BY	REVISOR	DATE
Caltrans OFFICE OF DESIGN D	KAREN FONG	REFUGIO DOMINGUEZ	NARENDRA DESAI	
		CHECKED BY	REFUGIO DOMINGUEZ	
		DESIGNED BY	REFUGIO DOMINGUEZ	
		DESIGNED BY	REFUGIO DOMINGUEZ	
		DESIGNED BY	REFUGIO DOMINGUEZ	

LAST REVISION DATE PLOTTED => 02-JAN-2013 10-09-12 TIME PLOTTED => 19:23

Dist	COUNTY	ROUTE	POST MILES TOTAL PROJECT	SHEET No.	TOTAL SHEETS
07	LA	5,10,14, 47,60,etc.	Var	22	72



8-30-12
 REGISTERED CIVIL ENGINEER DATE
 REFUGIO DOMINGUEZ
 No. 50820
 Exp. 9-30-13
 CIVIL
 STATE OF CALIFORNIA

PLANS APPROVAL DATE
 THE STATE OF CALIFORNIA OR ITS OFFICERS OR AGENTS SHALL NOT BE RESPONSIBLE FOR THE ACCURACY OR COMPLETENESS OF SCANNED COPIES OF THIS PLAN SHEET.

CURVE DATA				
No.	R	Δ	T	L
1	50.00'	24°49'58"	11.01'	21.70'

NOTES:

- FOR ACCURATE RIGHT OF WAY AND ACCESS DATA, CONTACT RIGHT OF WAY ENGINEERING AT THE DISTRICT OFFICE.
- THE EXISTING UTILITY FACILITIES HAVE NOT BEEN PLOTTED ON THESE PLANS.

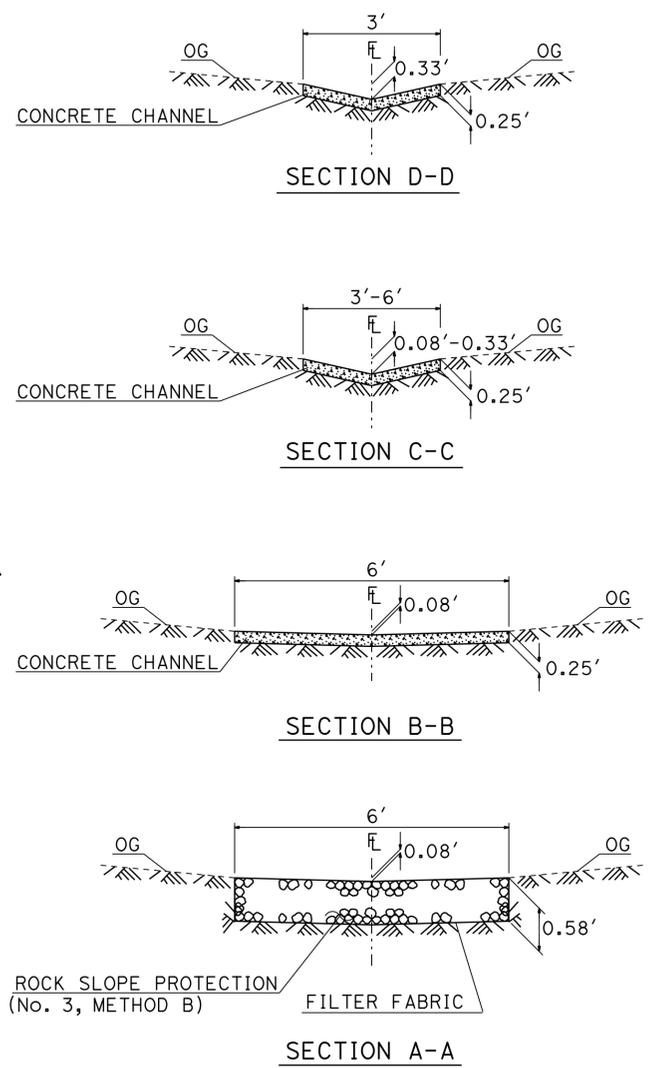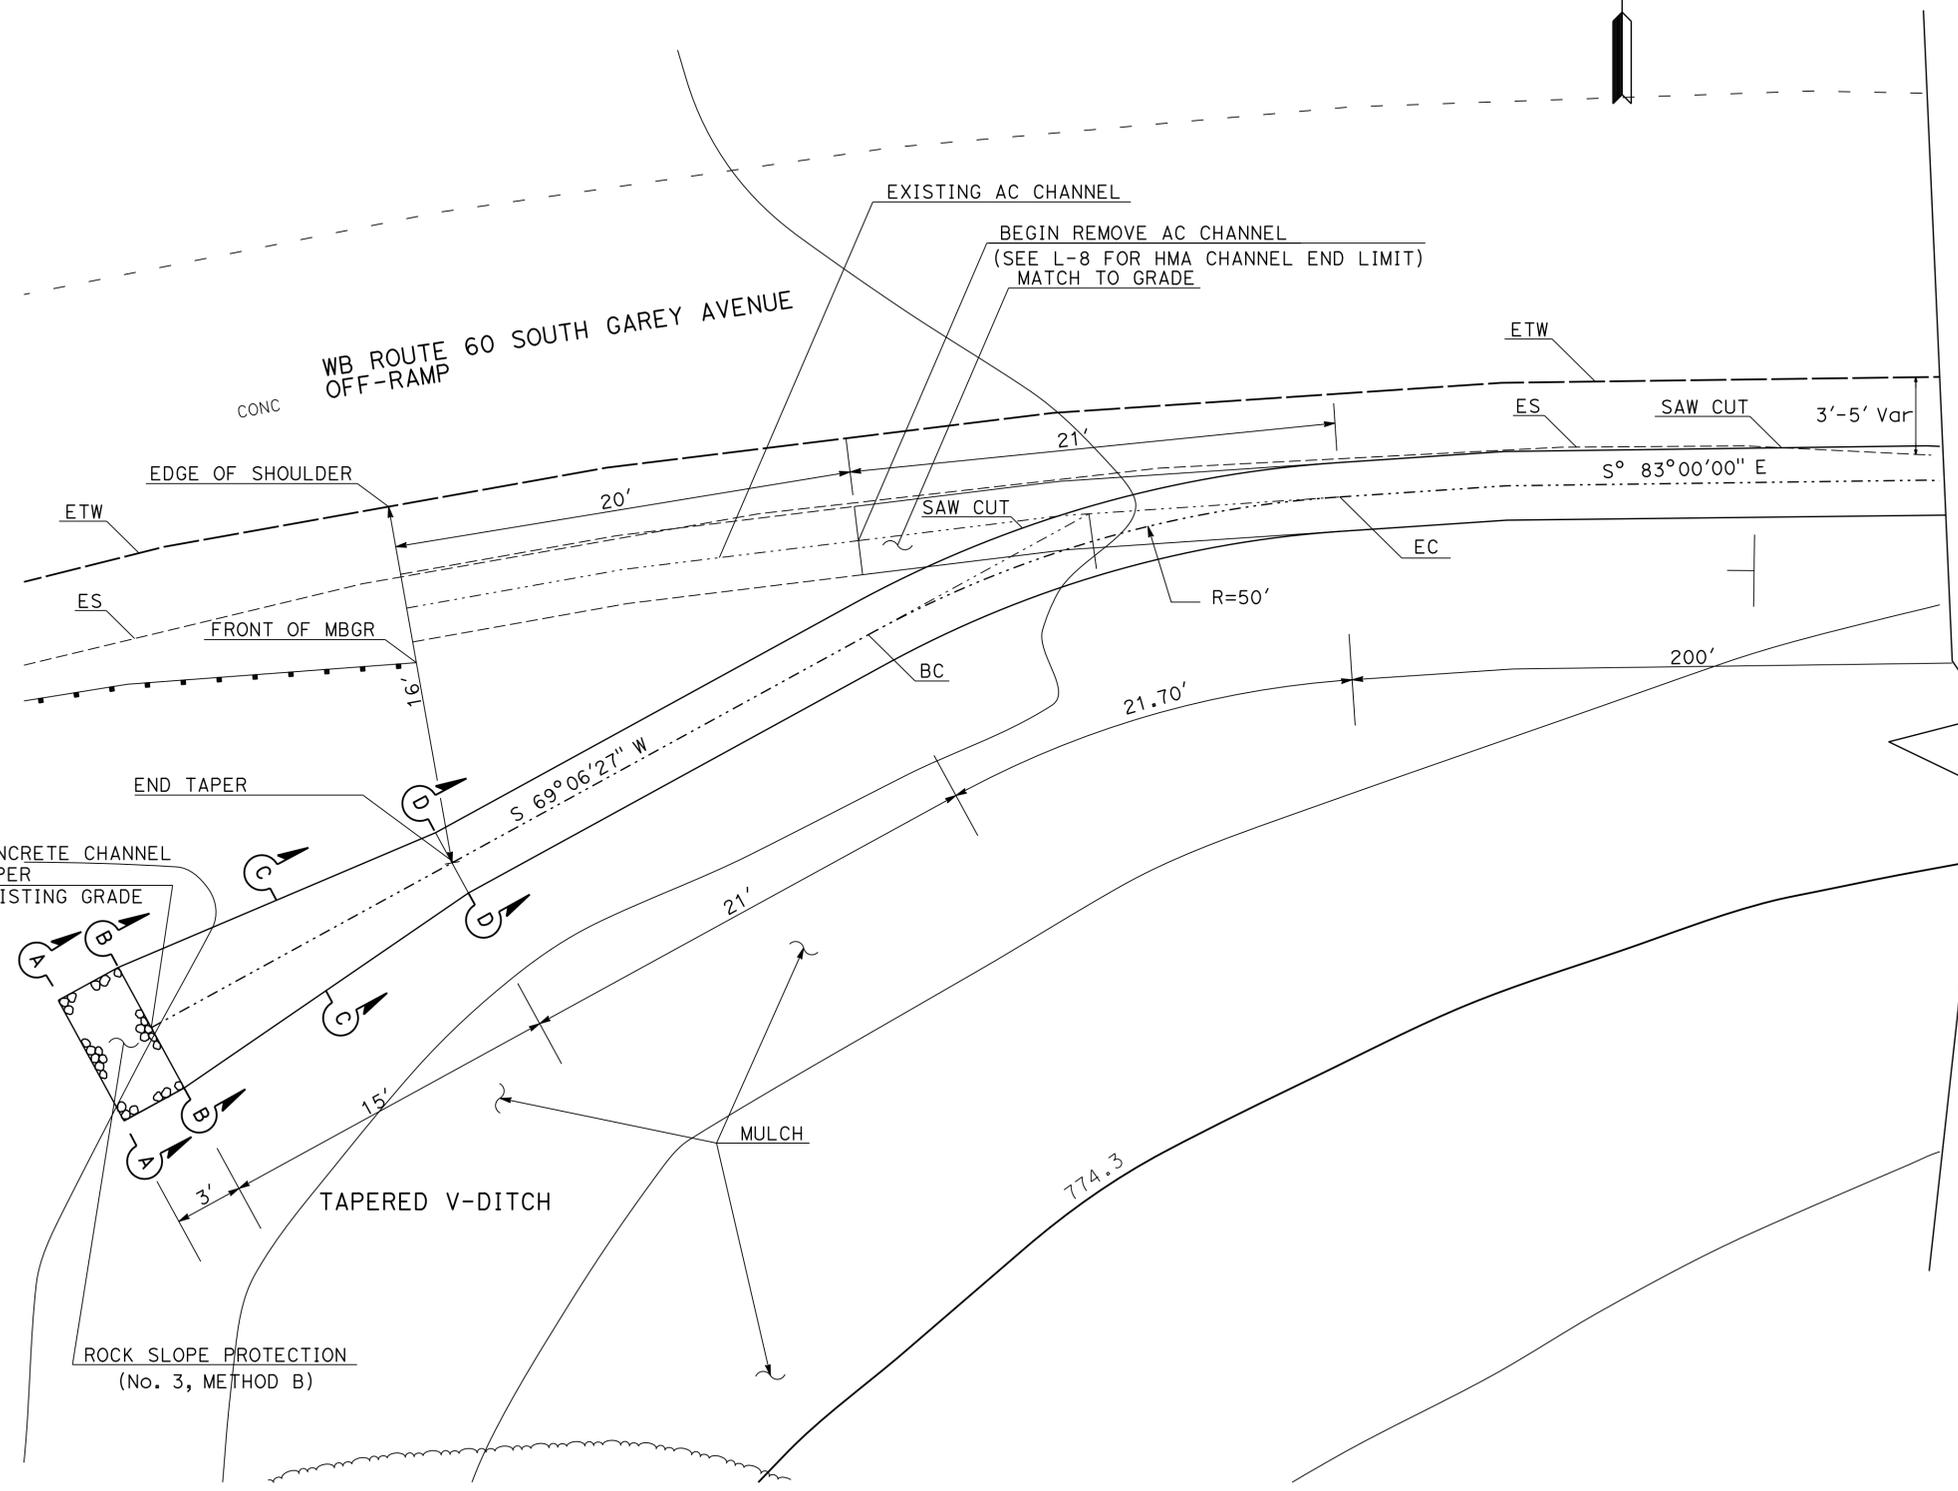




LOCATION No. 8
ON WB ROUTE 60 AT GAREY Ave OFF-RAMP

CONSTRUCTION DETAILS
NO SCALE **C-3**

STATE OF CALIFORNIA - DEPARTMENT OF TRANSPORTATION
Caltrans OFFICE OF DESIGN D
 FUNCTIONAL SUPERVISOR: KAREN FONG
 CALCULATED/DESIGNED BY: MOHAMMAD MOHSENZADEH
 CHECKED BY: REFUGIO DOMINGUEZ
 REVISED BY: MOHAMMAD MOHSENZADEH
 DATE REVISED: REFUGIO DOMINGUEZ

Dist	COUNTY	ROUTE	POST MILES TOTAL PROJECT	SHEET No.	TOTAL SHEETS
07	LA	5,10,14, 47,60,etc.	Var	24	72
<i>Refugio Dominguez</i> REGISTERED CIVIL ENGINEER			8-30-12 DATE	REGISTERED PROFESSIONAL ENGINEER REFUGIO DOMINGUEZ No. 50820 Exp. 9-30-13 CIVIL STATE OF CALIFORNIA	
PLANS APPROVAL DATE _____					
<small>THE STATE OF CALIFORNIA OR ITS OFFICERS OR AGENTS SHALL NOT BE RESPONSIBLE FOR THE ACCURACY OR COMPLETENESS OF SCANNED COPIES OF THIS PLAN SHEET.</small>					


STATE OF CALIFORNIA - DEPARTMENT OF TRANSPORTATION	FUNCTIONAL SUPERVISOR	CALCULATED/DESIGNED BY	REVISOR	DATE
Caltrans OFFICE OF DESIGN D	KAREN FONG	NGUYEN HUA	REFUGIO DOMINGUEZ	
		CHECKED BY	DATE	

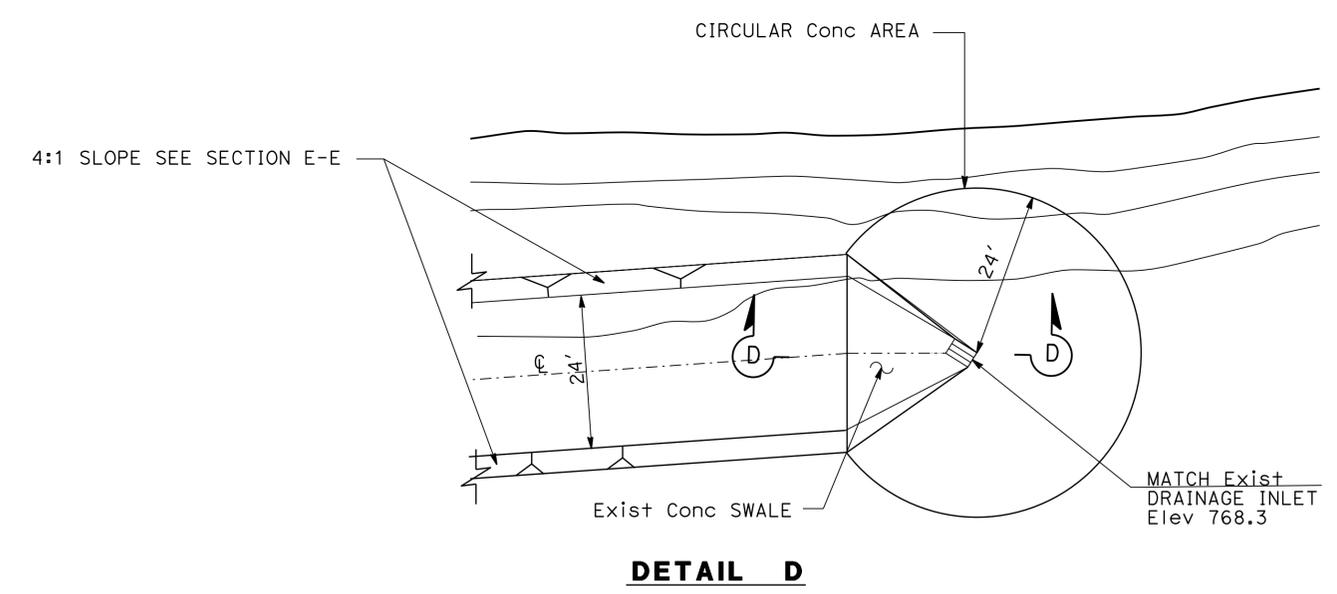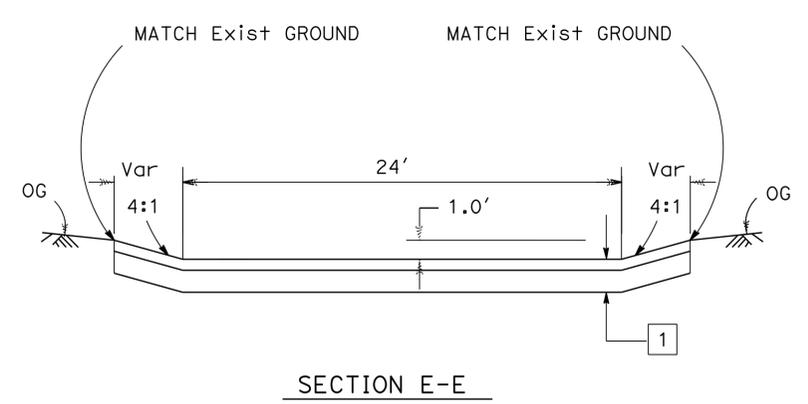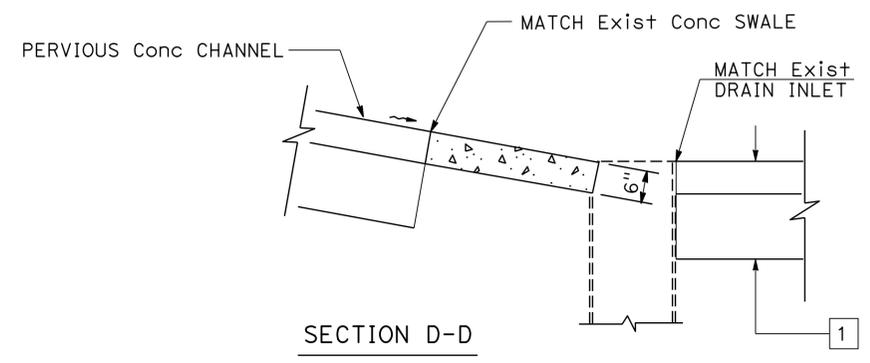



LOCATION NO. 9

CONSTRUCTION DETAILS
NO SCALE **C-5**


Dist	COUNTY	ROUTE	POST MILES TOTAL PROJECT	SHEET No.	TOTAL SHEETS
07	LA	5,10,14, 47,60,etc.	Var	25	72
<i>Refugio Dominguez</i> REGISTERED CIVIL ENGINEER			8-30-12	DATE	
PLANS APPROVAL DATE					
THE STATE OF CALIFORNIA OR ITS OFFICERS OR AGENTS SHALL NOT BE RESPONSIBLE FOR THE ACCURACY OR COMPLETENESS OF SCANNED COPIES OF THIS PLAN SHEET.					

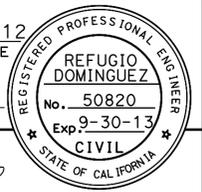


STATE OF CALIFORNIA - DEPARTMENT OF TRANSPORTATION	FUNCTIONAL SUPERVISOR	CALCULATED/DESIGNED BY	MOHAMMAD MOHSENZADEH	REVISED BY	
Caltrans OFFICE OF DESIGN D	KAREN FONG	CHECKED BY	REFUGIO DOMINGUEZ	DATE	

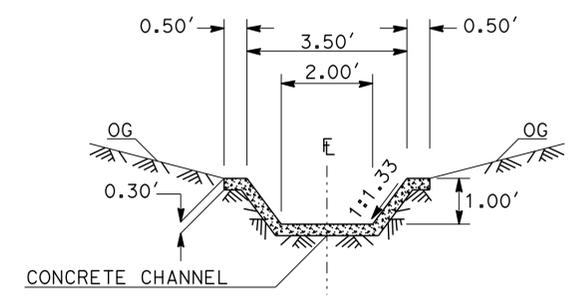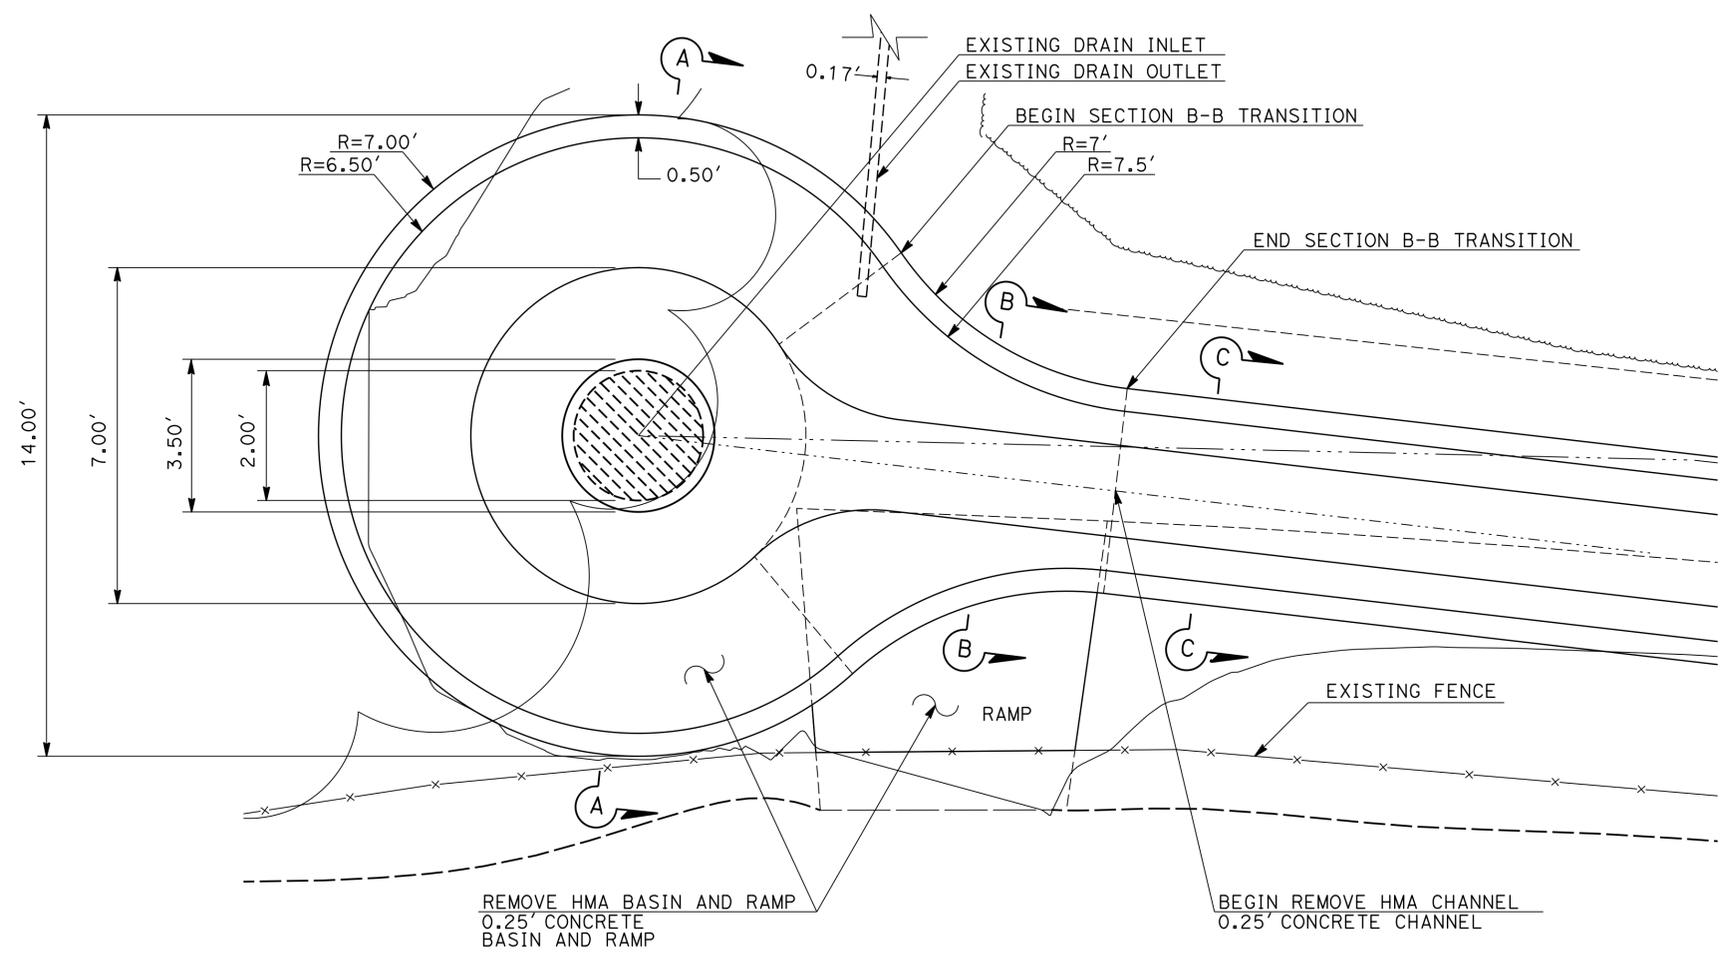

SECTION C-C

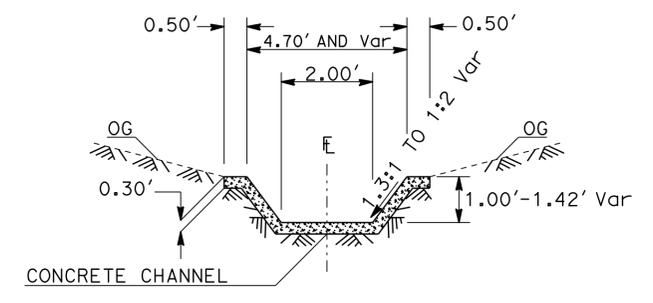

SECTION B-B

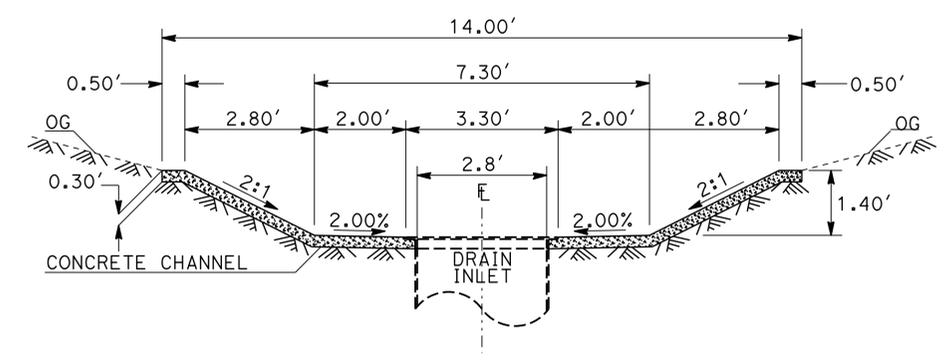

SECTION A-A

PARK AND RIDE DRAIN INLET

LOCATION NO. 9



PARK & RIDE AREA BETWEEN NB ROUTE 57 AND WB ROUTE 60

CONSTRUCTION DETAILS


NO SCALE

C-6


Dist	COUNTY	ROUTE	POST MILES TOTAL PROJECT	SHEET No.	TOTAL SHEETS
07	LA	5,10,14, 47,60,etc	Var	26	72
<i>Refugio Dominguez</i> REGISTERED CIVIL ENGINEER			8-30-12	DATE	
PLANS APPROVAL DATE					
THE STATE OF CALIFORNIA OR ITS OFFICERS OR AGENTS SHALL NOT BE RESPONSIBLE FOR THE ACCURACY OR COMPLETENESS OF SCANNED COPIES OF THIS PLAN SHEET.					

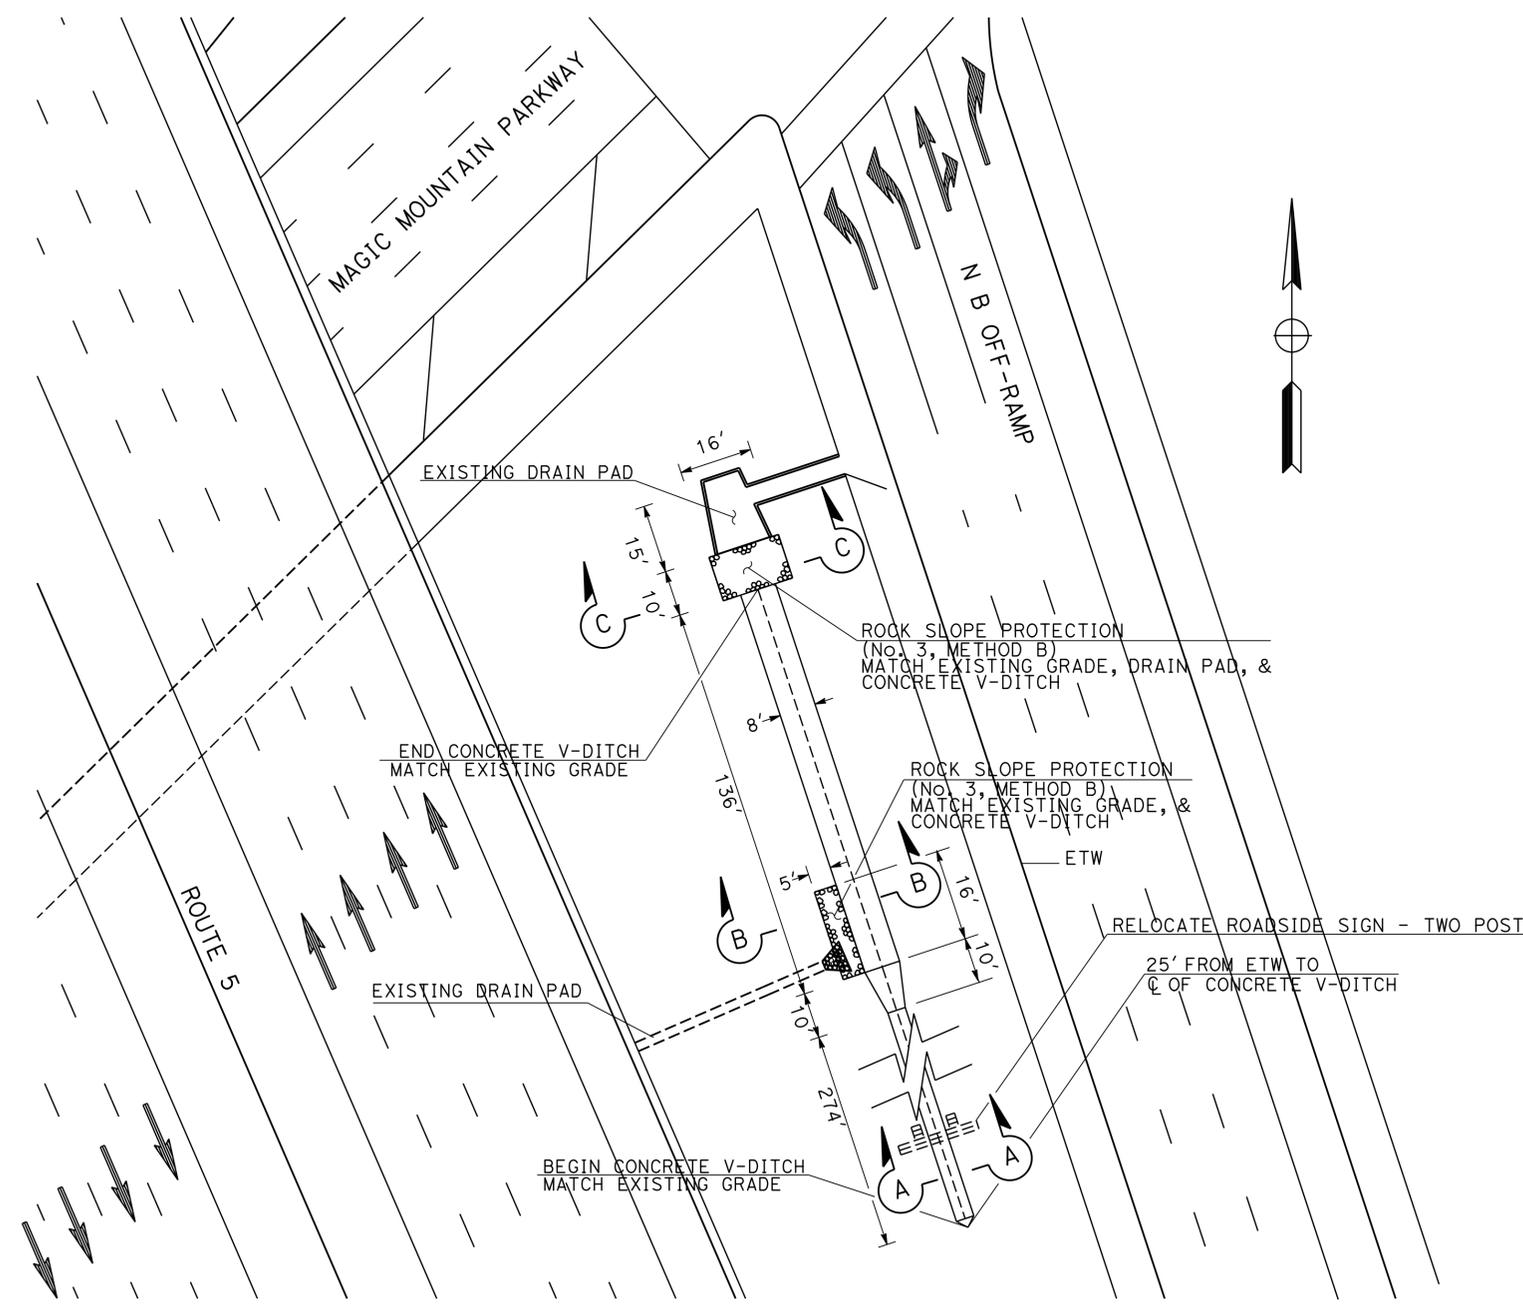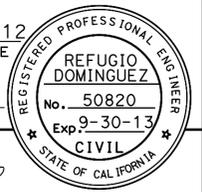


LOCATION No. 1
ON ROUTE 5 AT MAGIC MOUNTAIN PARKWAY OFF-RAMPS

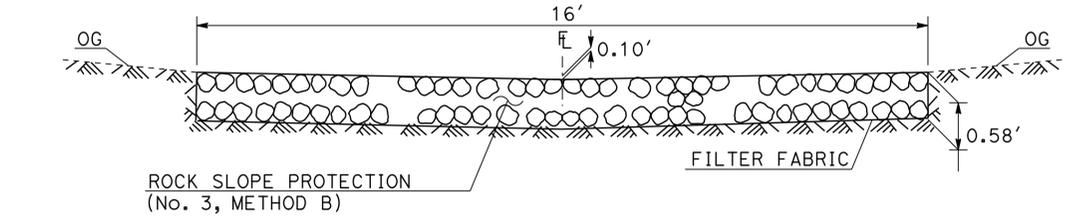

SECTION C-C

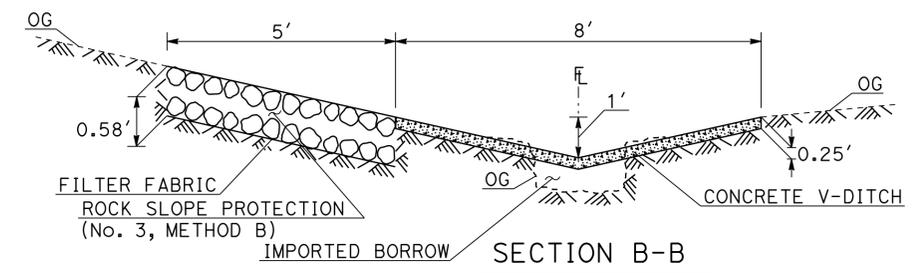

SECTION B-B

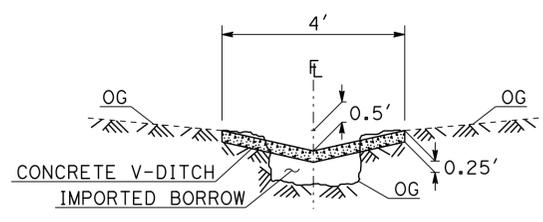

SECTION A-A

STATE OF CALIFORNIA - DEPARTMENT OF TRANSPORTATION	FUNCTIONAL SUPERVISOR	REVISOR	DATE
Caltrans OFFICE OF DESIGN D	KAREN FONG	MOHAMMAD MOHSENZADEH	
		REFUGIO DOMINGUEZ	

CONSTRUCTION DETAILS

NO SCALE **C-7**

Dist	COUNTY	ROUTE	POST MILES TOTAL PROJECT	SHEET No.	TOTAL SHEETS
07	LA	5,10,14,47,60,etc.	Var	27	72




Refugio Dominguez 8-30-12
 REGISTERED CIVIL ENGINEER DATE

PLANS APPROVAL DATE

THE STATE OF CALIFORNIA OR ITS OFFICERS OR AGENTS SHALL NOT BE RESPONSIBLE FOR THE ACCURACY OR COMPLETENESS OF SCANNED COPIES OF THIS PLAN SHEET.

REGISTERED PROFESSIONAL ENGINEER
 REFUGIO DOMINGUEZ
 No. 50820
 Exp. 9-30-13
 CIVIL
 STATE OF CALIFORNIA

STATE OF CALIFORNIA - DEPARTMENT OF TRANSPORTATION	FUNCTIONAL SUPERVISOR	REVISOR	DATE
Caltrans OFFICE OF DESIGN D	KAREN FONG	MOHAMMAD MOHSENZADEH	REFUGIO DOMINGUEZ
		CALCULATED-DESIGNED BY	CHECKED BY

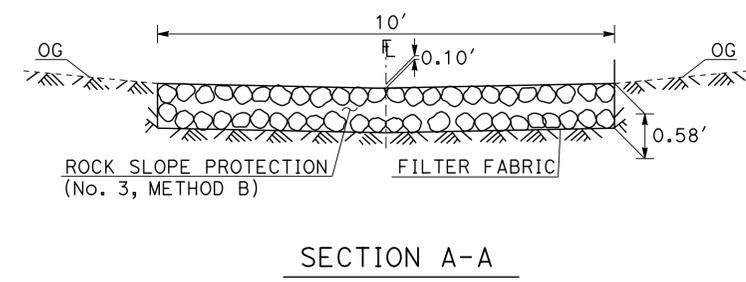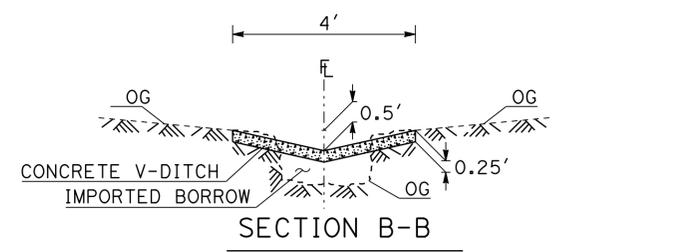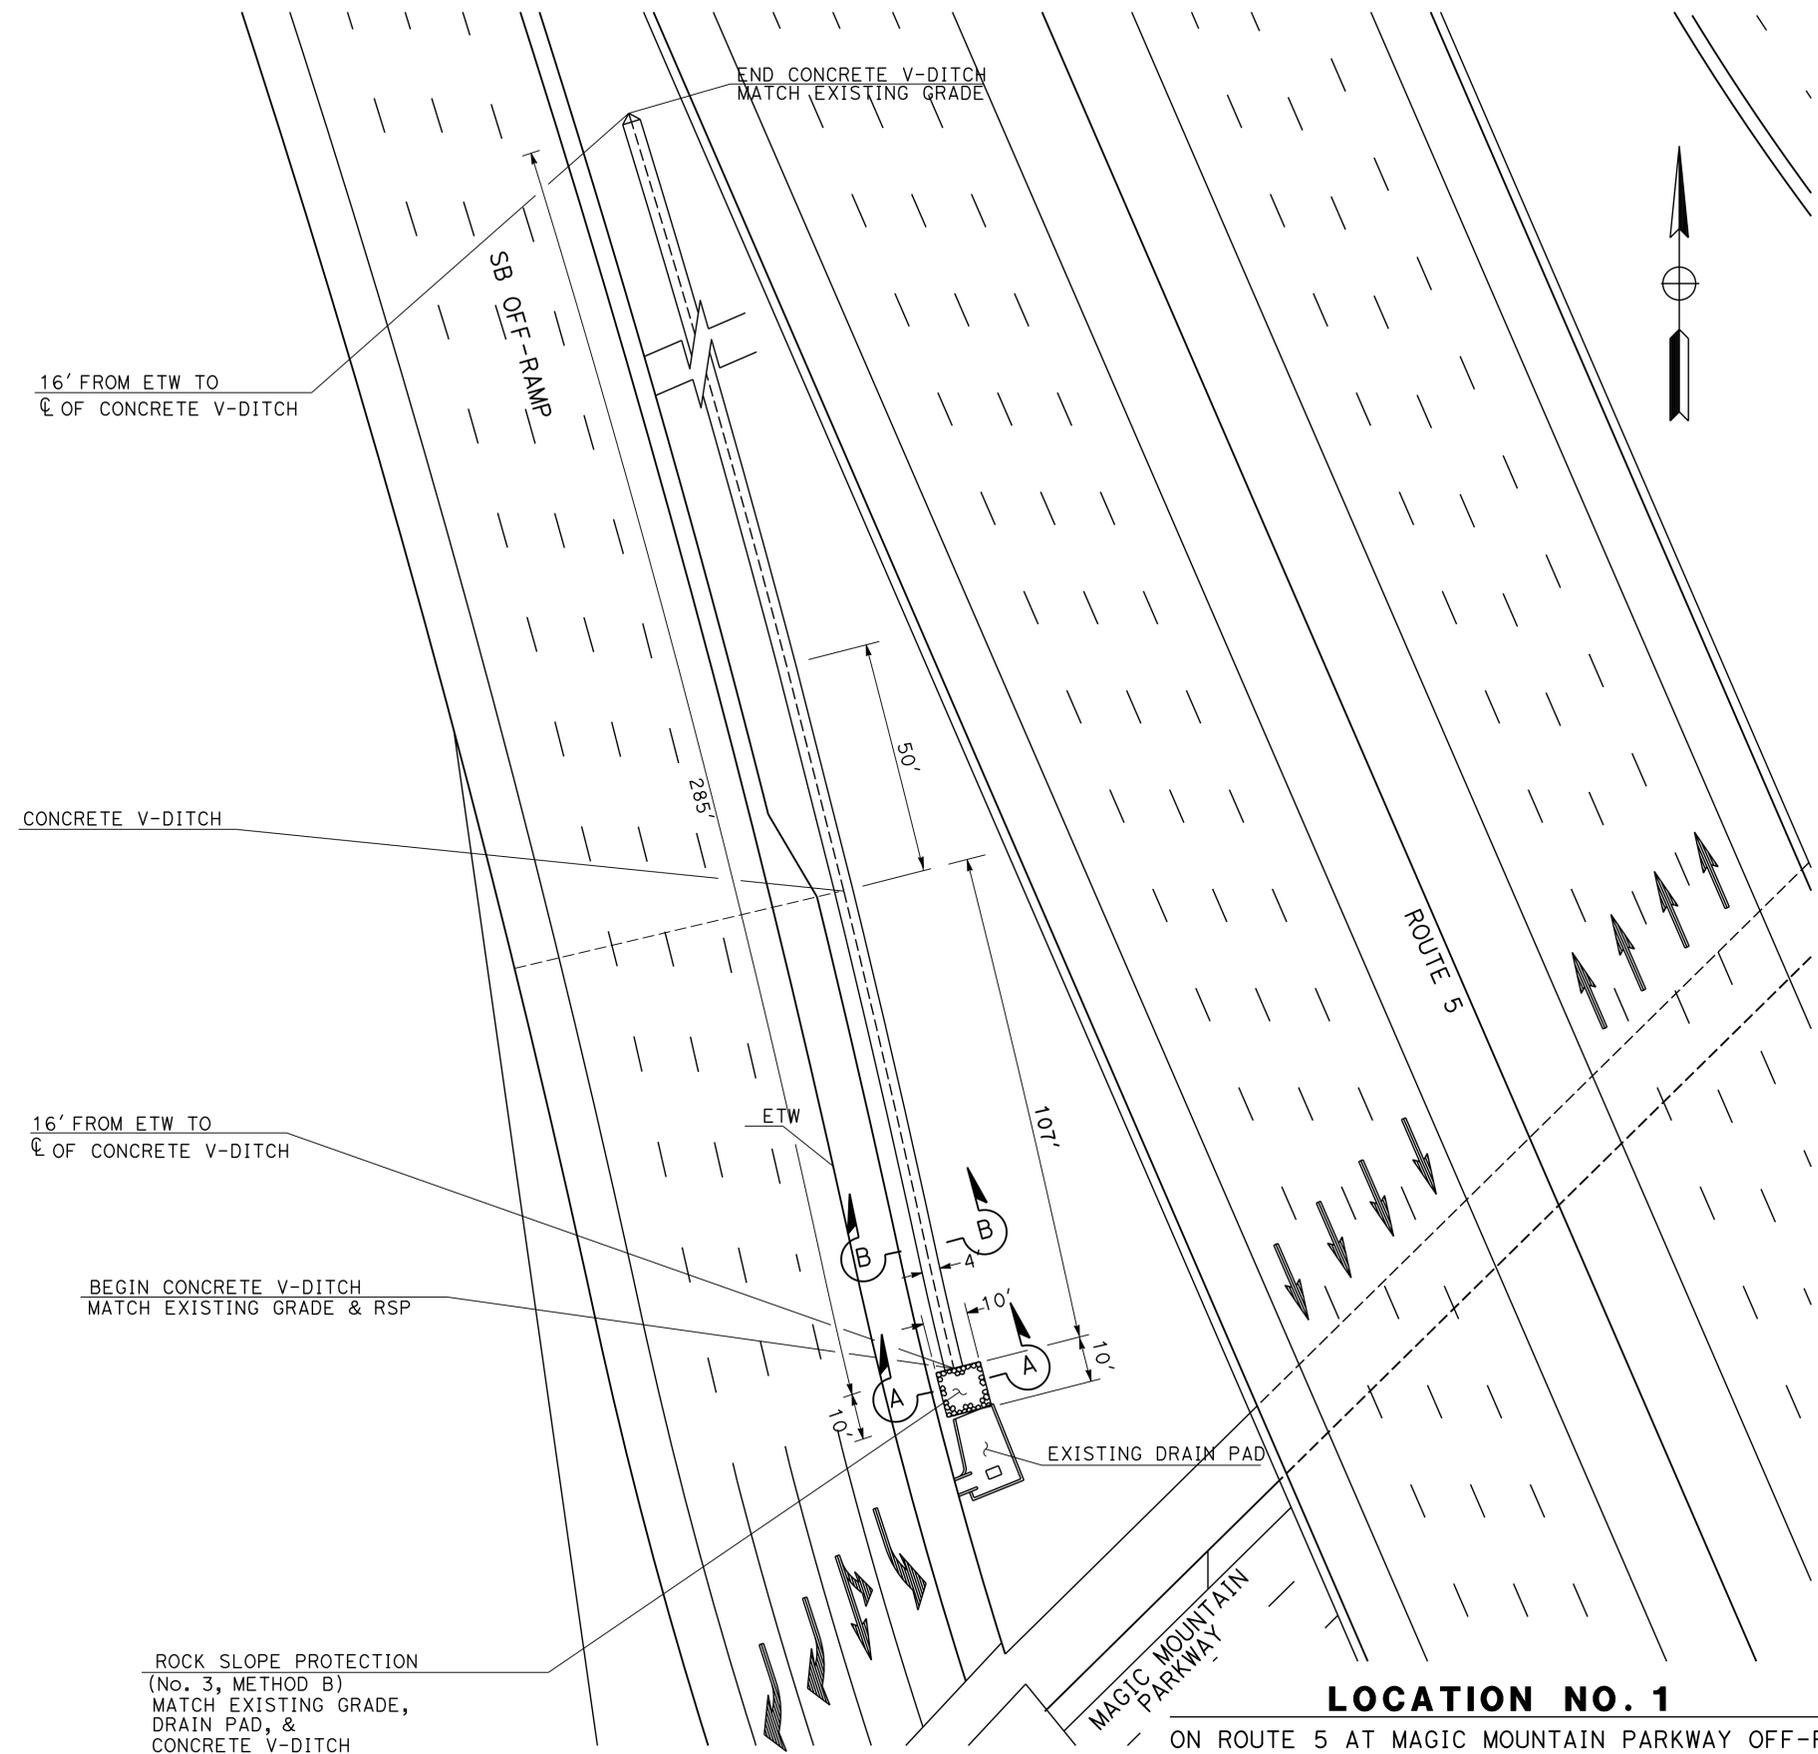

LOCATION NO. 1

ON ROUTE 5 AT MAGIC MOUNTAIN PARKWAY OFF-RAMPS


CONSTRUCTION DETAILS

NO SCALE


C-8

Dist	COUNTY	ROUTE	POST MILES TOTAL PROJECT	SHEET No.	TOTAL SHEETS
07	LA	5,10,14,47,60,etc.	Var	28	72
<i>Refugio Dominguez</i> REGISTERED CIVIL ENGINEER			8-30-12 DATE	REGISTERED PROFESSIONAL ENGINEER REFUGIO DOMINGUEZ No. 50820 Exp. 9-30-13 CIVIL STATE OF CALIFORNIA	
PLANS APPROVAL DATE					
<small>THE STATE OF CALIFORNIA OR ITS OFFICERS OR AGENTS SHALL NOT BE RESPONSIBLE FOR THE ACCURACY OR COMPLETENESS OF SCANNED COPIES OF THIS PLAN SHEET.</small>					


STATE OF CALIFORNIA - DEPARTMENT OF TRANSPORTATION	FUNCTIONAL SUPERVISOR	CALCULATED-DESIGNED BY	REVISED BY
Caltrans OFFICE OF DESIGN D	KAREN FONG	CHECKED BY	DATE REVISED
		MOHAMMAD MOHSENZADEH	
		REFUGIO DOMINGUEZ	

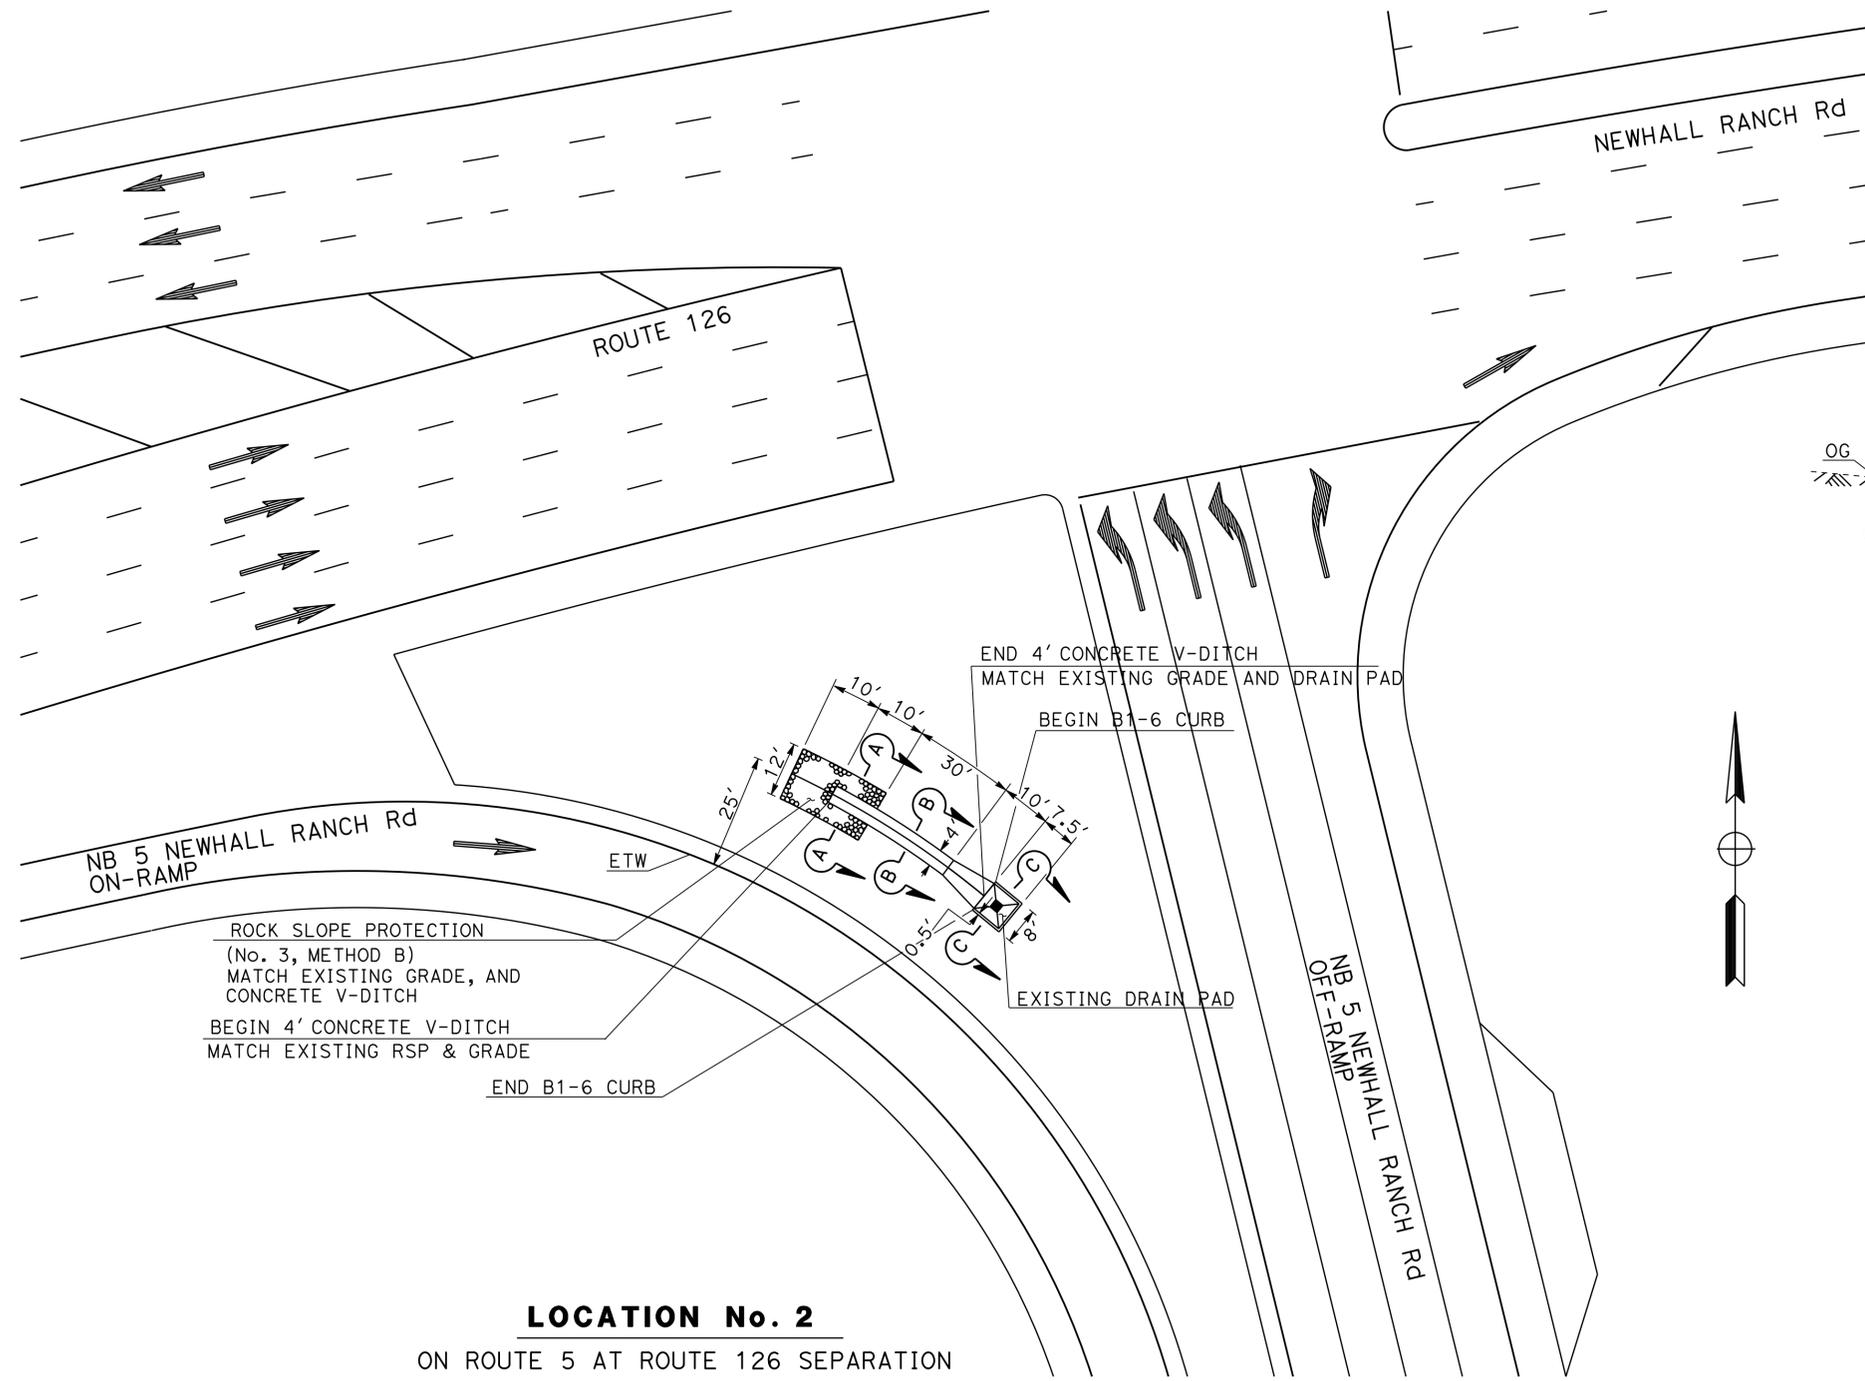


LOCATION No. 2
ON ROUTE 5 AT ROUTE 126 SEPARATION

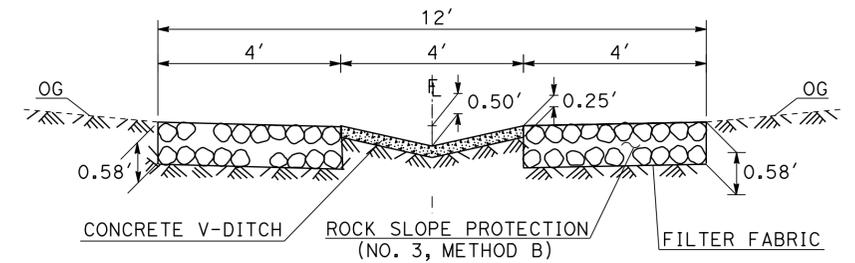

SECTION A-A

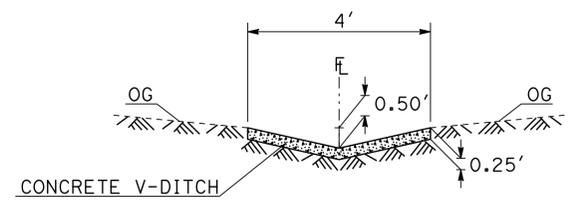

SECTION B-B

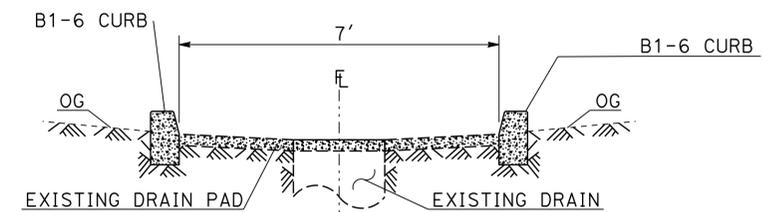

SECTION C-C




CONSTRUCTION DETAILS

NO SCALE

C-9

Dist	COUNTY	ROUTE	POST MILES TOTAL PROJECT	SHEET No.	TOTAL SHEETS
07	LA	5,10,14, 47,60,etc.	Var	29	72
<i>Refugio Dominguez</i> REGISTERED CIVIL ENGINEER			8-30-12 DATE		
PLANS APPROVAL DATE _____					
<small>THE STATE OF CALIFORNIA OR ITS OFFICERS OR AGENTS SHALL NOT BE RESPONSIBLE FOR THE ACCURACY OR COMPLETENESS OF SCANNED COPIES OF THIS PLAN SHEET.</small>					

STATE OF CALIFORNIA - DEPARTMENT OF TRANSPORTATION	FUNCTIONAL SUPERVISOR	CALCULATED-DESIGNED BY	REVISOR
Caltrans OFFICE OF DESIGN D	KAREN FONG	CHECKED BY	MOHAMMAD MOHSENZADEH
			REFUGIO DOMINGUEZ
			DATE
			REVISED

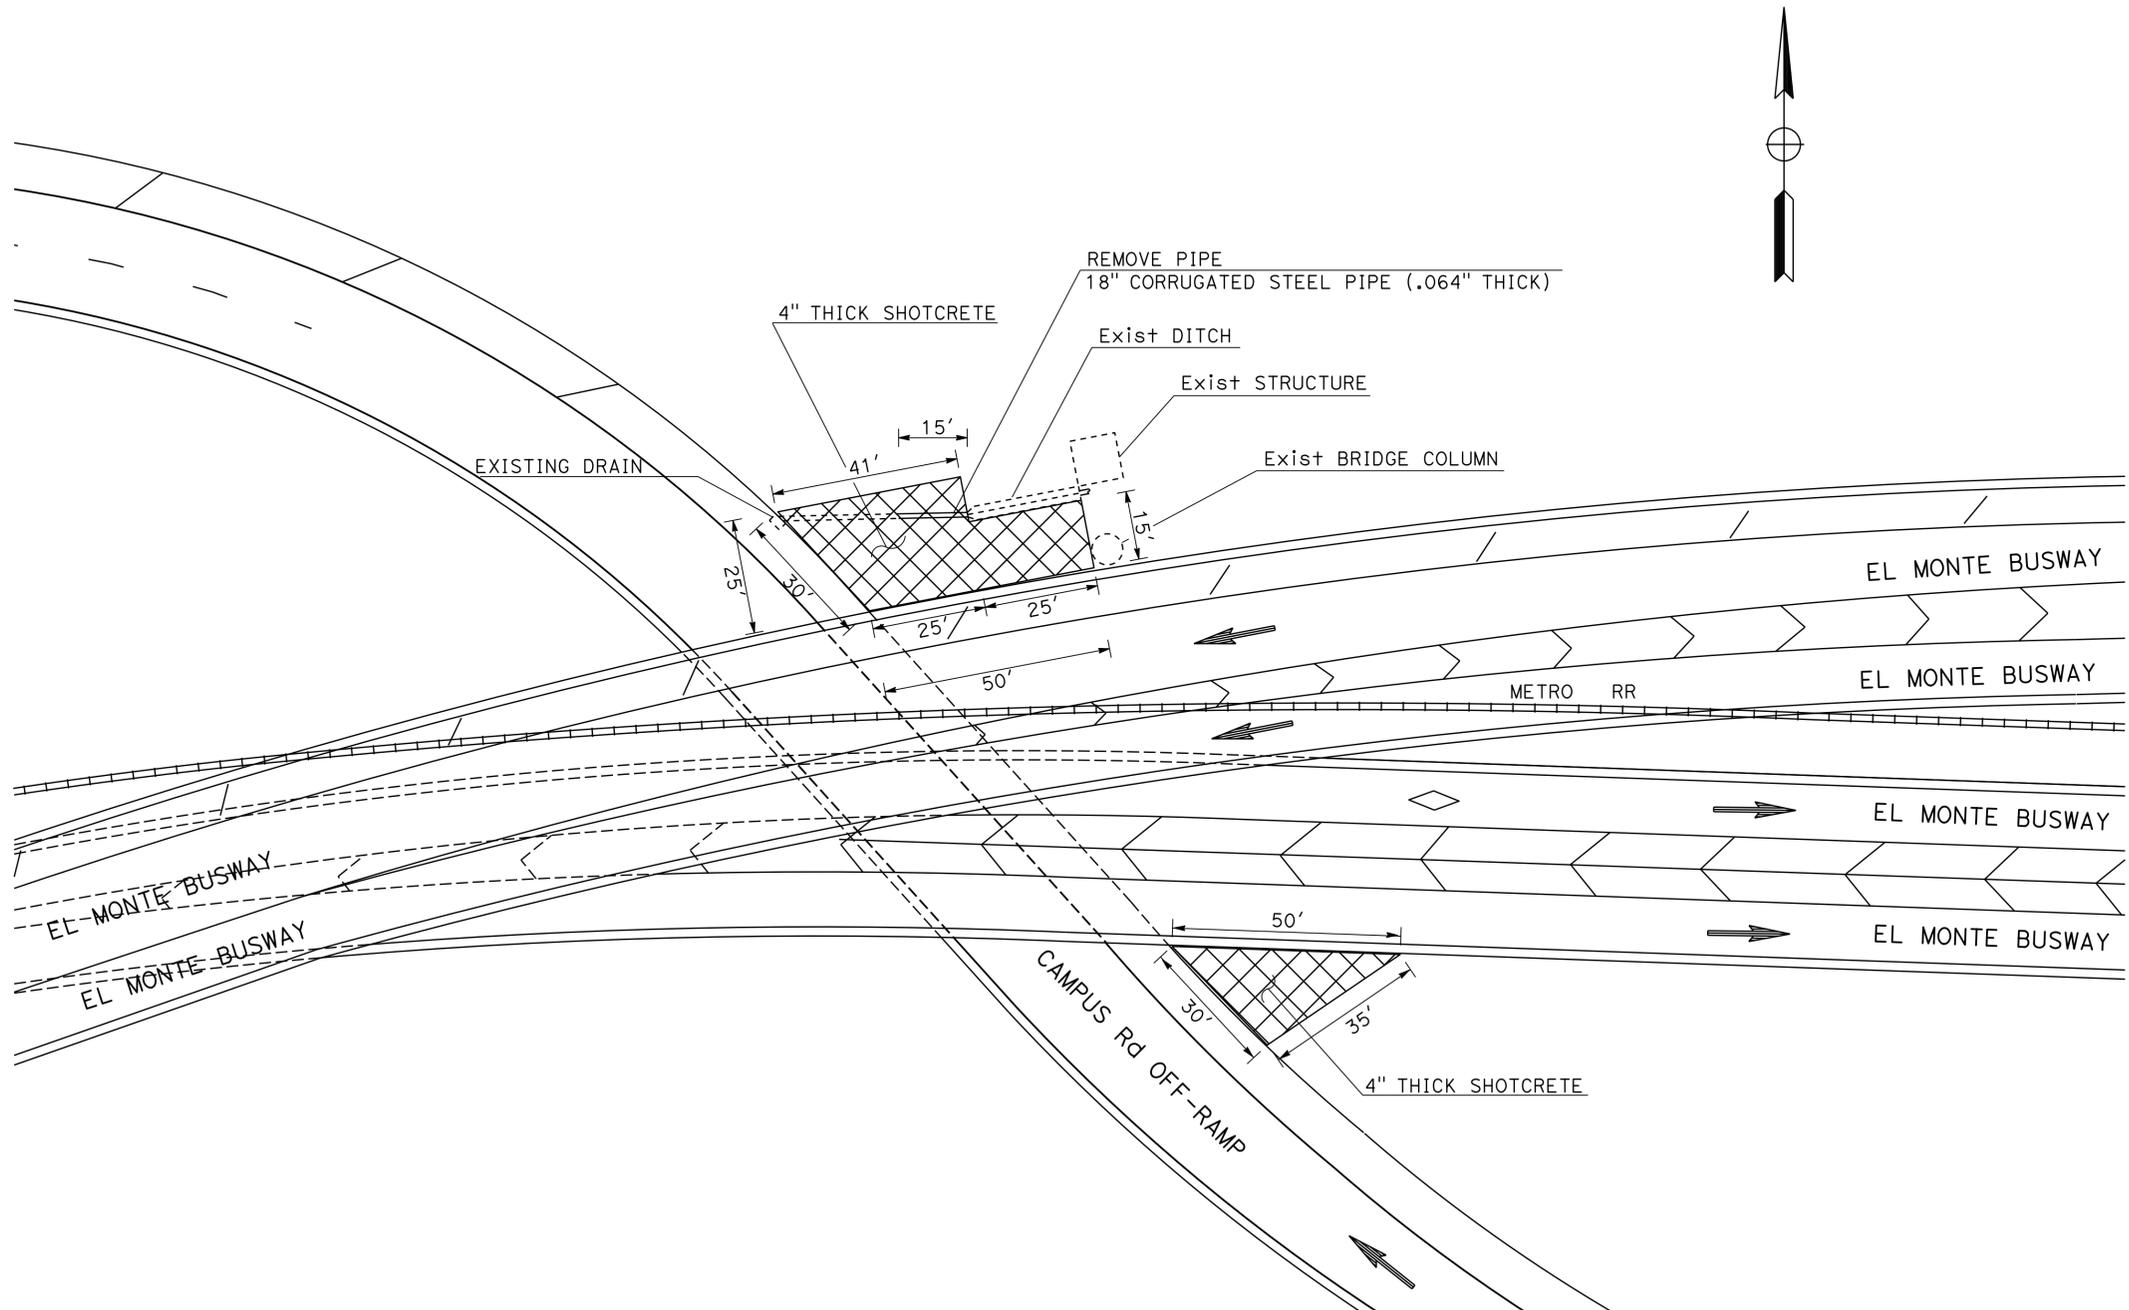


LOCATION No. 3
ON WB 10 AT EASTERN Ave OFF-RAMP

CONSTRUCTION DETAILS
NO SCALE **C-10**

LAST REVISION DATE PLOTTED => 02-JAN-2013
10-09-12 TIME PLOTTED => 19:23

Dist	COUNTY	ROUTE	POST MILES TOTAL PROJECT	SHEET No.	TOTAL SHEETS
07	LA	5,10,14 47,60,etc.	Var	30	72
<i>Refugio Dominguez</i> REGISTERED CIVIL ENGINEER			8-30-12 DATE		
PLANS APPROVAL DATE _____					
<small>THE STATE OF CALIFORNIA OR ITS OFFICERS OR AGENTS SHALL NOT BE RESPONSIBLE FOR THE ACCURACY OR COMPLETENESS OF SCANNED COPIES OF THIS PLAN SHEET.</small>					


STATE OF CALIFORNIA - DEPARTMENT OF TRANSPORTATION	FUNCTIONAL SUPERVISOR	CALCULATED/DESIGNED BY	REVISED BY
Caltrans OFFICE OF DESIGN D	KAREN FONG	CHECKED BY	DATE REVISED
		MOHAMMAD MOHSENZADEH	
		REFUGIO DOMINGUEZ	

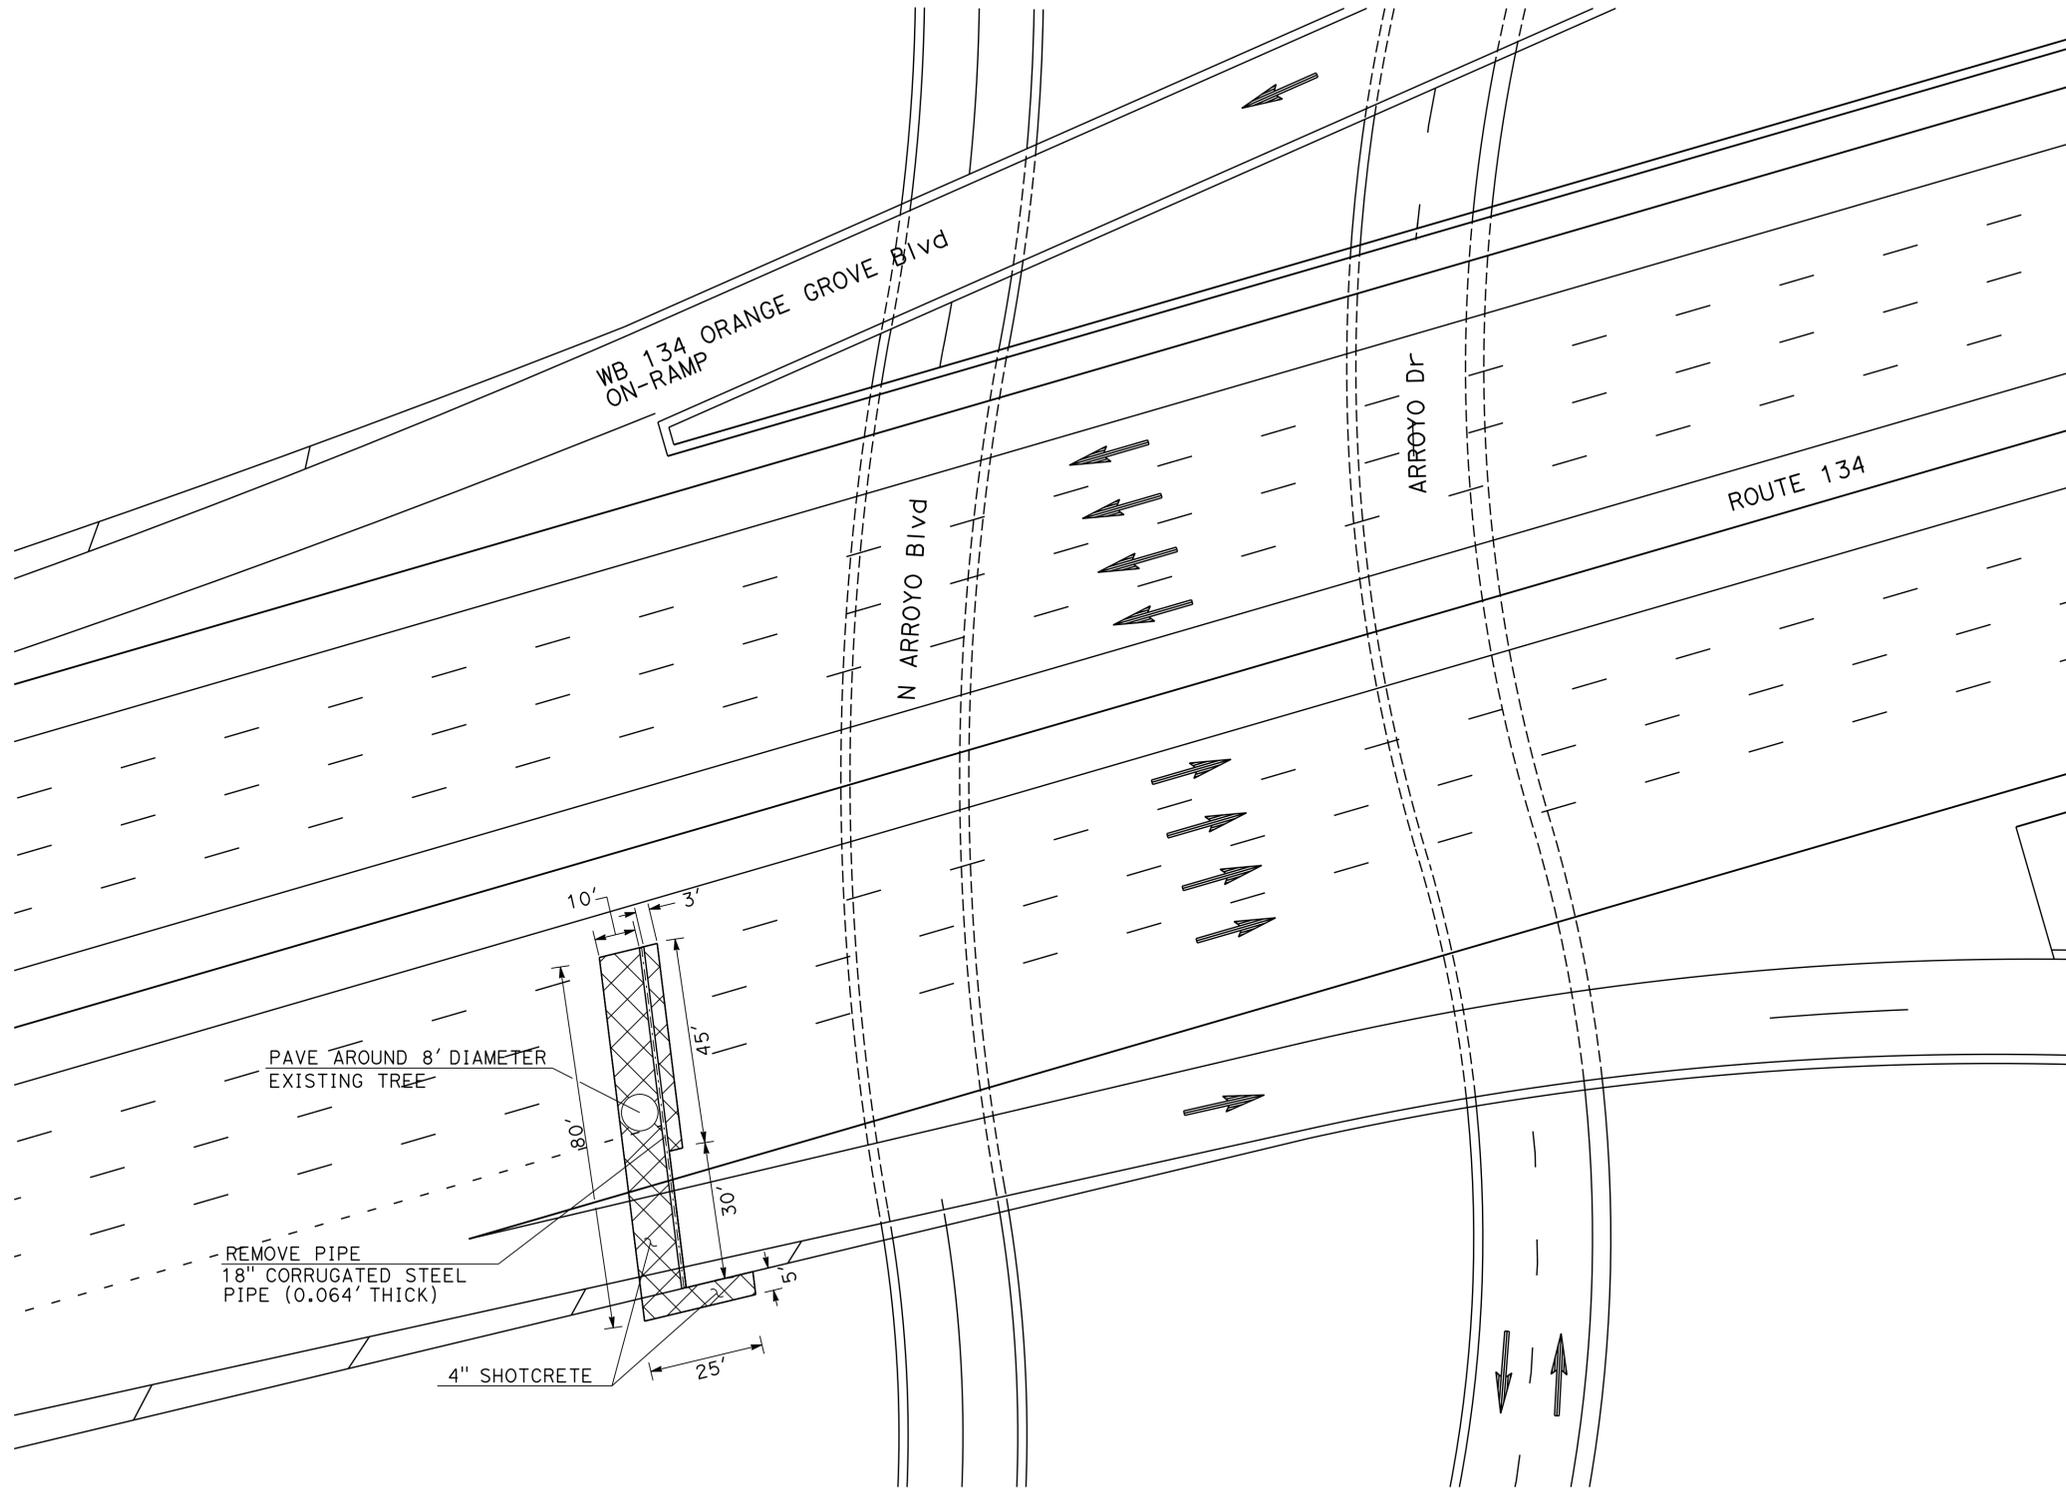

LOCATION No. 12
ON EB ROUTE 134 AT ARROYO SECO SEPARATION

CONSTRUCTION DETAILS
NO SCALE **C-11**

Dist	COUNTY	ROUTE	POST MILES TOTAL PROJECT	SHEET No.	TOTAL SHEETS
07	LA	5,10,14 47,60, etc.	Var	31	72
<i>N. Celina Aviles</i> REGISTERED CIVIL ENGINEER			8/30/12	DATE	
10-22-12 PLANS APPROVAL DATE					
THE STATE OF CALIFORNIA OR ITS OFFICERS OR AGENTS SHALL NOT BE RESPONSIBLE FOR THE ACCURACY OR COMPLETENESS OF SCANNED COPIES OF THIS PLAN SHEET.					

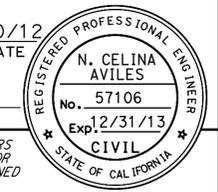

NOTES:




- FOR ACCURATE RIGHT OF WAY AND ACCESS DATA, CONTACT RIGHT OF WAY ENGINEERING AT THE DISTRICT OFFICE.
- LOCATIONS OF UTILITY FACILITIES SHOWN ARE APPROXIMATE AND SHALL BE VERIFIED BY THE CONTRACTOR PRIOR TO CONSTRUCTION.

ABBREVIATIONS:

- ACD = ASBESTOS CEMENT DUCT
 CI = CAST IRON
 CEM = CEMENT CONDUCT
 MCD = MULTIPLE CONCRETE DUCT
 PT&T = PACIFIC TELEPHONE AND TELEGRAPH COMPANY
 PWC = PARK WATER COMPANY
 SCG = SOUTHERN CALIFORNIA GAS COMPANY
 M = MEDIUM PRESURE

LEGEND:

SLOPE PAVING (CONCRETE)

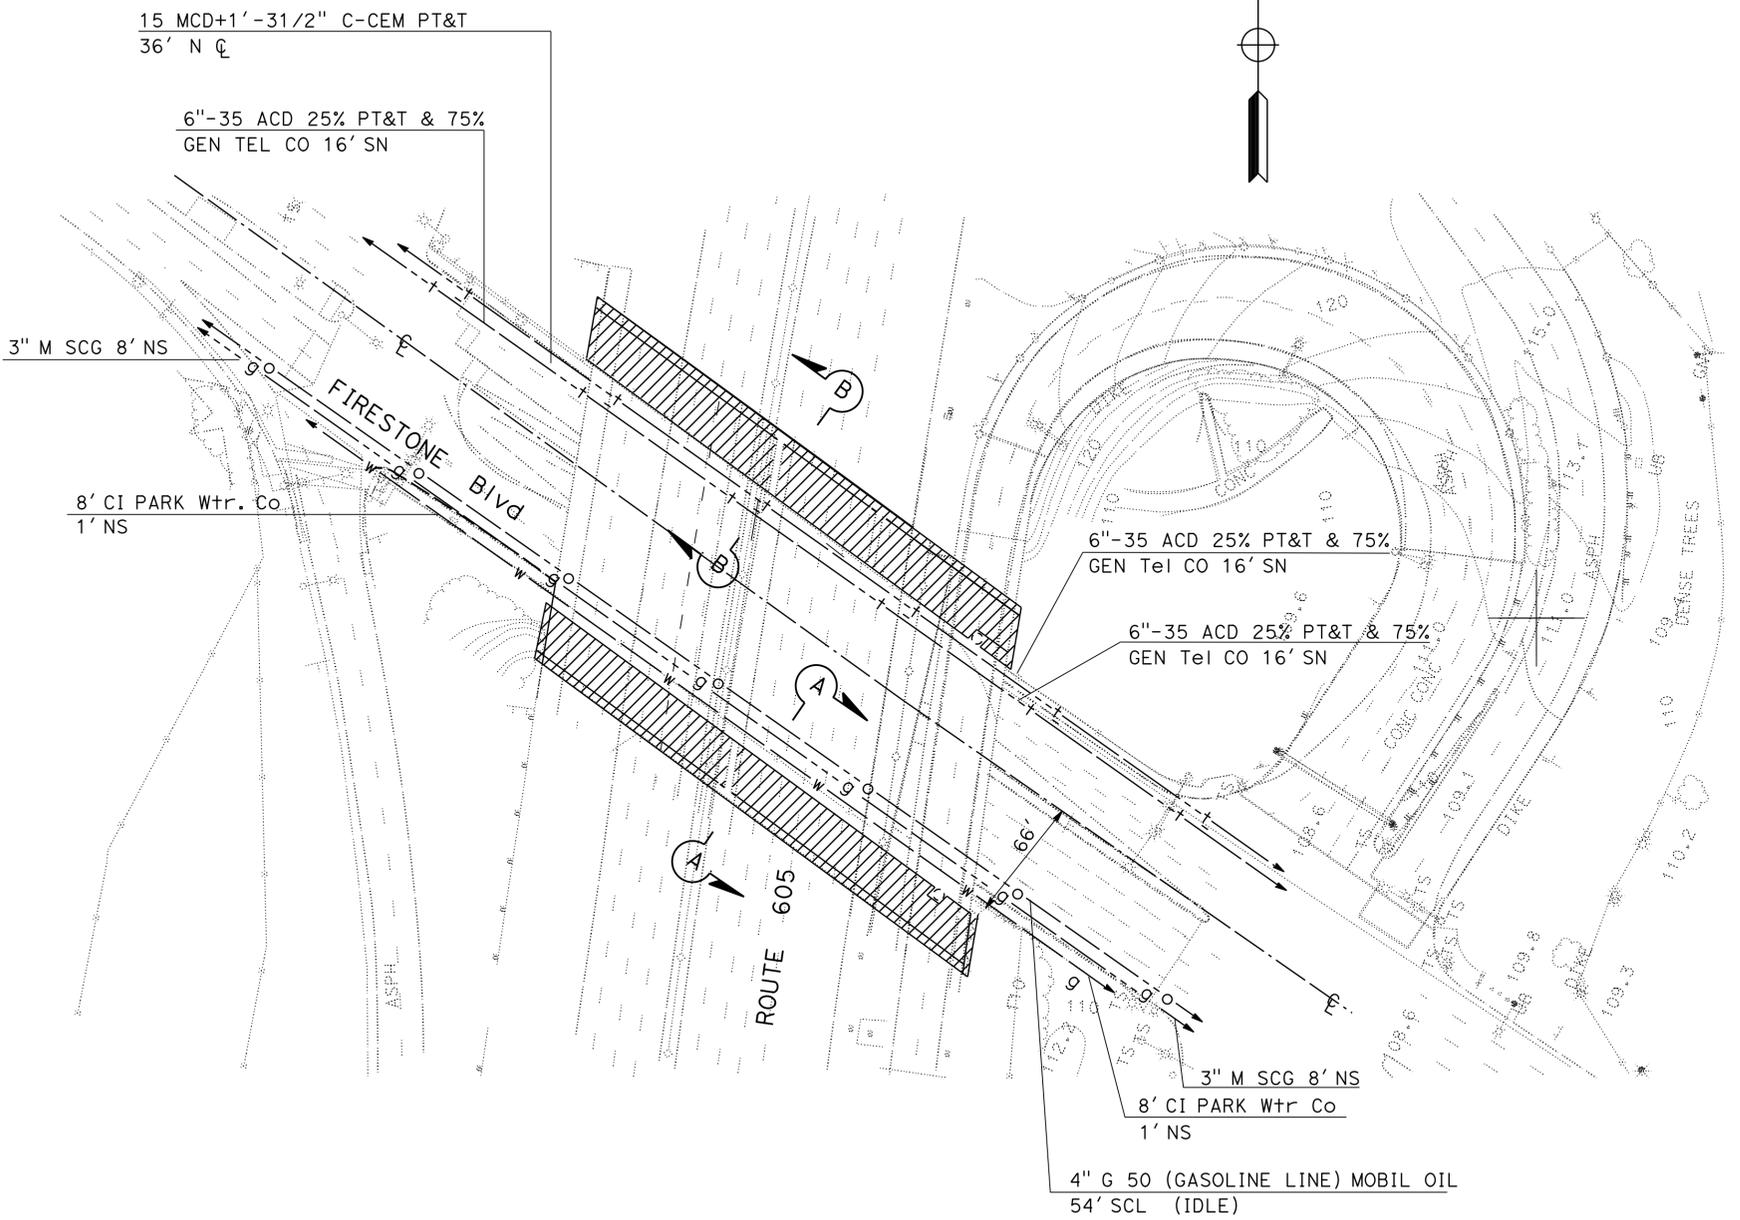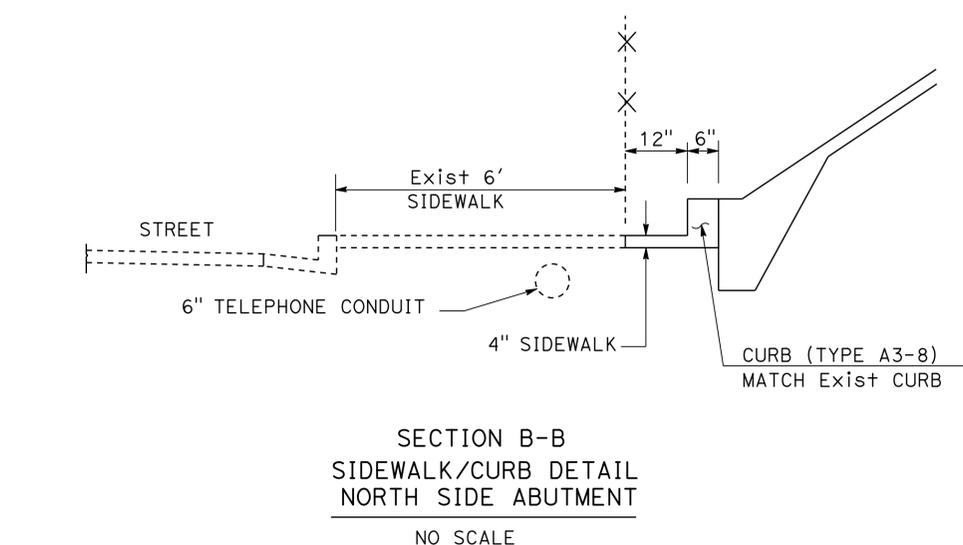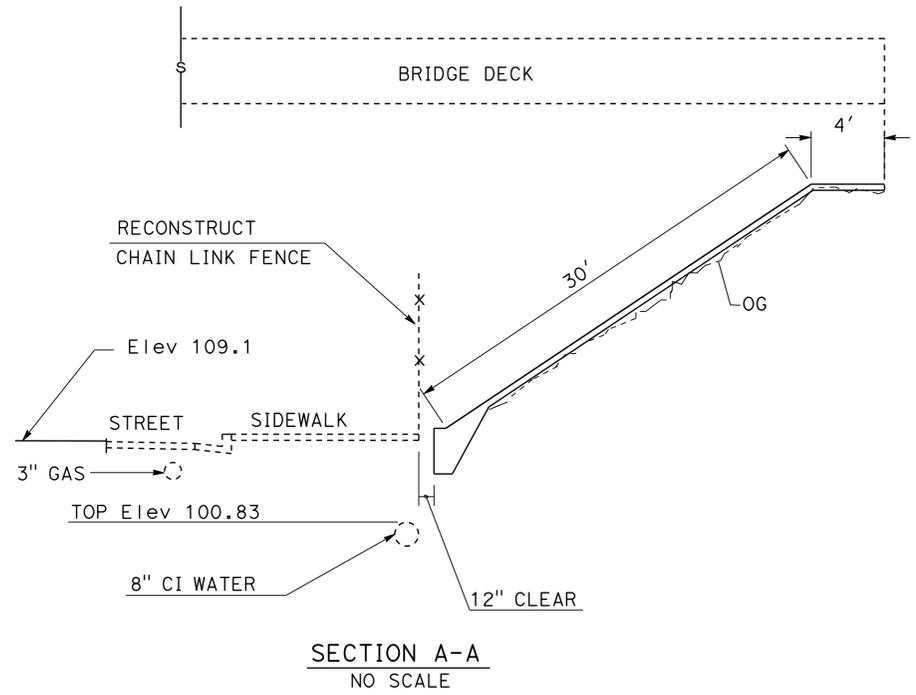

LOCATION No. 16
 Rte 605 NB AT FIRESTONE Blvd
 PM 8.4

UTILITY PLAN

SCALE: 1" = 50'

U-1

APPROVED FOR UTILITY INFORMATION ONLY.

STATE OF CALIFORNIA - DEPARTMENT OF TRANSPORTATION	FUNCTIONAL SUPERVISOR	REVISOR	DATE
Caltrans OFFICE OF DESIGN D	KAREN FONG	NARENDRA DESAI	
	CHECKED BY	REFUGIO DOMINGUEZ	
	DESIGNED BY		

USERNAME => s125624
 DGN FILE => 725880ka001.dgn



UNIT 1819

PROJECT NUMBER & PHASE

07000201951

BORDER LAST REVISED 7/2/2010

LAST REVISION DATE PLOTTED => 02-JAN-2013
 00-00-00 TIME PLOTTED => 19:23

STATE OF CALIFORNIA - DEPARTMENT OF TRANSPORTATION
Caltrans OFFICE OF DESIGN D
 FUNCTIONAL SUPERVISOR: KAREN FONG
 CALCULATED/DESIGNED BY: NARENDRA DESAI
 CHECKED BY: REFUGIO DOMINGUEZ
 REVISED BY: NARENDRA DESAI
 DATE REVISED: REFUGIO DOMINGUEZ

NOTES:

1. FOR ACCURATE RIGHT OF WAY AND ACCESS DATA, CONTACT RIGHT OF WAY ENGINEERING AT THE DISTRICT OFFICE.
2. LOCATIONS OF UTILITY FACILITIES SHOWN ARE APPROXIMATE AND SHALL BE VERIFIED BY THE CONTRACTOR PRIOR TO CONSTRUCTION
3. DURING CONSTRUCTION, THE CONTRACTOR WILL PROTECT THE OVERHEAD LINES FROM CONSTRUCTION EQUIPMENT.

LEGEND:

 SLOPE PAVING (CONCRETE)



Dist	COUNTY	ROUTE	POST MILES TOTAL PROJECT	SHEET No.	TOTAL SHEETS
07	LA	5,10,14, 47,60,etc.	Var	32	72

M. Celina Aviles 8/30/12
 REGISTERED CIVIL ENGINEER DATE

10-22-12
 PLANS APPROVAL DATE

N. CELINA AVILES
 No. 57106
 Exp. 12/31/13
 CIVIL
 STATE OF CALIFORNIA

THE STATE OF CALIFORNIA OR ITS OFFICERS OR AGENTS SHALL NOT BE RESPONSIBLE FOR THE ACCURACY OR COMPLETENESS OF SCANNED COPIES OF THIS PLAN SHEET.

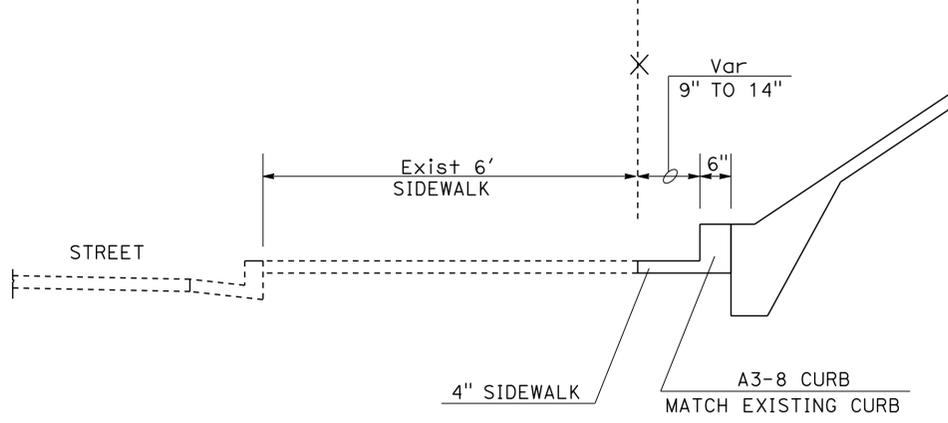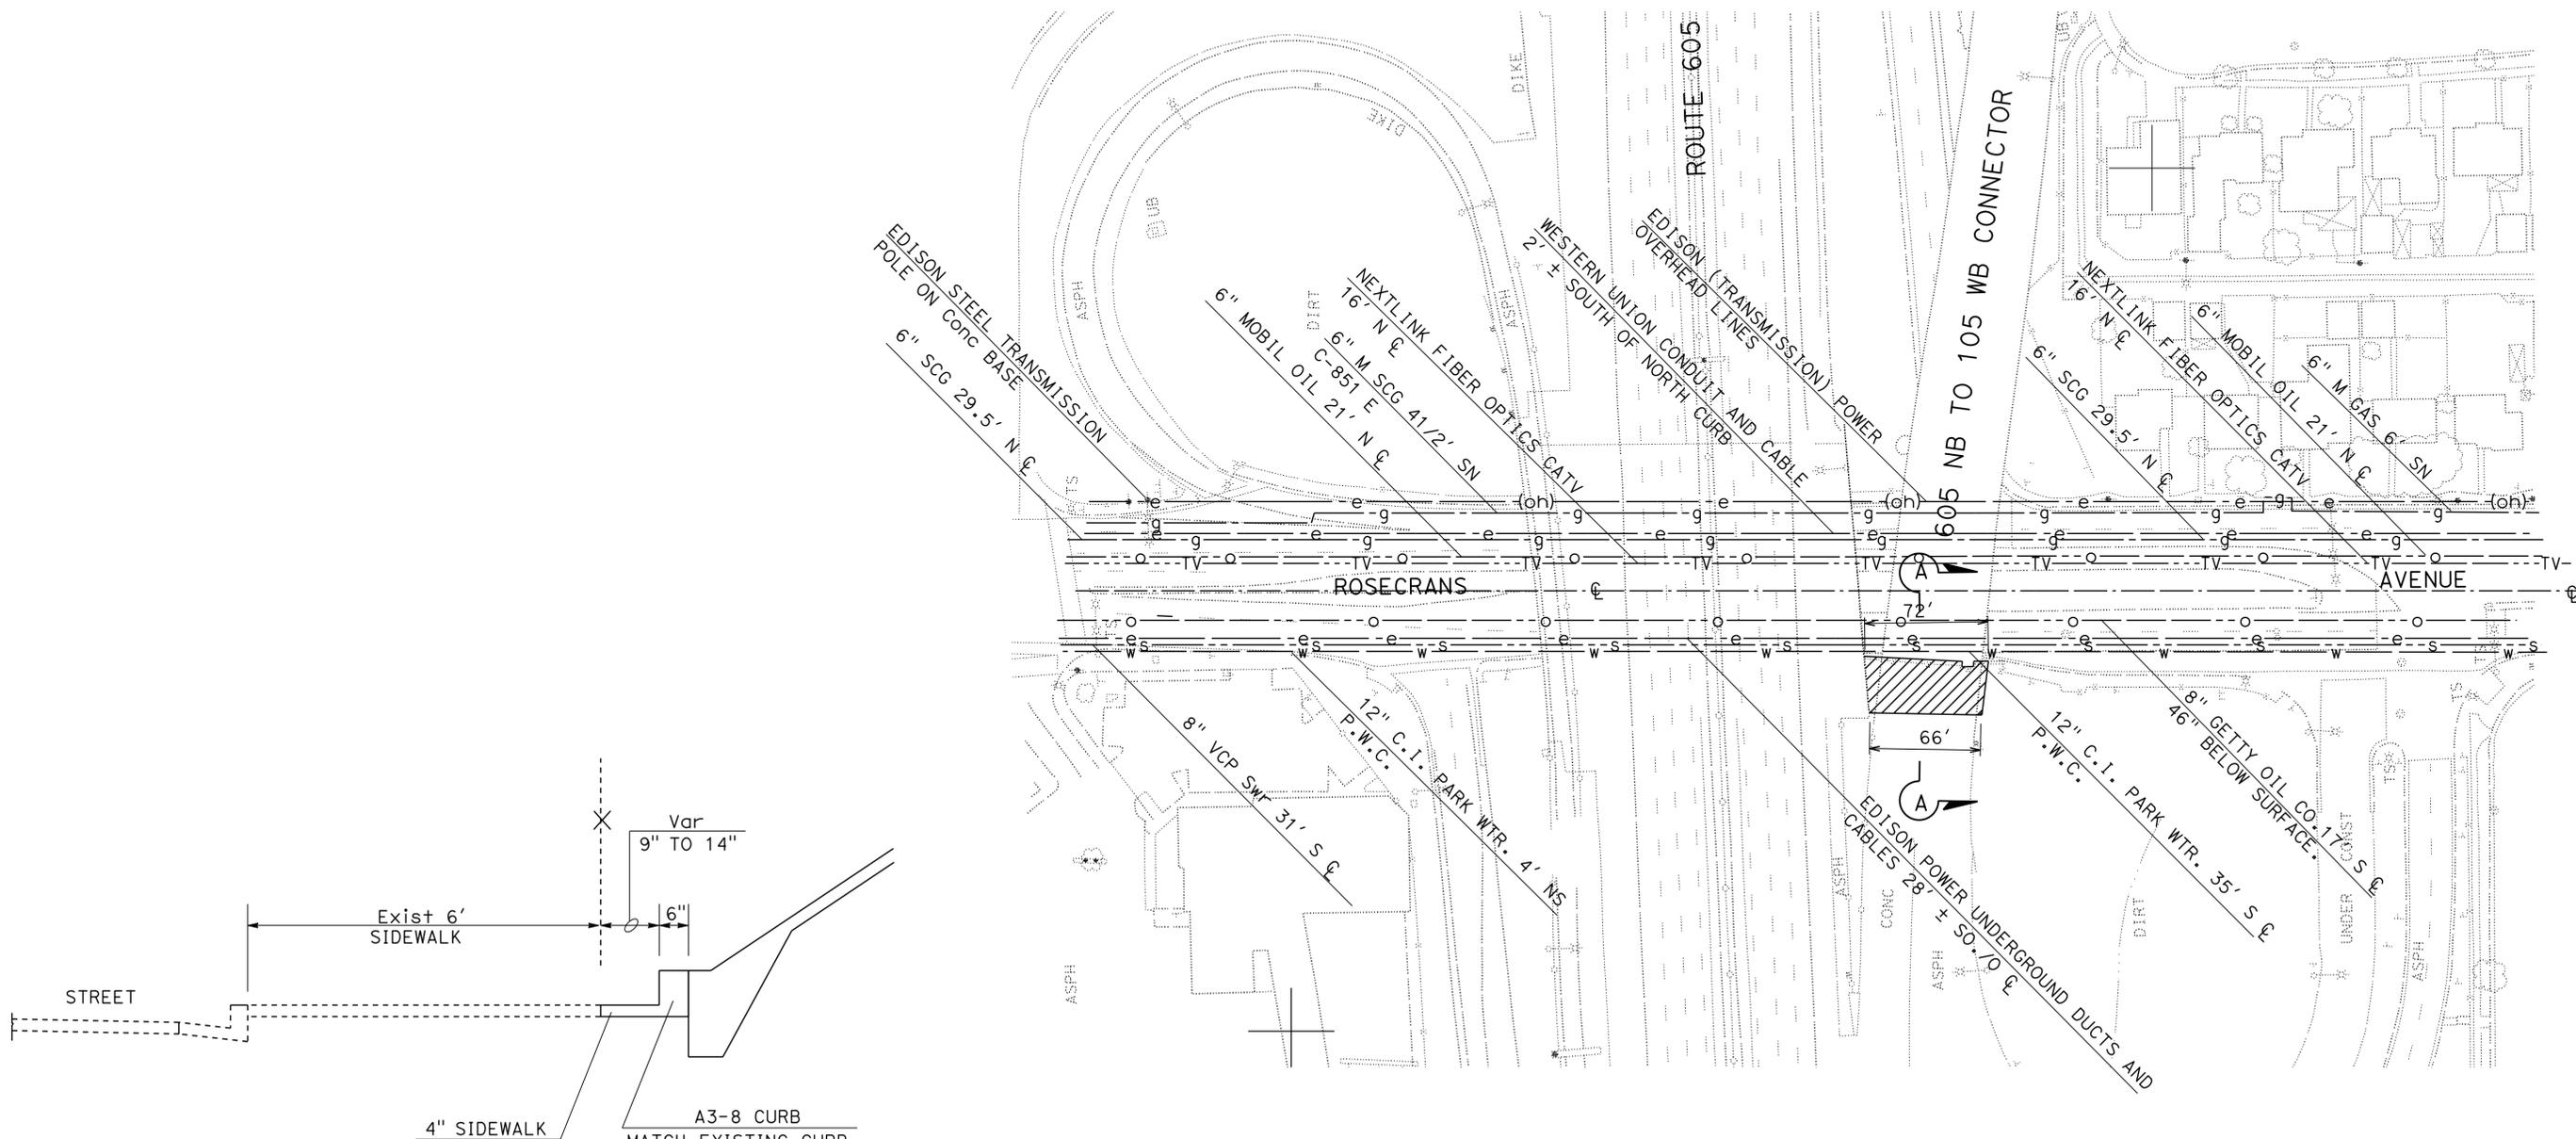

LOCATION No. 17
 Rte 605 NB AT ROSECRANS AVENUE
 PM 6.8

UTILITY PLAN
 SCALE: 1"=50'
U-2

APPROVED FOR UTILITY INFORMATION ONLY.

Dist	COUNTY	ROUTE	POST MILES TOTAL PROJECT	SHEET No.	TOTAL SHEETS
07	LA	5,10,14, 47,60,etc.	Var	33	72

REGISTERED CIVIL ENGINEER DATE 8-30-12
 REFUGIO DOMINGUEZ
 No. 50820
 Exp. 9/30/13
 CIVIL
 STATE OF CALIFORNIA

10-22-12
 PLANS APPROVAL DATE

THE STATE OF CALIFORNIA OR ITS OFFICERS OR AGENTS SHALL NOT BE RESPONSIBLE FOR THE ACCURACY OR COMPLETENESS OF SCANNED COPIES OF THIS PLAN SHEET.

NOTES:



- SIGN LOCATIONS SHOWN ARE APPROXIMATE. EXACT LOCATIONS WILL BE DETERMINED BY THE ENGINEER.
- FOR ADDITIONAL CONSTRUCTION AREA SIGNS INFORMATION, SEE TRAFFIC HANDLING DETAILS.

STATIONARY MOUNTED CONSTRUCTION AREA SIGNS

SIGN No. (X)	SIGN CODE	PANEL SIZE	SIGN MESSAGE	POST No. & SIZE	No. OF SIGNS
A	C40(CA)	144" X 60"	TRAFFIC FINES DOUBLED IN CONSTRUCTION ZONES	2 - 6" X 6"	
B	W20-1	48" X 48"	ROAD WORK AHEAD	1 - 4" X 6"	
C	G20-2	48" X 24"	END ROAD WORK	1 - 4" X 6"	
D	C40(CA)	108" X 42"	TRAFFIC FINES DOUBLED IN CONSTRUCTION ZONES	1 - 4" X 6"	4
E	W20-1	36" X 36"	ROAD WORK AHEAD	1 - 4" X 6"	4
F	G20-2	36" X 18"	END ROAD WORK	1 - 4" X 6"	4
TOTAL					12

LOCATION 17

LOCATION 16

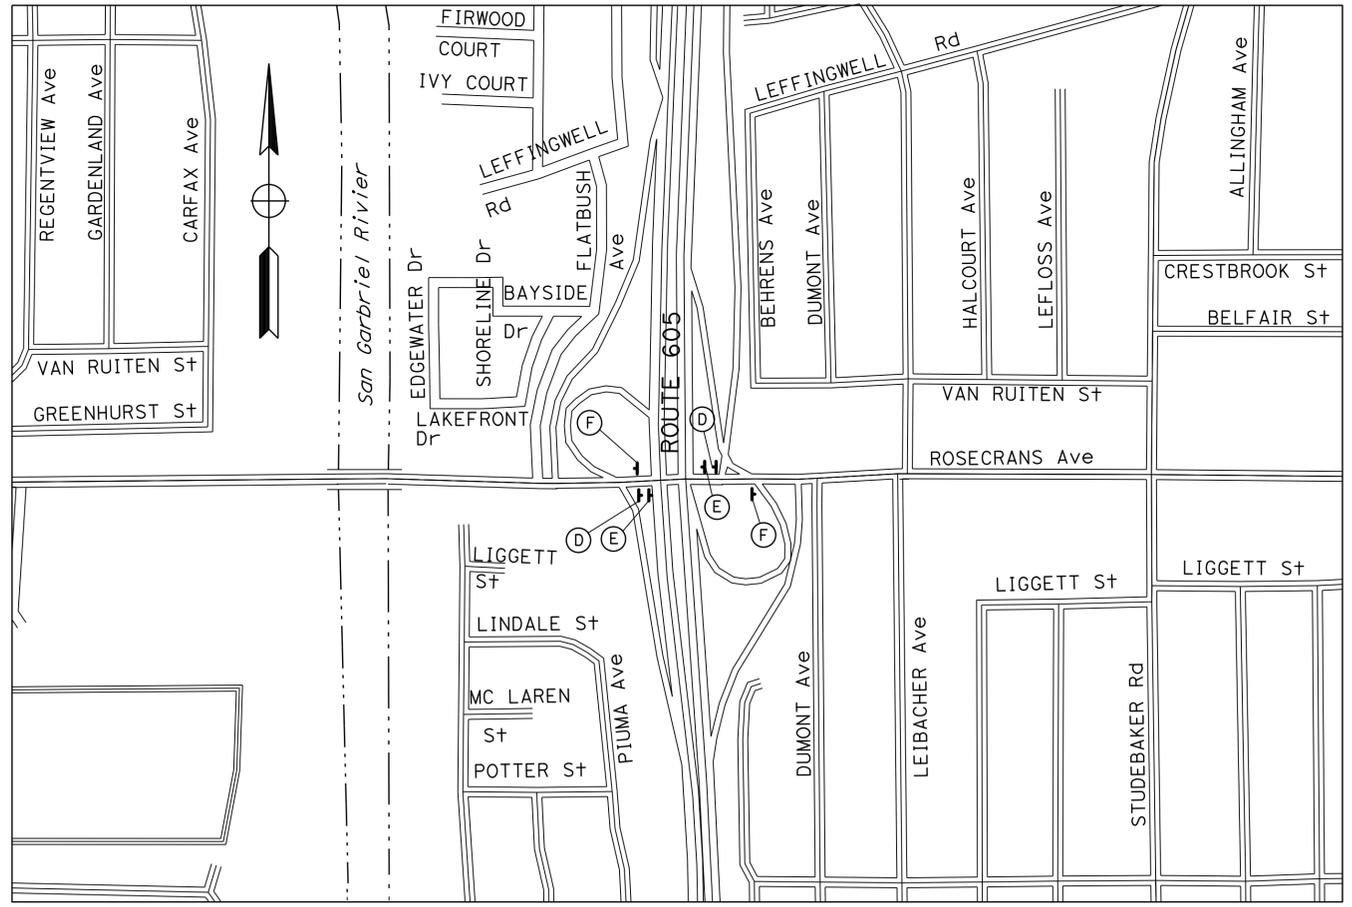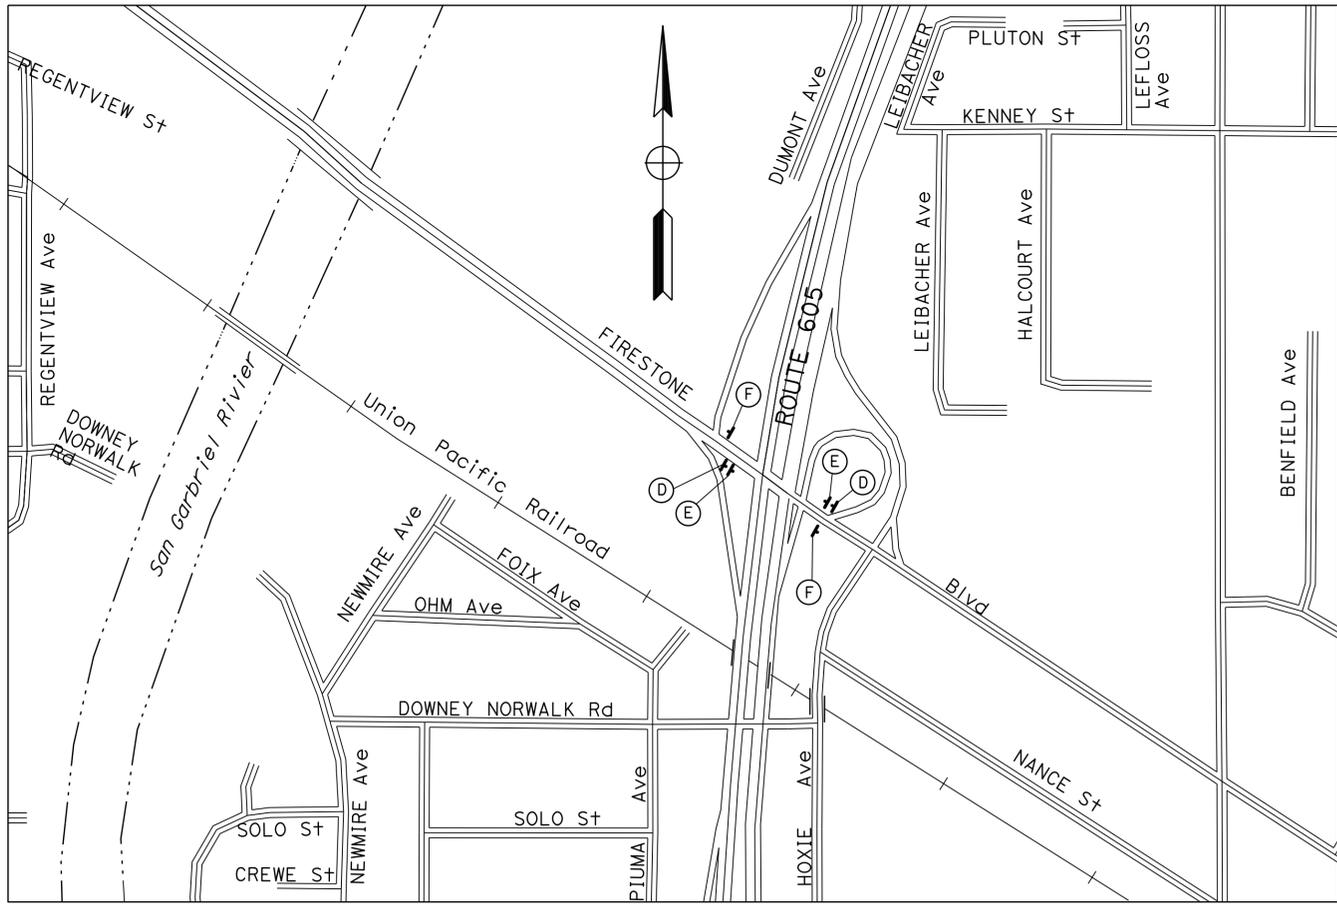

CONSTRUCTION AREA SIGNS

NO SCALE

CS-1

APPROVED FOR CONSTRUCTION AREA SIGNS WORK ONLY.

STATE OF CALIFORNIA - DEPARTMENT OF TRANSPORTATION - OFFICE OF DESIGN D
 KAREN FONG
 FUNCTIONAL SUPERVISOR
 CHECKED BY
 NARENDRA DESAI
 REVISOR
 REFUGIO DOMINGUEZ
 DATE REVISOR

LAST REVISION DATE PLOTTED => 02-JAN-2013
 00-00-00 TIME PLOTTED => 19:23

Dist	COUNTY	ROUTE	POST MILES TOTAL PROJECT	SHEET No.	TOTAL SHEETS
07	LA	5,10,14, 47,60,etc.	Var	34	65

Refugio Dominguez 8-30-12
 REGISTERED CIVIL ENGINEER DATE
 10-22-12
 PLANS APPROVAL DATE

REGISTERED PROFESSIONAL ENGINEER
 REFUGIO DOMINGUEZ
 No. 50820
 Exp. 9/30/13
 CIVIL
 STATE OF CALIFORNIA

THE STATE OF CALIFORNIA OR ITS OFFICERS OR AGENTS SHALL NOT BE RESPONSIBLE FOR THE ACCURACY OR COMPLETENESS OF SCANNED COPIES OF THIS PLAN SHEET.


NOTES:

- SIGN LOCATIONS SHOWN ARE APPROXIMATE. EXACT LOCATIONS WILL BE DETERMINED BY THE ENGINEER.
- FOR ADDITIONAL CONSTRUCTION AREA SIGNS INFORMATION, SEE TRAFFIC HANDLING DETAILS.

STATIONARY MOUNTED CONSTRUCTION AREA SIGNS

SIGN No. (X)	SIGN CODE	PANEL SIZE	SIGN MESSAGE	POST No. & SIZE	No. OF SIGNS
A	C40(CA)	144" X 60"	TRAFFIC FINES DOUBLED IN CONSTRUCTION ZONES	2 - 6" X 6"	1
B	W20-1	48" X 48"	ROAD WORK AHEAD	1 - 4" X 6"	1
C	G20-2	48" X 24"	END ROAD WORK	1 - 4" X 6"	1
TOTAL					3

LOCATION 18

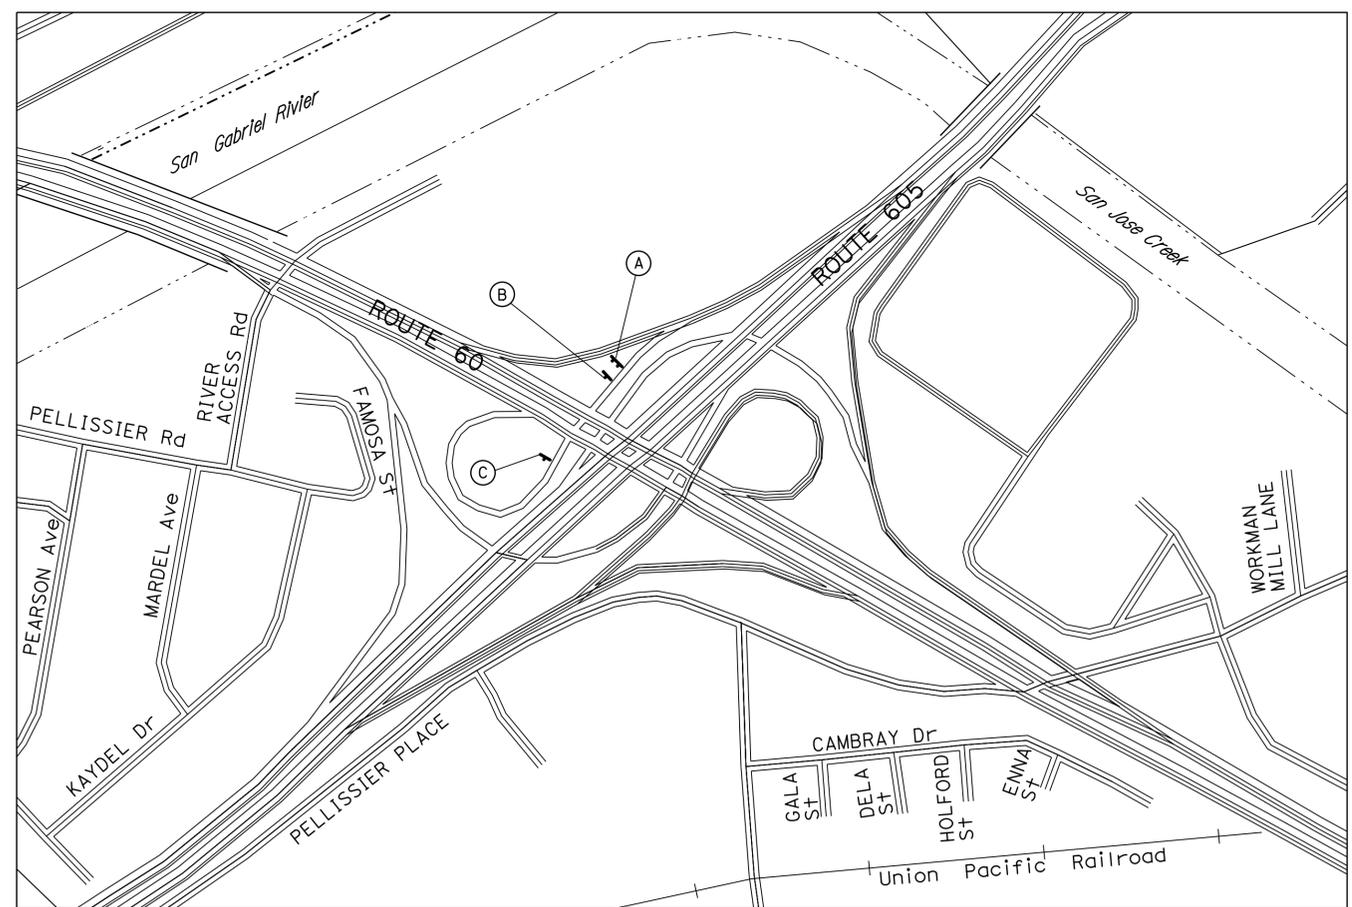

CONSTRUCTION AREA SIGNS

NO SCALE

CS-2

APPROVED FOR CONSTRUCTION AREA SIGNS WORK ONLY.

STATE OF CALIFORNIA - DEPARTMENT OF TRANSPORTATION
Caltrans OFFICE OF DESIGN D
 FUNCTIONAL SUPERVISOR: KAREN FONG
 CALCULATED/DESIGNED BY: NARENDRA DESAI
 CHECKED BY: REFUGIO DOMINGUEZ
 REVISED BY: NARENDRA DESAI
 DATE REVISED: REFUGIO DOMINGUEZ

Dist	COUNTY	ROUTE	POST MILES TOTAL PROJECT	SHEET No.	TOTAL SHEETS
07	LA	5,10,14, 47,60,etc.	Var	35	72

Refugio Dominguez 8-30-12
 REGISTERED CIVIL ENGINEER DATE

10-22-12
 PLANS APPROVAL DATE

REGISTERED PROFESSIONAL ENGINEER
 REFUGIO DOMINGUEZ
 No. 50820
 Exp. 9/30/13
 CIVIL
 STATE OF CALIFORNIA

THE STATE OF CALIFORNIA OR ITS OFFICERS OR AGENTS SHALL NOT BE RESPONSIBLE FOR THE ACCURACY OR COMPLETENESS OF SCANNED COPIES OF THIS PLAN SHEET.

NOTES:



- SIGN LOCATIONS SHOWN ARE APPROXIMATE. EXACT LOCATIONS WILL BE DETERMINED BY THE ENGINEER.
- FOR ADDITIONAL CONSTRUCTION AREA SIGNS INFORMATION, SEE TRAFFIC HANDLING DETAILS.

STATIONARY MOUNTED CONSTRUCTION AREA SIGNS

SIGN No. (X)	SIGN CODE	PANEL SIZE	SIGN MESSAGE	POST No. & SIZE	No. OF SIGNS
A	C40(CA)	144" X 60"	TRAFFIC FINES DOUBLED IN CONSTRUCTION ZONES	2 - 6" X 6"	
B	W20-1	48" X 48"	ROAD WORK AHEAD	1 - 4" X 6"	
C	G20-2	48" X 24"	END ROAD WORK	1 - 4" X 6"	
D	C40(CA)	108" X 42"	TRAFFIC FINES DOUBLED IN CONSTRUCTION ZONES	1 - 4" X 6"	2
E	W20-1	36" X 36"	ROAD WORK AHEAD	1 - 4" X 6"	2
F	G20-2	36" X 18"	END ROAD WORK	1 - 4" X 6"	3
TOTAL					7

LOCATION 15

LOCATION 6

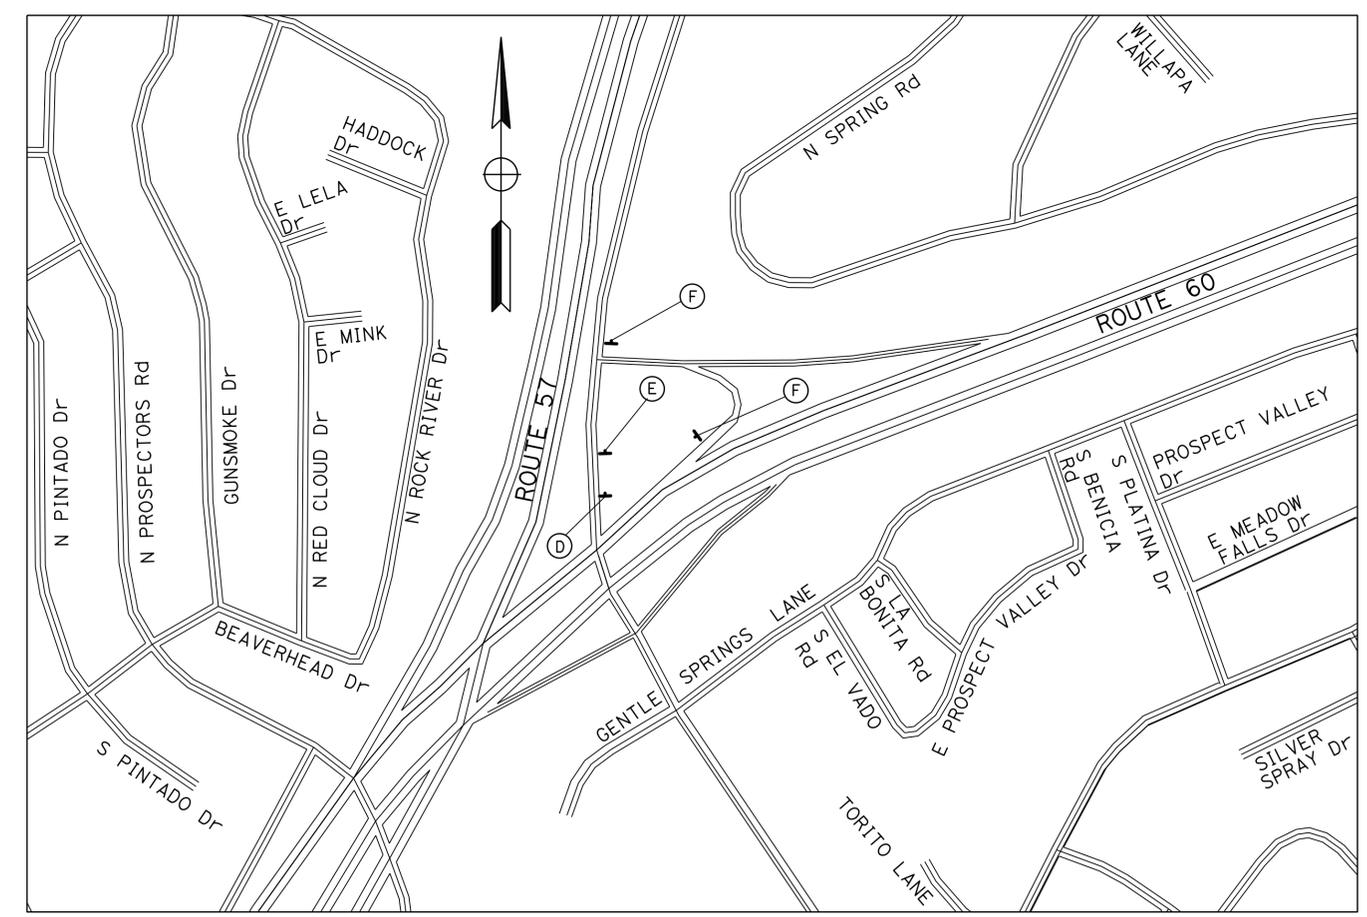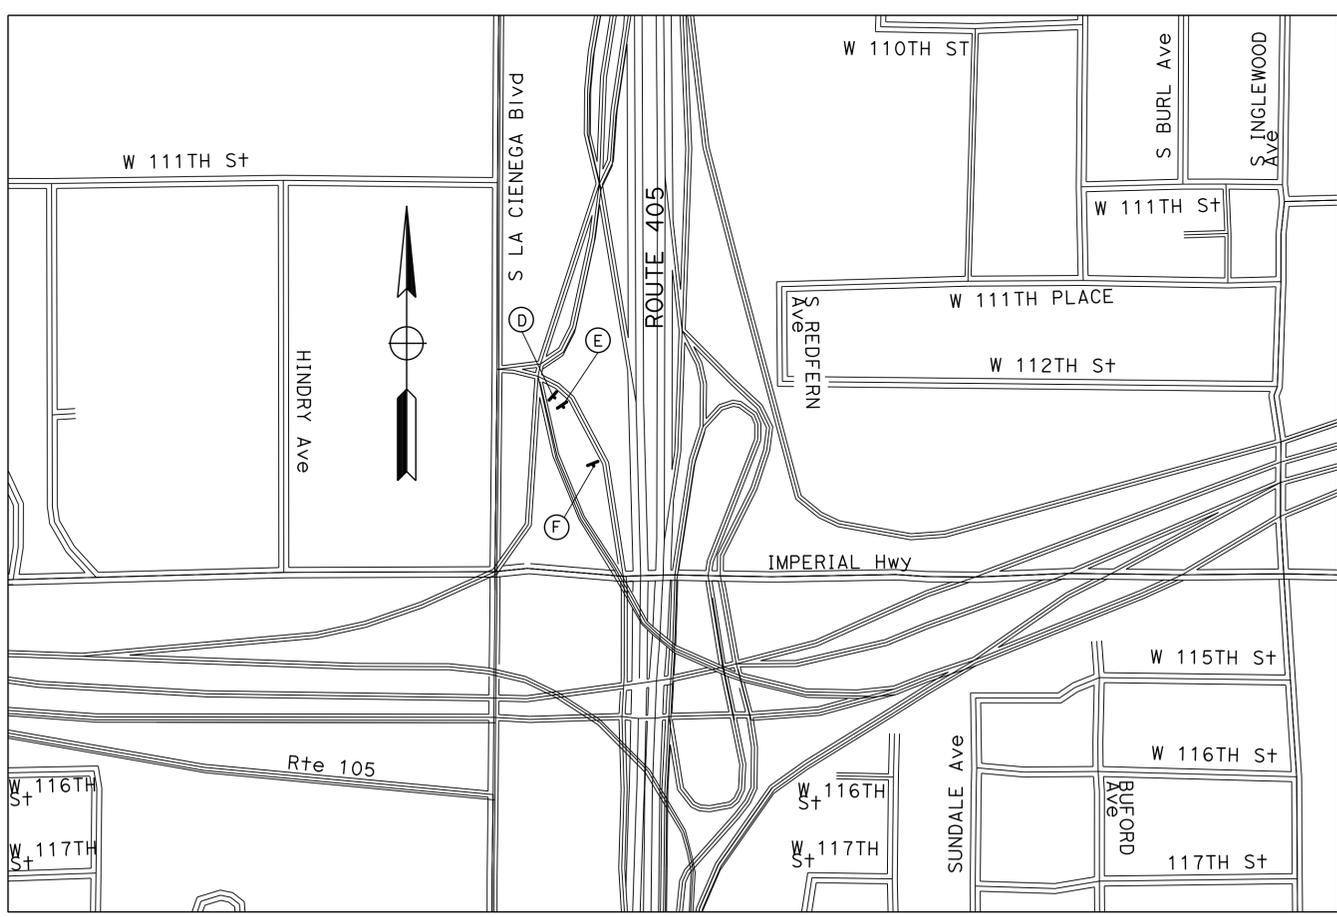

CONSTRUCTION AREA SIGNS
NO SCALE

CS-3

APPROVED FOR CONSTRUCTION AREA SIGNS WORK ONLY.

STATE OF CALIFORNIA - DEPARTMENT OF TRANSPORTATION
Caltrans OFFICE OF DESIGN D
 FUNCTIONAL SUPERVISOR: KAREN FONG
 CALCULATED/DESIGNED BY: NARENDRA DESAI
 CHECKED BY: REFUGIO DOMINGUEZ
 REVISED BY: REFUGIO DOMINGUEZ
 DATE REVISED:

Dist	COUNTY	ROUTE	POST MILES TOTAL PROJECT	SHEET No.	TOTAL SHEETS
07	LA	5,10,14, 47,60,etc.	Var	36	72

8-30-12
 REGISTERED CIVIL ENGINEER DATE
 REFUGIO DOMINGUEZ
 No. 50820
 Exp. 9/30/13
 CIVIL
 STATE OF CALIFORNIA

10-22-12
 PLANS APPROVAL DATE

THE STATE OF CALIFORNIA OR ITS OFFICERS OR AGENTS SHALL NOT BE RESPONSIBLE FOR THE ACCURACY OR COMPLETENESS OF SCANNED COPIES OF THIS PLAN SHEET.


NOTES:

- SIGN LOCATIONS SHOWN ARE APPROXIMATE. EXACT LOCATIONS WILL BE DETERMINED BY THE ENGINEER.
- FOR ADDITIONAL CONSTRUCTION AREA SIGNS INFORMATION, SEE TRAFFIC HANDLING DETAILS.


STATIONARY MOUNTED CONSTRUCTION AREA SIGNS

SIGN No. (X)	SIGN CODE	PANEL SIZE	SIGN MESSAGE	POST No. & SIZE	No. OF SIGNS
A	C40(CA)	144" X 60"	TRAFFIC FINES DOUBLED IN CONSTRUCTION ZONES	2 - 6" X 6"	1
B	W20-1	48" X 48"	ROAD WORK AHEAD	1 - 4" X 6"	1
C	G20-2	48" X 24"	END ROAD WORK	1 - 4" X 6"	1
D	C40(CA)	108" X 42"	TRAFFIC FINES DOUBLED IN CONSTRUCTION ZONES	1 - 4" X 6"	3
E	W20-1	36" X 36"	ROAD WORK AHEAD	1 - 4" X 6"	3
F	G20-2	36" X 18"	END ROAD WORK	1 - 4" X 6"	3
TOTAL					12

LOCATION 7

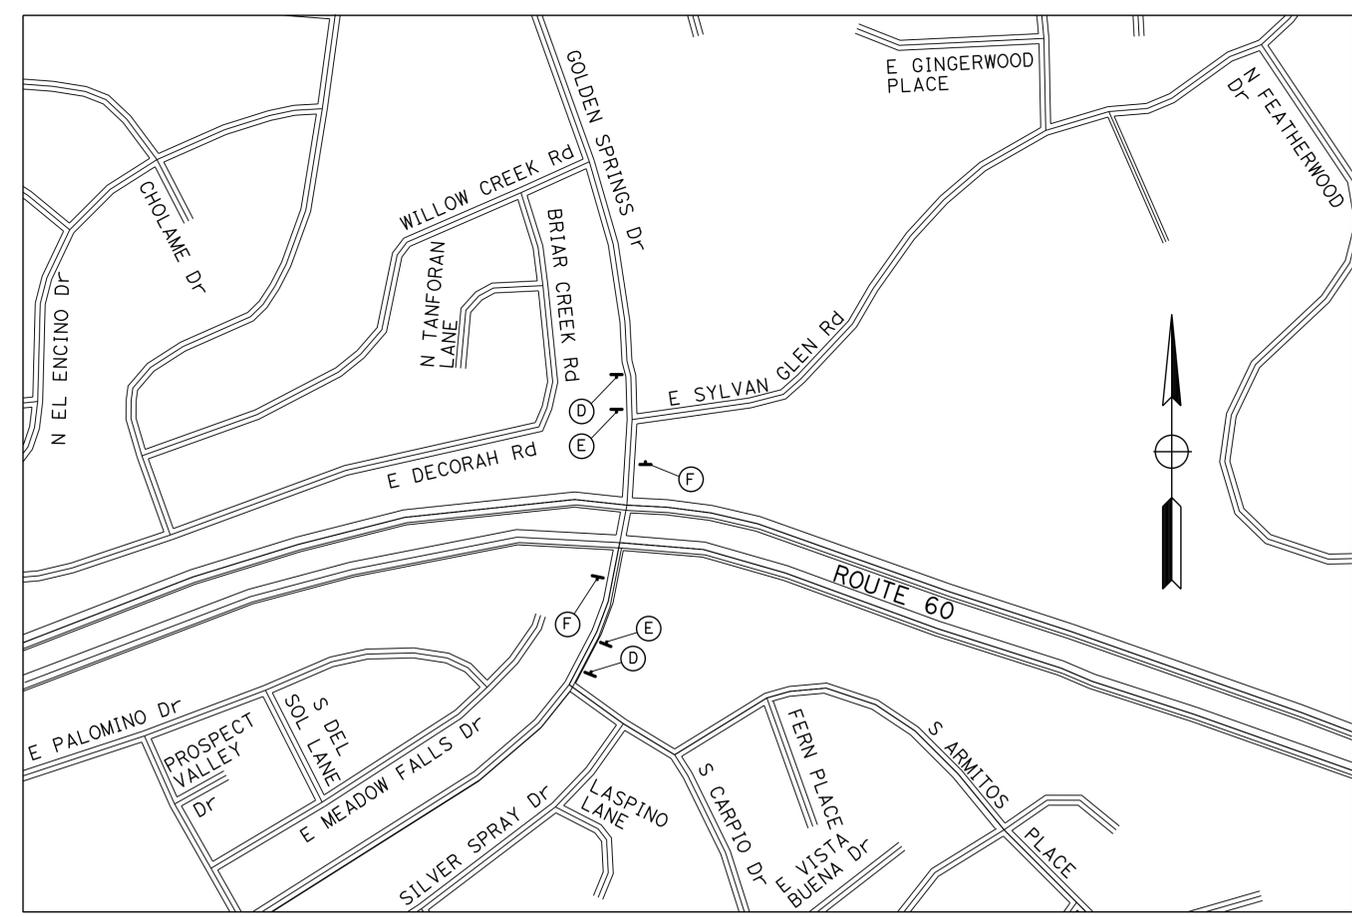

LOCATIONS 8 AND 9

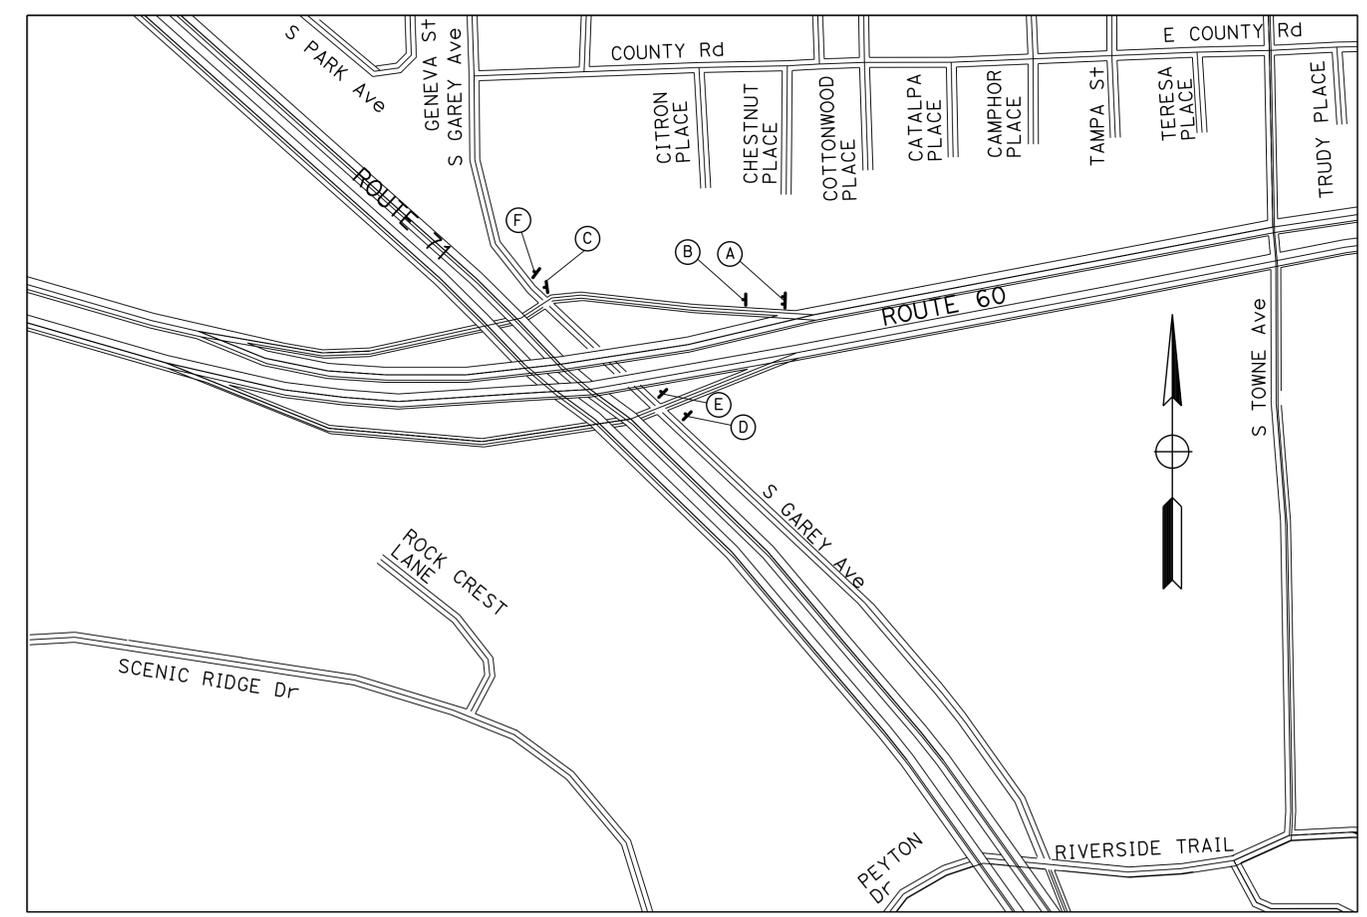

CONSTRUCTION AREA SIGNS

NO SCALE

CS-4

APPROVED FOR CONSTRUCTION AREA SIGNS WORK ONLY

STATE OF CALIFORNIA - DEPARTMENT OF TRANSPORTATION - OFFICE OF DESIGN D
 KAREN FONG
 FUNCTIONAL SUPERVISOR
 CHECKED BY
 NARENDRA DESAI
 REVISOR
 REFUGIO DOMINGUEZ
 DATE REVISOR

Dist	COUNTY	ROUTE	POST MILES TOTAL PROJECT	SHEET No.	TOTAL SHEETS
07	LA	5,10,14, 47,60,etc.	Var	37	72

Refugio Dominguez 8-30-12
 REGISTERED CIVIL ENGINEER DATE
 10-22-12
 PLANS APPROVAL DATE

REGISTERED PROFESSIONAL ENGINEER
 REFUGIO DOMINGUEZ
 No. 50820
 Exp. 9/30/13
 CIVIL
 STATE OF CALIFORNIA

THE STATE OF CALIFORNIA OR ITS OFFICERS OR AGENTS SHALL NOT BE RESPONSIBLE FOR THE ACCURACY OR COMPLETENESS OF SCANNED COPIES OF THIS PLAN SHEET.


NOTES:

- SIGN LOCATIONS SHOWN ARE APPROXIMATE. EXACT LOCATIONS WILL BE DETERMINED BY THE ENGINEER.
- FOR ADDITIONAL CONSTRUCTION AREA SIGNS INFORMATION, SEE TRAFFIC HANDLING DETAILS.

STATIONARY MOUNTED CONSTRUCTION AREA SIGNS

SIGN No. (X)	SIGN CODE	PANEL SIZE	SIGN MESSAGE	POST No. & SIZE	No. OF SIGNS
A	C40(CA)	144" X 60"	TRAFFIC FINES DOUBLED IN CONSTRUCTION ZONES	2 - 6" X 6"	4
B	W20-1	48" X 48"	ROAD WORK AHEAD	1 - 4" X 6"	4
C	G20-2	48" X 24"	END ROAD WORK	1 - 4" X 6"	2
TOTAL					10

LOCATION 11

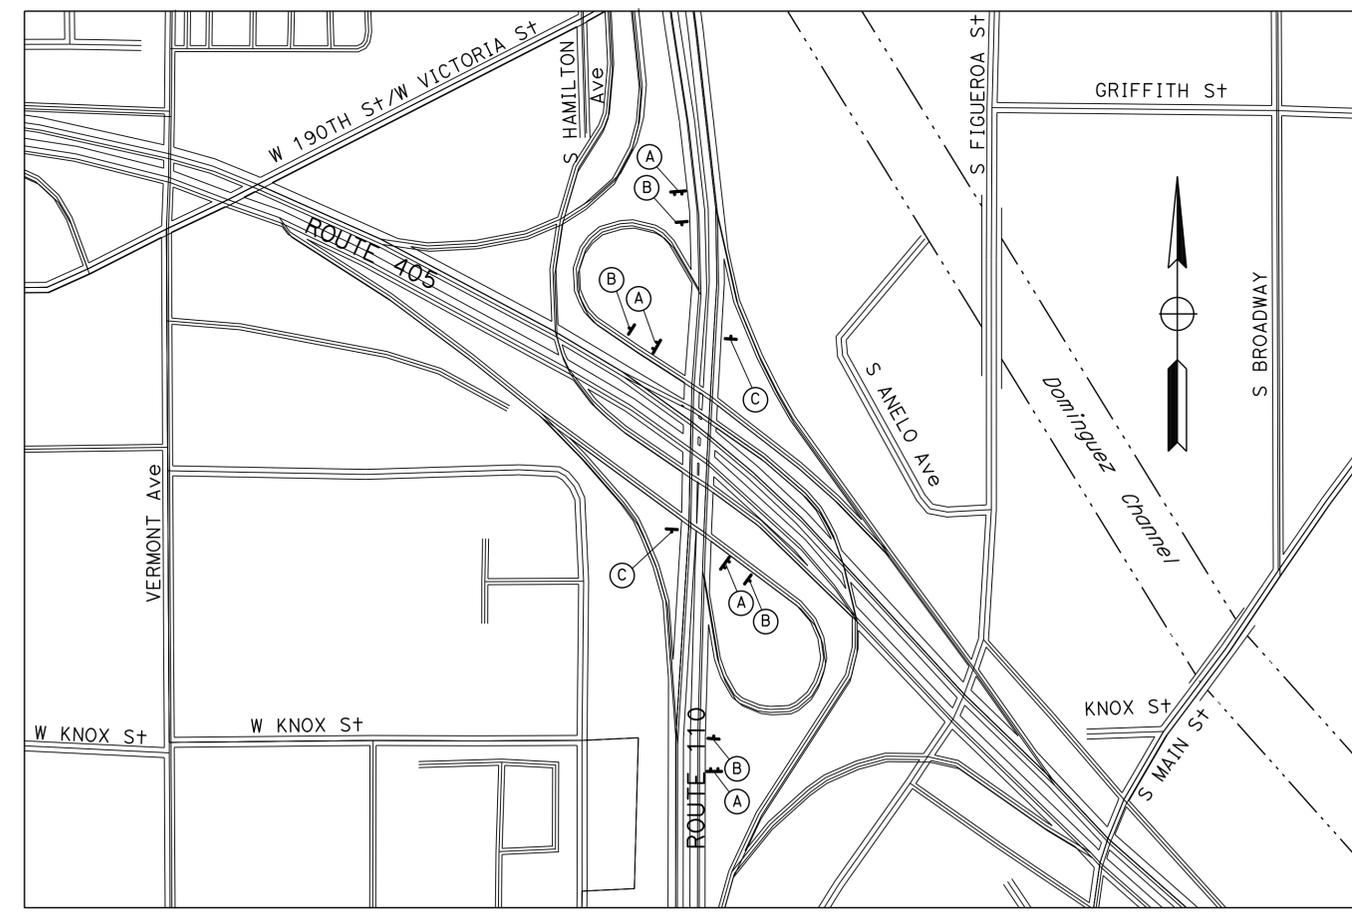

CONSTRUCTION AREA SIGNS
NO SCALE

CS-5

APPROVED FOR CONSTRUCTION AREA SIGNS WORK ONLY.

STATE OF CALIFORNIA - DEPARTMENT OF TRANSPORTATION
Caltrans OFFICE OF DESIGN D
 FUNCTIONAL SUPERVISOR: KAREN FONG
 CALCULATED/DESIGNED BY: NARENDRA DESAI
 CHECKED BY: REFUGIO DOMINGUEZ
 REVISED BY: NARENDRA DESAI
 DATE REVISED: REFUGIO DOMINGUEZ

Dist	COUNTY	ROUTE	POST MILES TOTAL PROJECT	SHEET No.	TOTAL SHEETS
07	LA	5,10,14, 47,60,etc.	Var	38	72

Refugio Dominguez 8-30-12
 REGISTERED CIVIL ENGINEER DATE
 10-22-12
 PLANS APPROVAL DATE

REGISTERED PROFESSIONAL ENGINEER
 REFUGIO DOMINGUEZ
 No. 50820
 Exp. 9/30/13
 CIVIL
 STATE OF CALIFORNIA

THE STATE OF CALIFORNIA OR ITS OFFICERS OR AGENTS SHALL NOT BE RESPONSIBLE FOR THE ACCURACY OR COMPLETENESS OF SCANNED COPIES OF THIS PLAN SHEET.

NOTES:



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STATIONARY MOUNTED CONSTRUCTION AREA SIGNS

SIGN No. (X)	SIGN CODE	PANEL SIZE	SIGN MESSAGE	POST No. & SIZE	No. OF SIGNS
A	C40(CA)	144" X 60"	TRAFFIC FINES DOUBLED IN CONSTRUCTION ZONES	2 - 6" X 6"	4
B	W20-1	48" X 48"	ROAD WORK AHEAD	1 - 4" X 6"	4
C	G20-2	48" X 24"	END ROAD WORK	1 - 4" X 6"	4
TOTAL					12

LOCATION 1

LOCATION 2

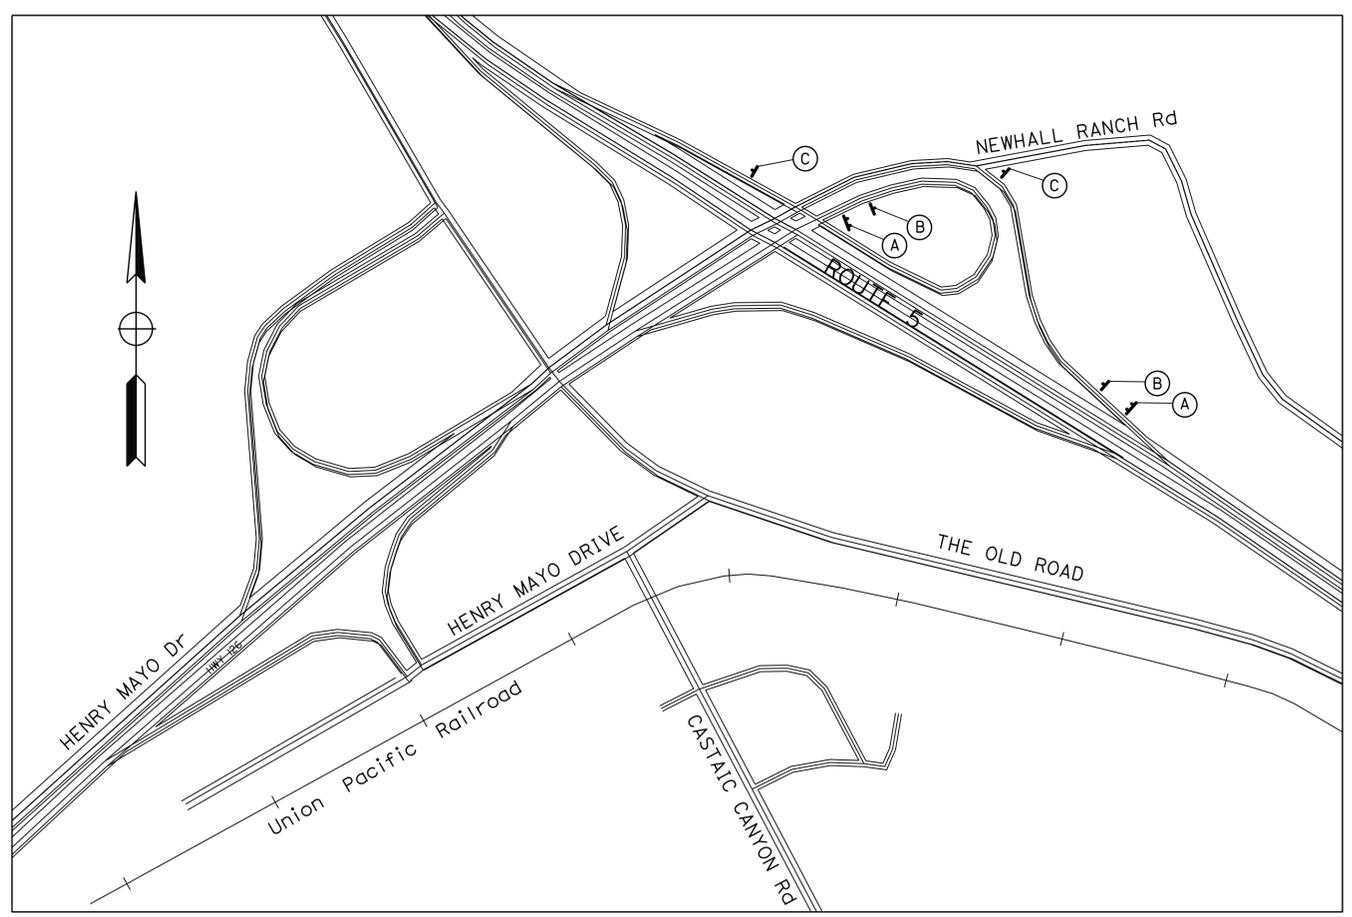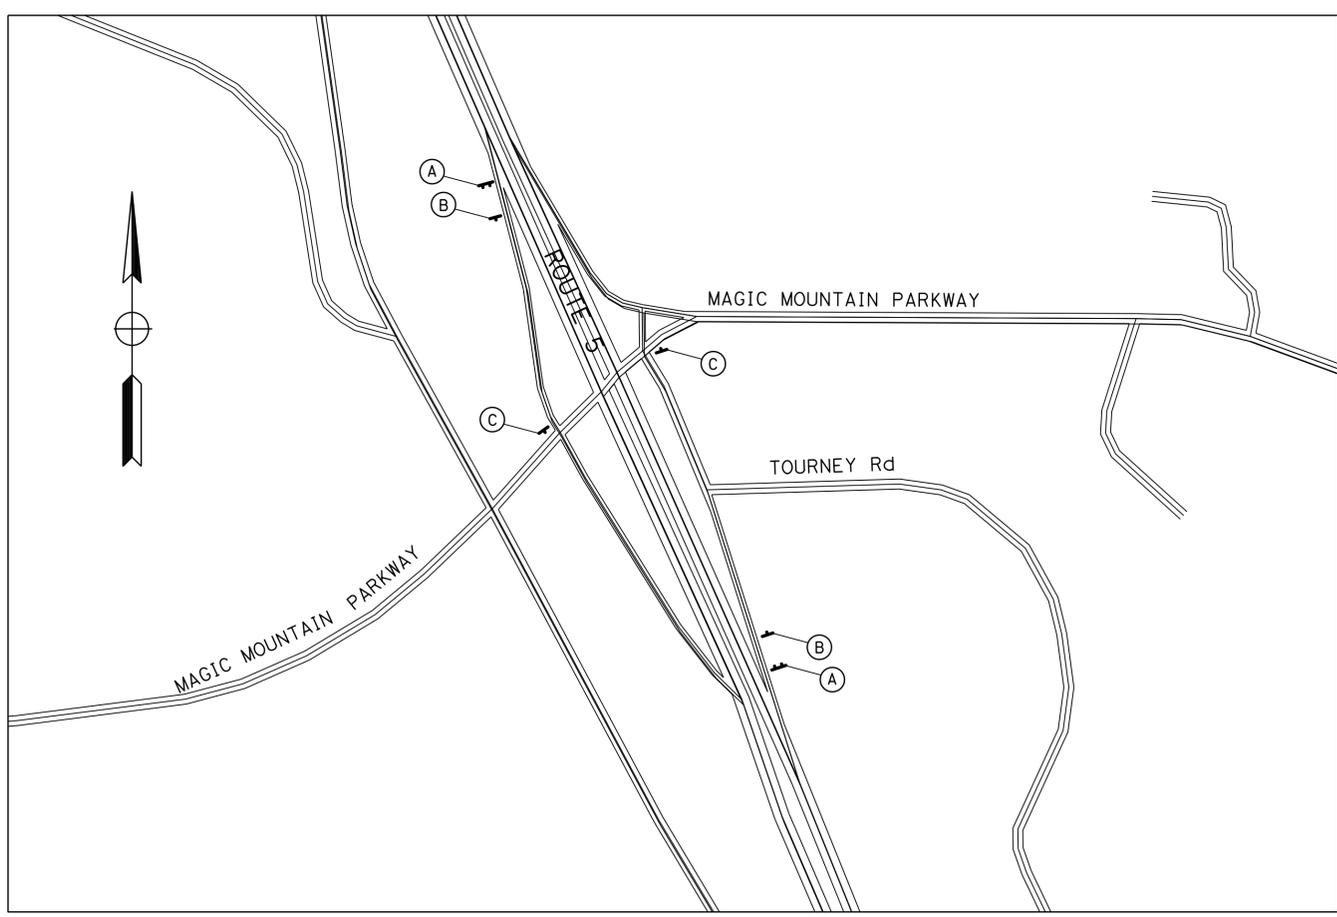

CONSTRUCTION AREA SIGNS

NO SCALE

CS-6

APPROVED FOR CONSTRUCTION AREA SIGNS WORK ONLY.

STATE OF CALIFORNIA - DEPARTMENT OF TRANSPORTATION
Caltrans OFFICE OF DESIGN D
 FUNCTIONAL SUPERVISOR: KAREN FONG
 CALCULATED/DESIGNED BY: NARENDRA DESAI
 CHECKED BY: REFUGIO DOMINGUEZ
 REVISED BY: REFUGIO DOMINGUEZ
 DATE REVISED:

Dist	COUNTY	ROUTE	POST MILES TOTAL PROJECT	SHEET No.	TOTAL SHEETS
07	LA	5,10,14, 47,60,etc.	Var	39	72

Refugio Dominguez 8-30-12
 REGISTERED CIVIL ENGINEER DATE
 10-22-12
 PLANS APPROVAL DATE

REGISTERED PROFESSIONAL ENGINEER
 REFUGIO DOMINGUEZ
 No. 50820
 Exp. 9/30/13
 CIVIL
 STATE OF CALIFORNIA

THE STATE OF CALIFORNIA OR ITS OFFICERS OR AGENTS SHALL NOT BE RESPONSIBLE FOR THE ACCURACY OR COMPLETENESS OF SCANNED COPIES OF THIS PLAN SHEET.

NOTES:



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STATIONARY MOUNTED CONSTRUCTION AREA SIGNS

SIGN No. (X)	SIGN CODE	PANEL SIZE	SIGN MESSAGE	POST No. & SIZE	No. OF SIGNS
A	C40(CA)	144" X 60"	TRAFFIC FINES DOUBLED IN CONSTRUCTION ZONES	2 - 6" X 6"	2
B	W20-1	48" X 48"	ROAD WORK AHEAD	1 - 4" X 6"	2
C	G20-2	48" X 24"	END ROAD WORK	1 - 4" X 6"	2
TOTAL					6

LOCATION 3

LOCATION 4

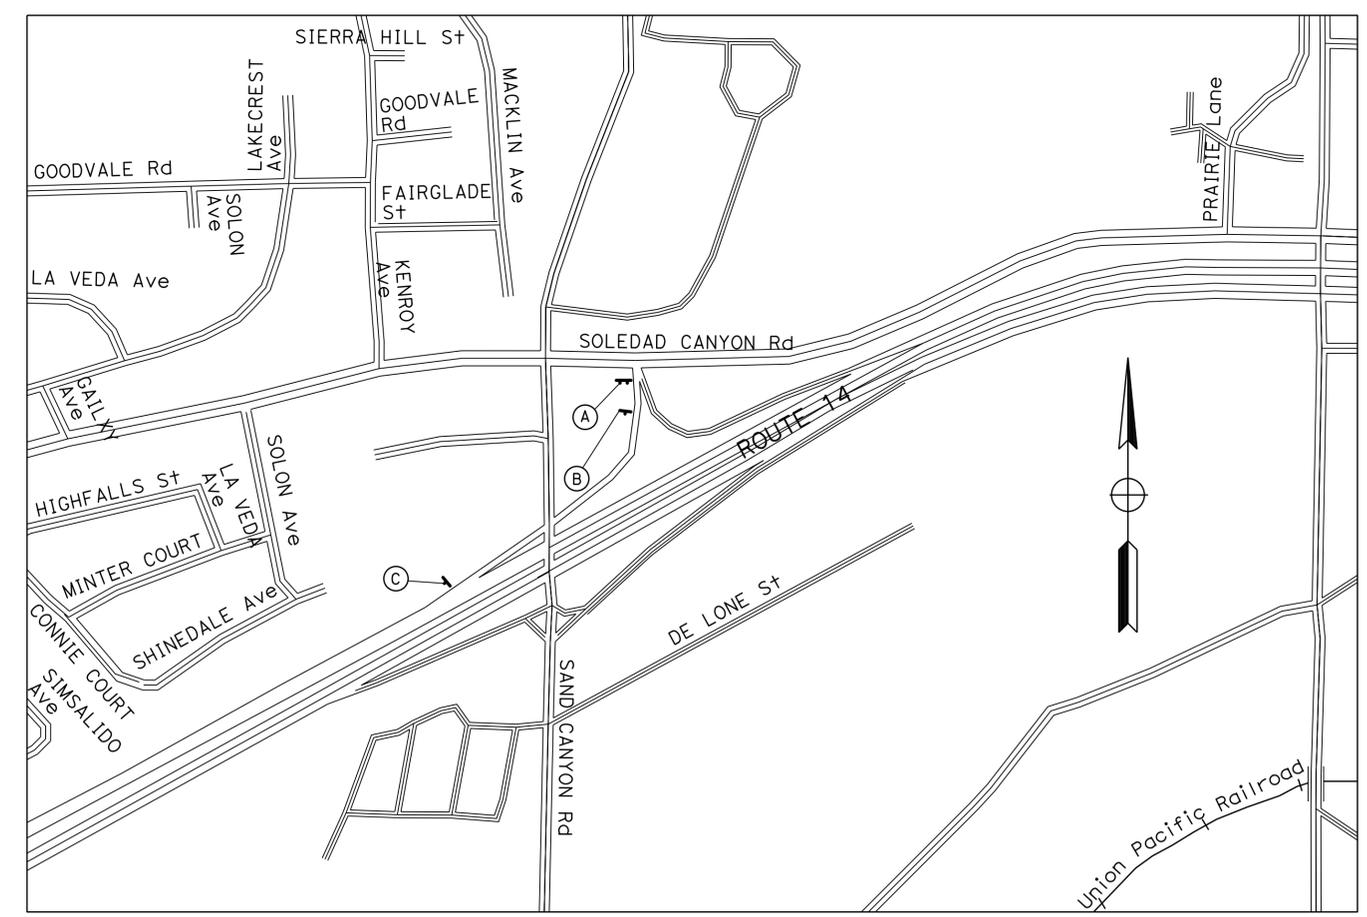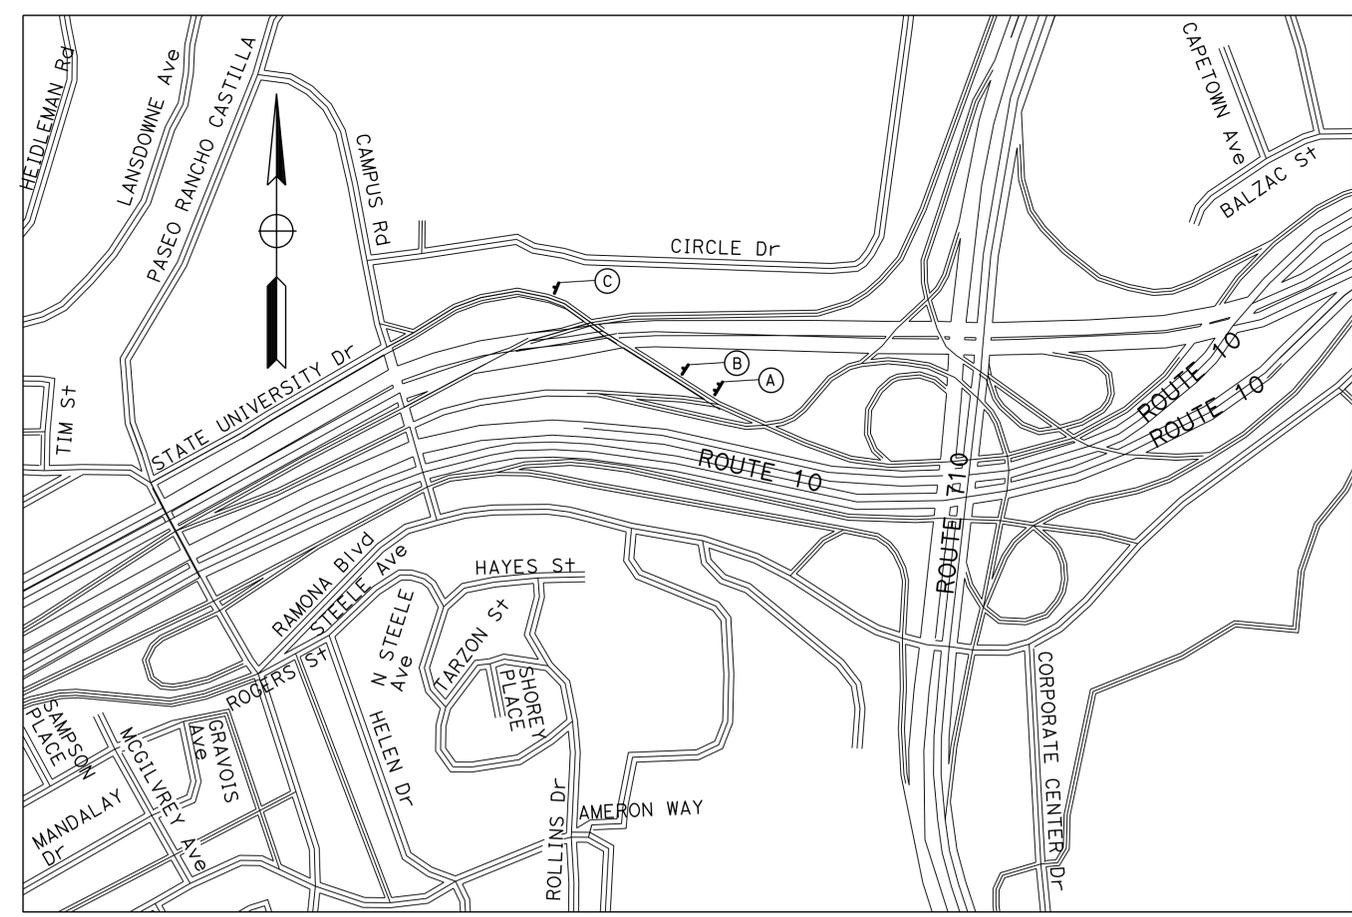

CONSTRUCTION AREA SIGNS

NO SCALE

CS-7

APPROVED FOR CONSTRUCTION AREA SIGNS WORK.

STATE OF CALIFORNIA - DEPARTMENT OF TRANSPORTATION
Caltrans OFFICE OF DESIGN D
 FUNCTIONAL SUPERVISOR: KAREN FONG
 CALCULATED/DESIGNED BY: NARENDRA DESAI
 CHECKED BY: REFUGIO DOMINGUEZ
 REVISED BY: NARENDRA DESAI
 DATE REVISED: REFUGIO DOMINGUEZ

Dist	COUNTY	ROUTE	POST MILES TOTAL PROJECT	SHEET No.	TOTAL SHEETS
07	LA	5,10,14, 47,60,etc.	Var	40	72

8-30-12
 REGISTERED CIVIL ENGINEER DATE
 REFUGIO DOMINGUEZ
 No. 50820
 Exp. 9/30/13
 CIVIL
 STATE OF CALIFORNIA
 REGISTERED PROFESSIONAL ENGINEER

10-22-12
 PLANS APPROVAL DATE

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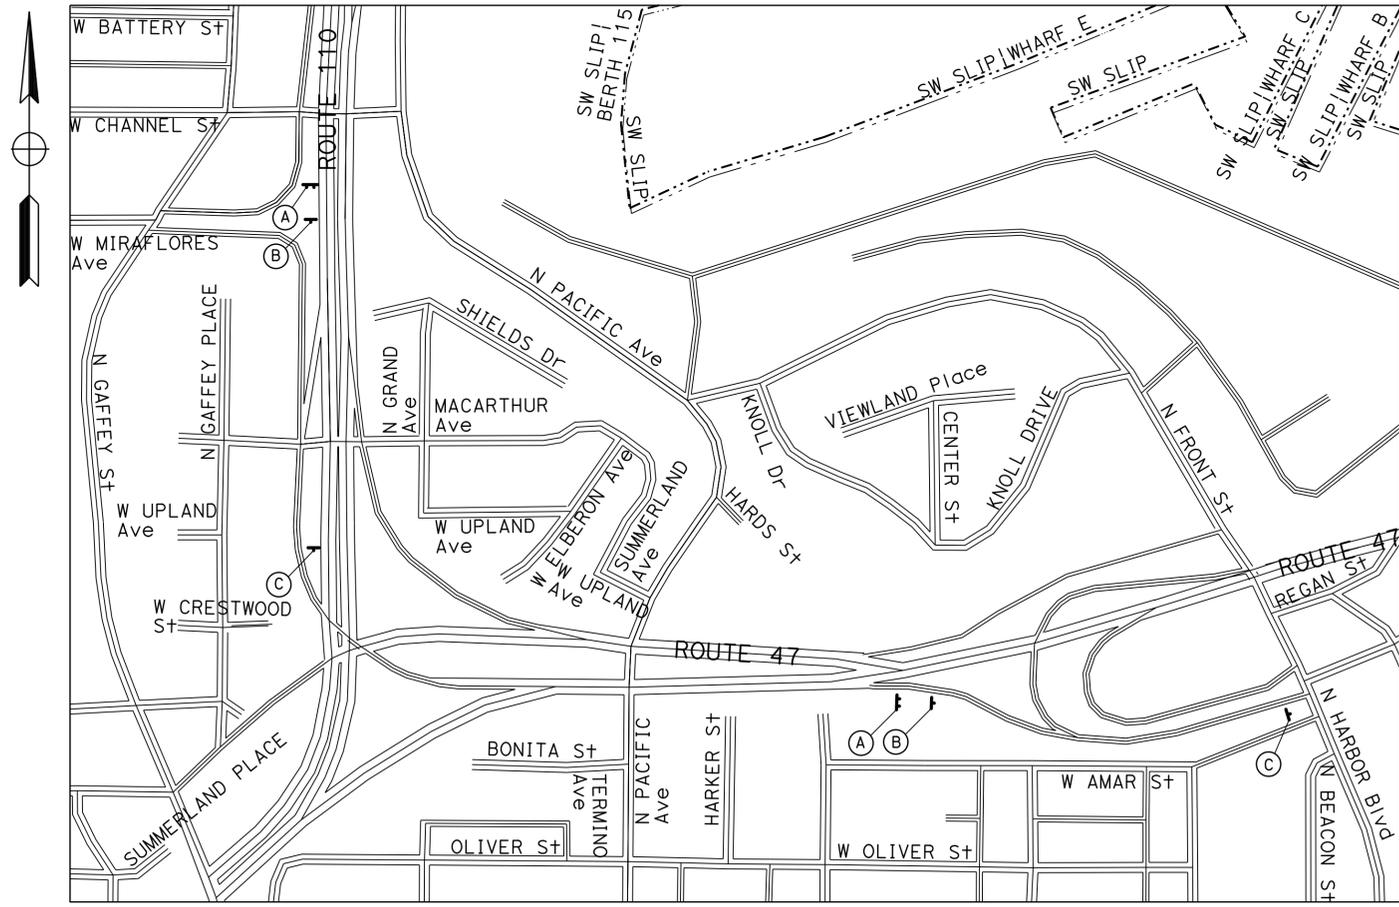
NOTES:

- SIGN LOCATIONS SHOWN ARE APPROXIMATE. EXACT LOCATIONS WILL BE DETERMINED BY THE ENGINEER.
- FOR ADDITIONAL CONSTRUCTION AREA SIGNS INFORMATION, SEE TRAFFIC HANDLING DETAILS.


STATIONARY MOUNTED CONSTRUCTION AREA SIGNS

SIGN No. (X)	SIGN CODE	PANEL SIZE	SIGN MESSAGE	POST No. & SIZE	No. OF SIGNS
A	C40(CA)	144" X 60"	TRAFFIC FINES DOUBLED IN CONSTRUCTION ZONES	2 - 6" X 6"	4
B	W20-1	48" X 48"	ROAD WORK AHEAD	1 - 4" X 6"	4
C	G20-2	48" X 24"	END ROAD WORK	1 - 4" X 6"	4
TOTAL					12

LOCATION 5 & 10



LOCATION 13 & 14

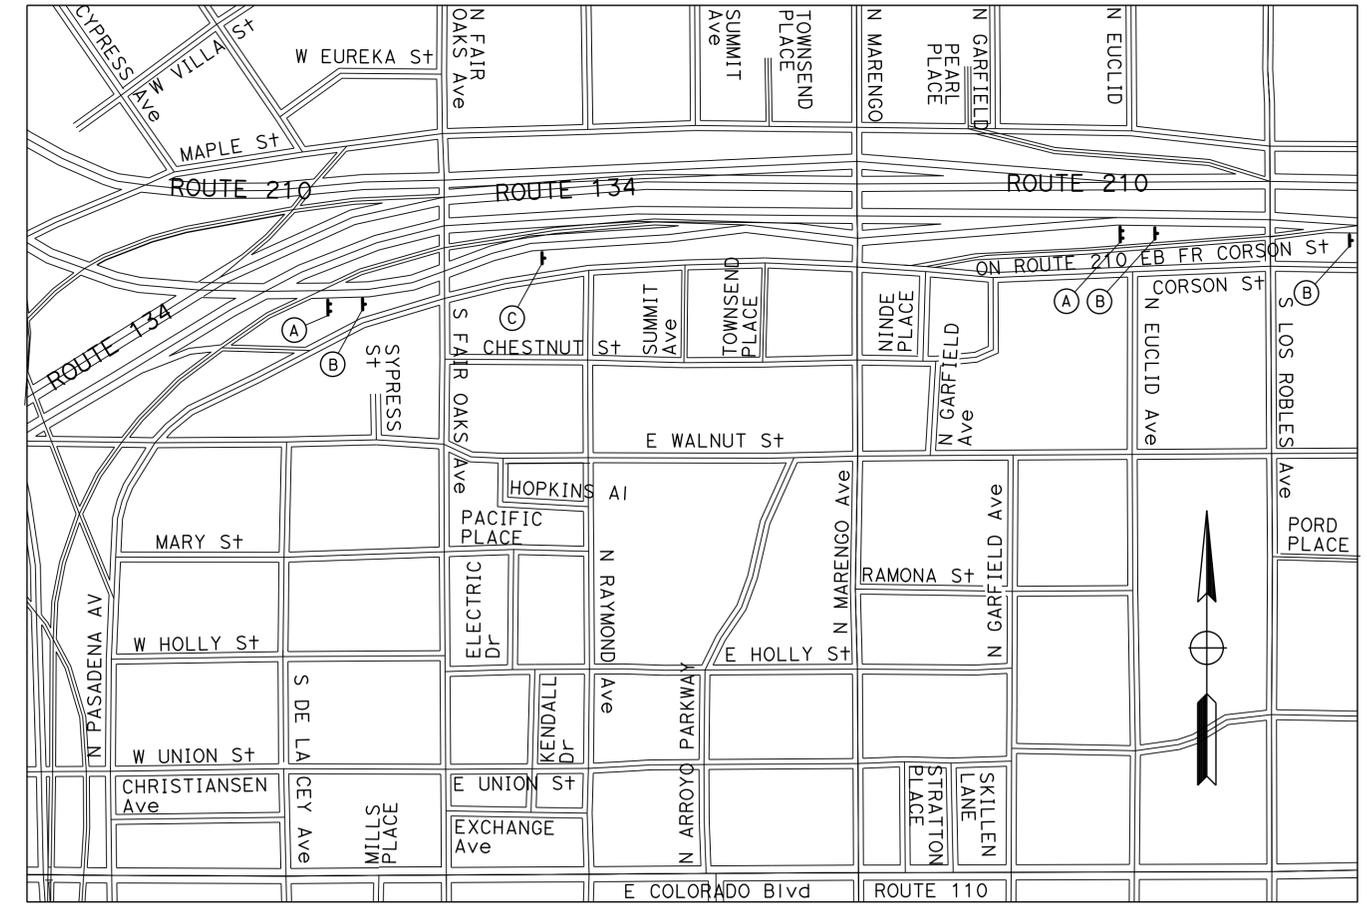

CONSTRUCTION AREA SIGNS

NO SCALE

CS-8

APPROVED FOR CONSTRUCTION AREA SIGNS WORK ONLY.

STATE OF CALIFORNIA - DEPARTMENT OF TRANSPORTATION - OFFICE OF DESIGN D
 FUNCTIONAL SUPERVISOR: KAREN FONG
 CALCULATED/DESIGNED BY: NARENDRA DESAI
 CHECKED BY: REFUGIO DOMINGUEZ
 REVISED BY: NARENDRA DESAI
 DATE REVISED: REFUGIO DOMINGUEZ

STATE OF CALIFORNIA - DEPARTMENT OF TRANSPORTATION
Caltrans OFFICE OF DESIGN D
 FUNCTIONAL SUPERVISOR: KAREN FONG
 CALCULATED/DESIGNED BY: NARENDRA DESAI
 CHECKED BY: REFUGIO DOMINGUEZ
 REVISED BY: NARENDRA DESAI
 DATE REVISED: REFUGIO DOMINGUEZ

NOTES:

- SIGN LOCATIONS SHOWN ARE APPROXIMATE. EXACT LOCATIONS WILL BE DETERMINED BY THE ENGINEER.
- FOR ADDITIONAL CONSTRUCTION AREA SIGNS INFORMATION, SEE TRAFFIC HANDLING DETAILS.

Dist	COUNTY	ROUTE	POST MILES TOTAL PROJECT	SHEET No.	TOTAL SHEETS
07	LA	5,10,14, 47,60,etc.	Var	41	72

REFUGIO DOMINGUEZ 8-30-12
 REGISTERED CIVIL ENGINEER DATE
 10-22-12
 PLANS APPROVAL DATE
 No. 50820
 Exp. 9-30-13
 CIVIL
 STATE OF CALIFORNIA
 REGISTERED PROFESSIONAL ENGINEER


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STATIONARY MOUNTED CONSTRUCTION AREA SIGNS

SIGN No. (X)	SIGN CODE	PANEL SIZE	SIGN MESSAGE	POST No. & SIZE	No. OF SIGNS
C	G20-2	48" X 24"			
D	C40(CA)	108" X 42"	TRAFFIC FINES DOUBLED IN CONSTRUCTION ZONES	1 - 4" X 6"	2
E	W20-1	36" X 36"	ROAD WORK AHEAD	1 - 4" X 6"	2
F	G20-2	36" X 18"	END ROAD WORK	1 - 4" X 6"	2
TOTAL					6



LOCATION 12

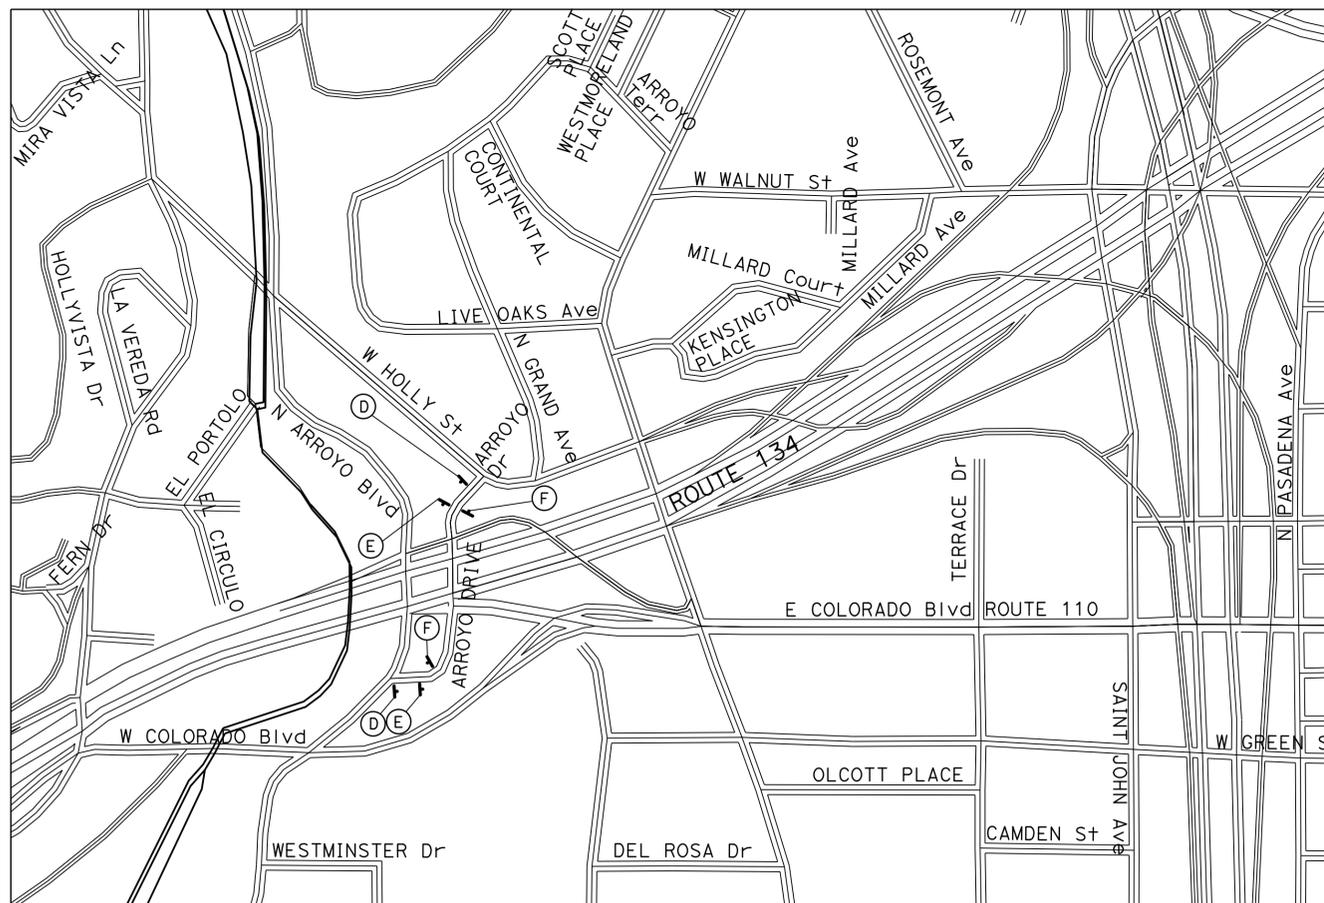

CONSTRUCTION AREA SIGNS

NO SCALE

CS-9

APPROVED FOR CONSTRUCTION AREA SIGNS WORK ONLY.

Dist	COUNTY	ROUTE	POST MILES TOTAL PROJECT	SHEET No.	TOTAL SHEETS
07	LA	5,10,14 47,60, etc.	Var	42	72

REGISTERED CIVIL ENGINEER DATE 5-24-11

10-22-12 PLANS APPROVAL DATE

THE STATE OF CALIFORNIA OR ITS OFFICERS OR AGENTS SHALL NOT BE RESPONSIBLE FOR THE ACCURACY OR COMPLETENESS OF SCANNED COPIES OF THIS PLAN SHEET.

REGISTERED PROFESSIONAL ENGINEER
CHEN CHUNG LIU
No. C67562
Exp. 6-30-13
CIVIL
STATE OF CALIFORNIA


STATE OF CALIFORNIA - DEPARTMENT OF TRANSPORTATION
DTM
Caltrans®

FUNCTIONAL SUPERVISOR MARTIN OREGEL


CALCULATED-DESIGNED BY CHECKED BY

ALBERT K YU JOCELYN C CHIANG

REVISED BY DATE REVISED
JC 7/10

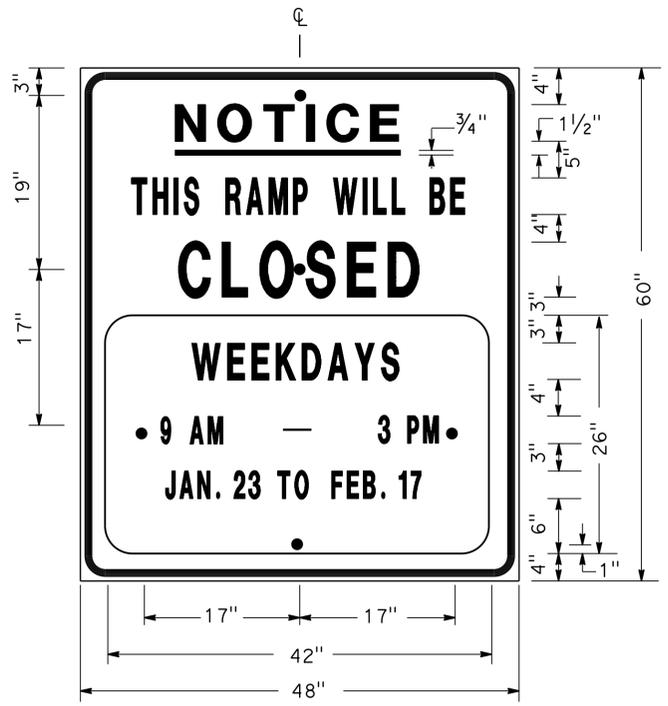

SIGN SP-1

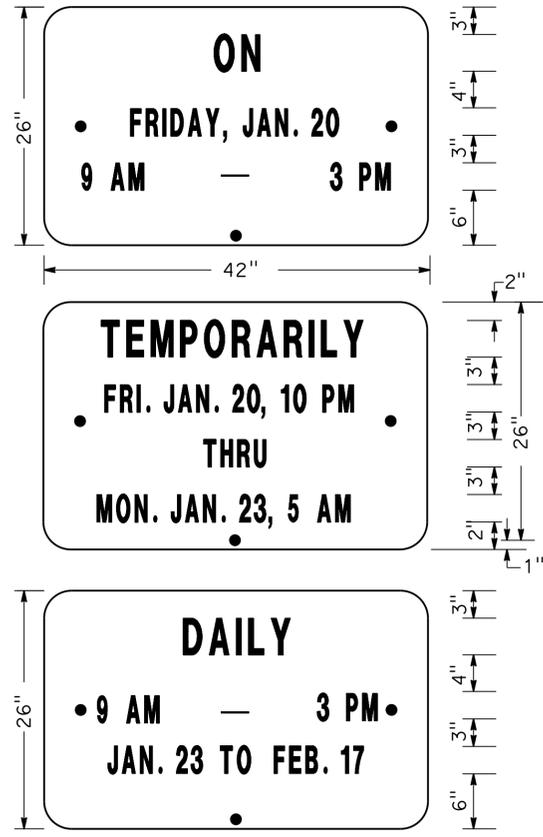


ALTERNATE OVERLAY PANELS (TYPICAL)

- NOTES: (SIGN SP-1)
- SIGNS SHALL HAVE ORANGE RETROREFLECTORIZED BACKGROUND WITH BLACK BORDER AND LETTERS.
 - BOLT HOLES SHALL BE 3/8" DIAMETER.
 - BASE MATERIAL SHALL BE ALUMINUM (MINIMUM 0.06").
 - SIGNS SHALL BE MOUNTED WITH BOTTOMS OF SIGNS A MINIMUM OF 6' ABOVE GROUND.

SIZE	BORDER		LETTER SIZE					CORNER RADIUS
	WIDTH	MARGIN WIDTH	LINE 1	LINE 2*	LINE 3	LINE 4	LINE 5,6 & 7*	
48"x60"	1 1/4"	3/4"	4E	4D	6E	4D		3"
42"x26"	OVERLAY						3D	1 1/2"

* CONDENSED SPACING IF NECESSARY

SPECIAL ADVANCE NOTICE PUBLICITY SIGN

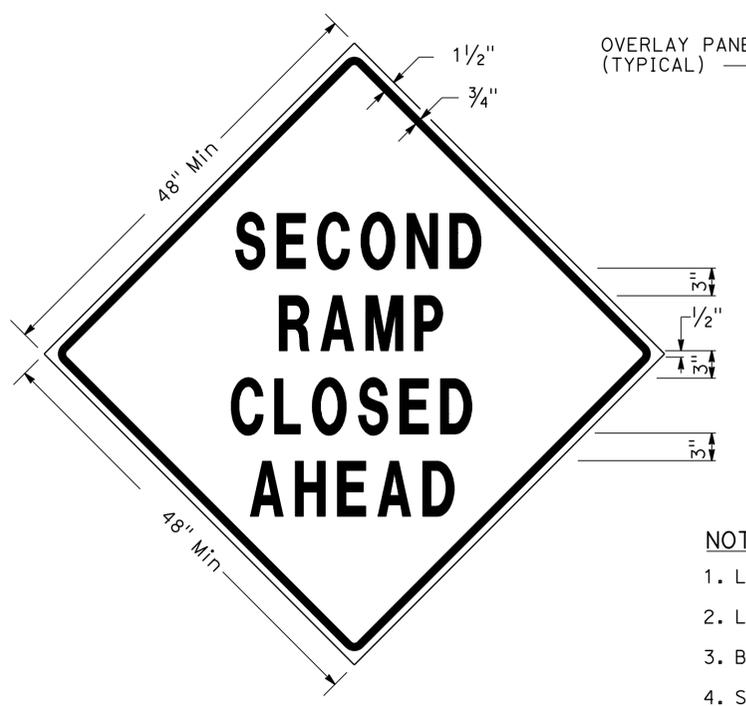

SIGN SP-3

SPECIAL SIGN FOR EXIT RAMP CLOSURES

- NOTES: (SIGNS SP-3 & SP-5)
- LETTERS - 6" SERIES D.
 - LETTERS AND BORDERS - BLACK ON RETROREFLECTORIZED ORANGE BACKGROUND.
 - BASE MATERIAL SHALL BE ALUMINUM (MINIMUM 0.06").
 - SIGNS SHALL BE MOUNTED WITH BOTTOMS OF SIGNS A MINIMUM OF 6' ABOVE GROUND.



SIGN SP-5



SIGN SP-4

- NOTES: (SIGN SP-4)
- LETTERS - 6" SERIES C.
 - LETTERS AND BORDERS - BLACK ON RETROREFLECTORIZED WHITE BACKGROUND.
 - BASE MATERIAL SHALL BE ALUMINUM (MINIMUM 0.06").
 - SIGNS SHALL BE PLACED AT RAMP ENTRANCES IN ADDITION TO SIGNS POSTED IN ACCORDANCE WITH STANDARD PLAN T14.

SPECIAL SIGN FOR ENTRANCE RAMP CLOSURES

**TRAFFIC HANDLING DETAILS
TRAFFIC CONTROL SYSTEM
FOR RAMP CLOSURES, DETOUR SIGNS
AND MISCELLANEOUS DETAILS**

SHEET 1 OF 2

NO SCALE


THD-1

Dist	COUNTY	ROUTE	POST MILES TOTAL PROJECT	SHEET No.	TOTAL SHEETS
07	LA	5,10,14 47,60, etc.	Var	43	72

5-24-11
 REGISTERED CIVIL ENGINEER DATE
 10-22-12
 PLANS APPROVAL DATE

CHEN CHUNG LIU
 No. C67562
 Exp. 6-30-13
 CIVIL
 STATE OF CALIFORNIA

THE STATE OF CALIFORNIA OR ITS OFFICERS OR AGENTS SHALL NOT BE RESPONSIBLE FOR THE ACCURACY OR COMPLETENESS OF SCANNED COPIES OF THIS PLAN SHEET.

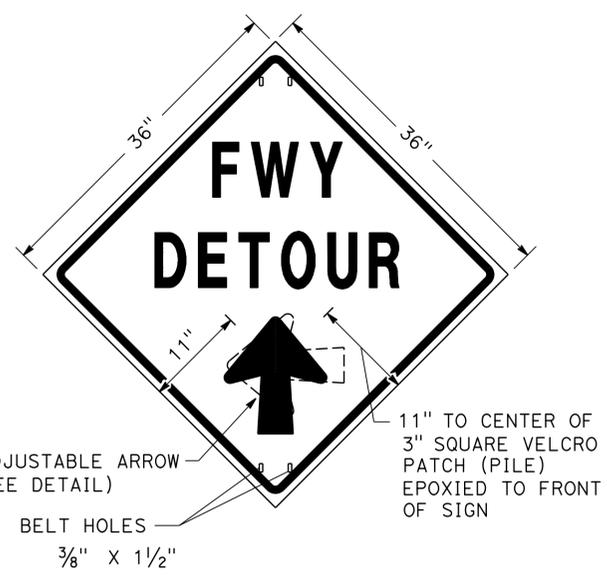


SIGN SP-2

NOTES: (SIGN SP-2)


- LETTERS -6" SERIES E.
- LETTERS, BORDER AND ARROW - BLACK ON RETROREFLECTORIZED ORANGE BACKGROUND.
- BASE MATERIAL FOR SIGNS AND ARROWS SHALL BE ALUMINUM (MINIMUM 0.06").
- BELTS (LUGGAGE STRAPS) SHALL BE 1" WIDE BY 48" LONG, MADE OF COTTON OR POLYPROPYLENE WEB MATERIAL.
- SIGNS SHALL BE MOUNTED WITH BOTTOMS OF SIGNS A MINIMUM OF 6' ABOVE GROUND EXCEPT AS OTHERWISE SHOWN ON OTHER TRAFFIC HANDLING DETAILS PLANS.

ABBREVIATION:

(CA) CALIFORNIA CODE

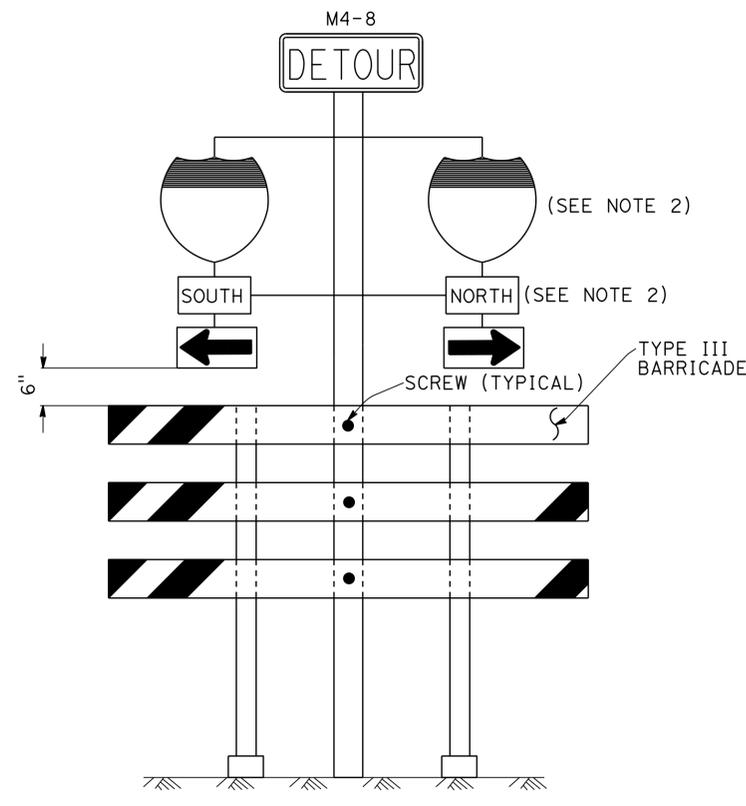

SIGN SP-6 (SEE NOTE 1)

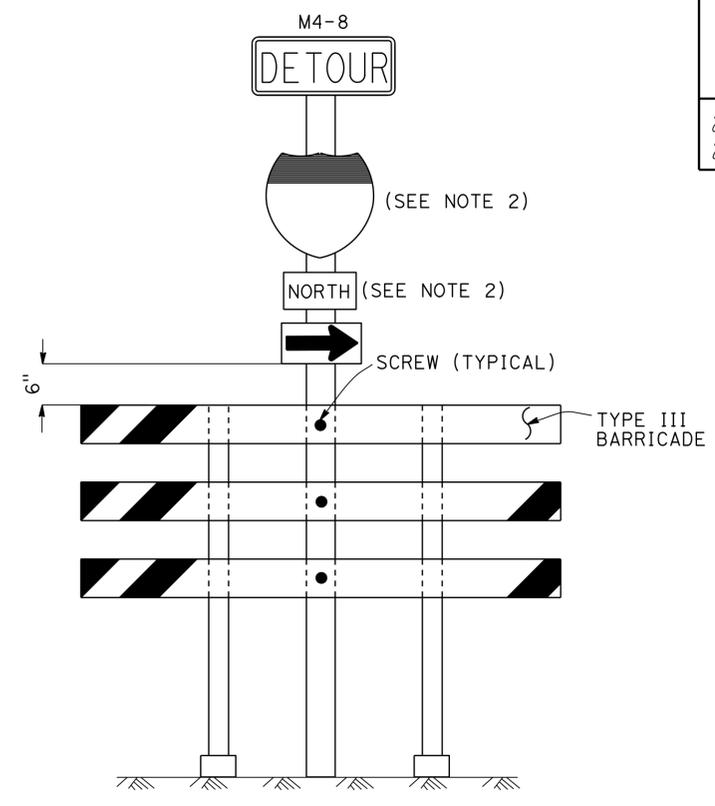


SIGN SP-7 (SEE NOTE 1)

NOTES: (SIGNS SP-6 & SP-7)

- IN LIEU OF PLACING SIGNS ON TYPE III BARRICADES, SIGNS, INCLUDING POSTS, MAY BE PLACED INTO THE GROUND OR FASTENED ONTO ELECTROLIERS.
- USE APPROPRIATE ROUTE SHIELD [G26-2(CA), G27-2(CA), G28-2(CA)] AND CARDINAL DIRECTION [NORTH (M3-1), SOUTH (M3-3), EAST (M3-2), WEST (M3-4)]

SPECIAL PORTABLE FREEWAY DETOUR SIGNS

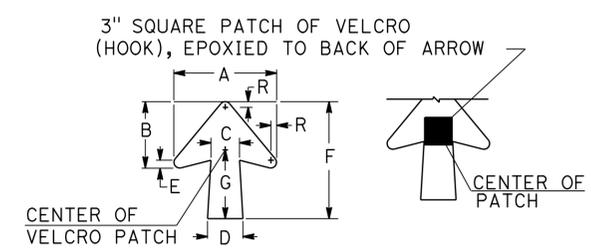

ADJUSTABLE ARROW DETAIL

DIMENSIONS							
A	B	C	D	E	F	G	R
11 1/4"	7 1/4"	3 3/8"	4"	7 7/8"	13"	7 1/2"	5 7/8"

SPECIAL PORTABLE FREEWAY DETOUR SIGN

**TRAFFIC HANDLING DETAILS
TRAFFIC CONTROL SYSTEM
FOR RAMP CLOSURES, DETOUR SIGNS
AND MISCELLANEOUS DETAILS**

SHEET 2 OF 2

NO SCALE


THD-2

STATE OF CALIFORNIA - DEPARTMENT OF TRANSPORTATION
 DTIC
 FUNCTIONAL SUPERVISOR MARTIN OREGEL
 CHECKED BY
 CALCULATED/DESIGNED BY
 REVISOR BY ALBERT K YU DATE REVISED 7/10
 JOCELYN C CHIANG

LAST REVISION DATE PLOTTED => 02-JAN-2013
10-09-12 TIME PLOTTED => 19:23

Dist	COUNTY	ROUTE	POST MILES TOTAL PROJECT	SHEET No.	TOTAL SHEETS
07	LA	5,10,14 47,60, etc.	Var	44	65
			5-24-11		
REGISTERED CIVIL ENGINEER			DATE		
10-22-12			PLANS APPROVAL DATE		
<small>THE STATE OF CALIFORNIA OR ITS OFFICERS OR AGENTS SHALL NOT BE RESPONSIBLE FOR THE ACCURACY OR COMPLETENESS OF SCANNED COPIES OF THIS PLAN SHEET.</small>					

STATE OF CALIFORNIA - DEPARTMENT OF TRANSPORTATION	FUNCTIONAL SUPERVISOR	CALCULATED-DESIGNED BY	REVISOR	DATE
Caltrans	MARTIN OREGEL	ALBERT K YU	JC	7/10
		JOCELYN C CHIANG		

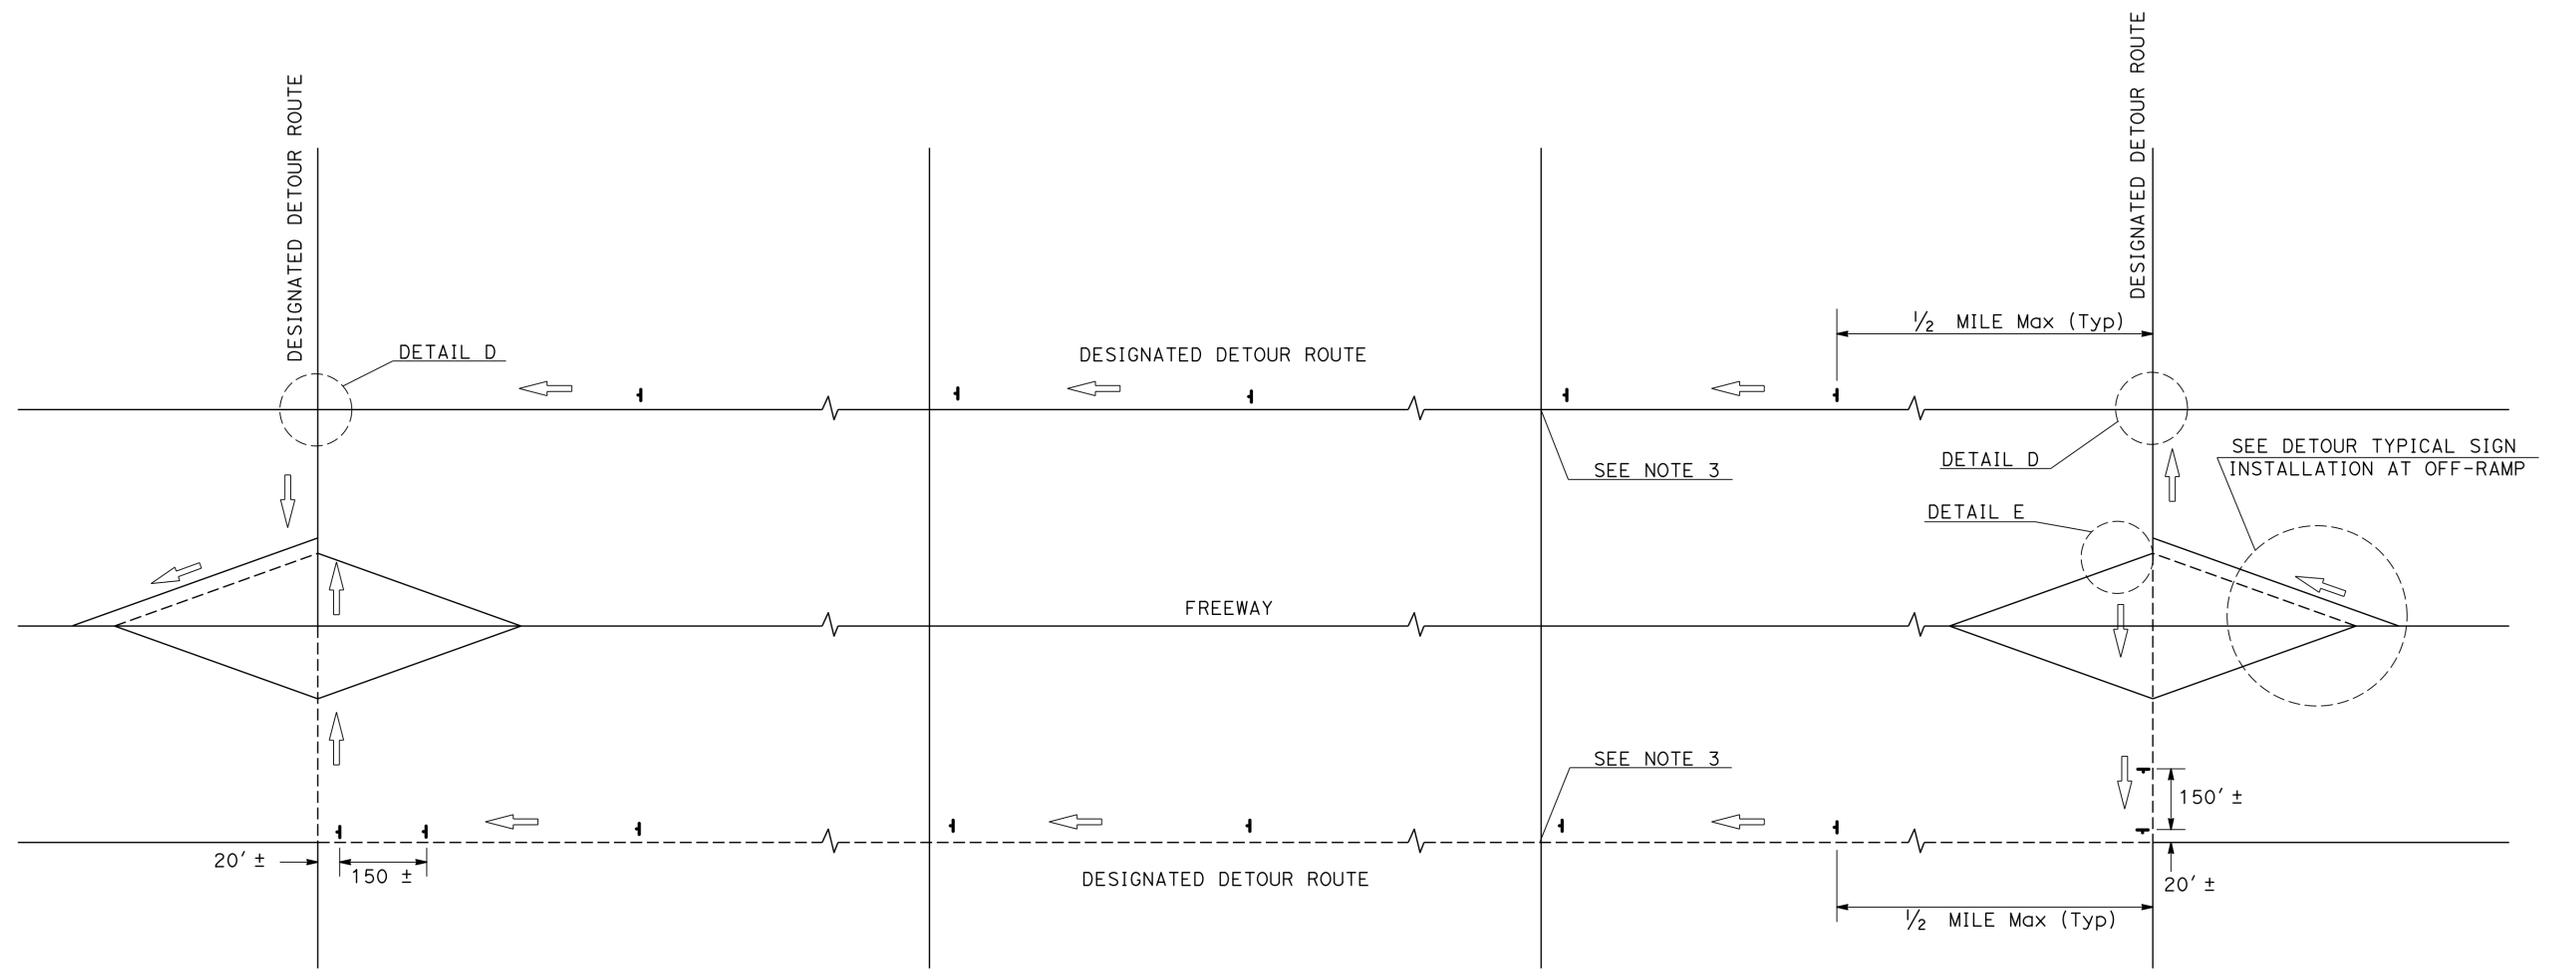

TYPICAL DETOUR SIGN INSTALLATION ALONG DESIGNATED DETOUR ROUTE

- LEGEND:**
- TEMPORARY SIGN (SP-2)
 - AND/OR DESIGNATED DETOUR ROUTE
 - DIRECTION OF TRAVEL

- NOTES:**
- SP-2 SIGNS SHALL NOT BE INSTALLED ON BARRICADES EXCEPT AS OTHERWISE SHOWN.
 - SIGN LOCATIONS ARE APPROXIMATE. EXACT LOCATIONS WILL BE DETERMINED BY THE ENGINEER.
 - SP-2 SIGNS SHALL BE POSTED AT SIGNALIZED INTERSECTIONS ALONG THE DESIGNATED DETOUR ROUTE OR 1/2 MILE MAXIMUM APART.

**TRAFFIC HANDLING DETAILS
TRAFFIC CONTROL SYSTEM
FOR DETOUR SIGN INSTALLATION
ALONG DESIGNATED DETOUR ROUTE
SHEET 1 OF 2
NO SCALE**

THD-3






LAST REVISION DATE PLOTTED => 02-JAN-2013 10-09-12 TIME PLOTTED => 19:23

Dist	COUNTY	ROUTE	POST MILES TOTAL PROJECT	SHEET No.	TOTAL SHEETS
07	LA	5,10,14 47,60, etc.	Var	45	72

5-24-11
 REGISTERED CIVIL ENGINEER DATE
 10-22-12
 PLANS APPROVAL DATE

CHEN CHUNG LIU
 No. C67562
 Exp. 6-30-13
 CIVIL
 STATE OF CALIFORNIA

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TYPICAL DETOUR SIGN INSTALLATION AT OFF-RAMP

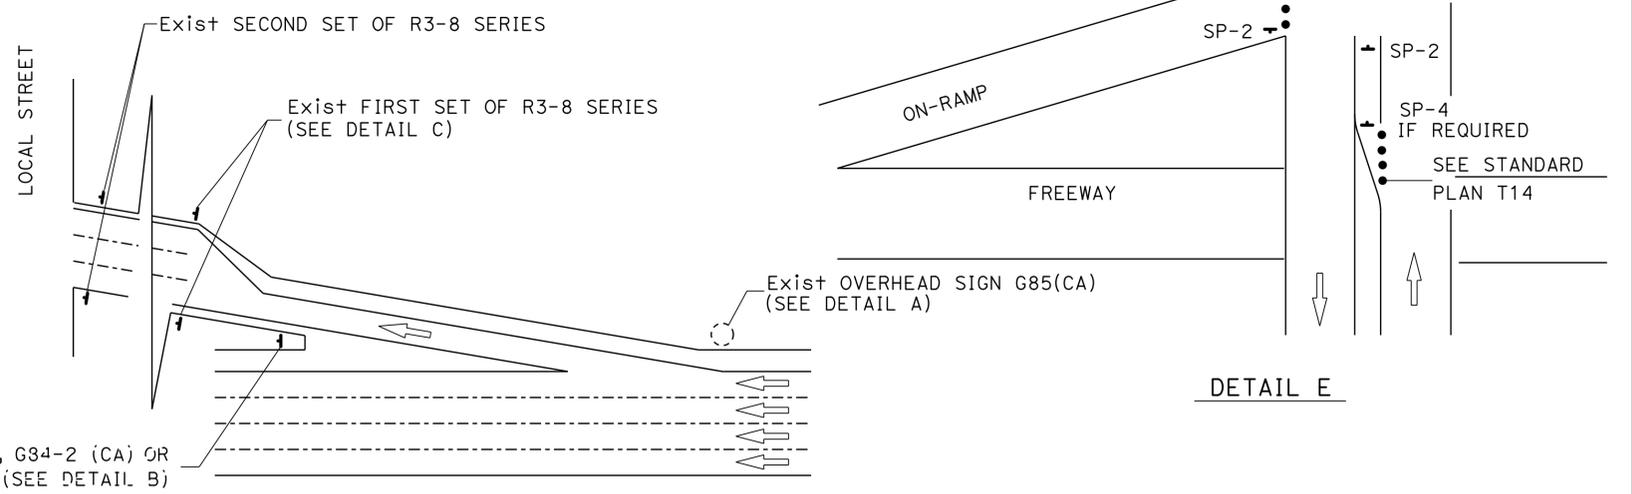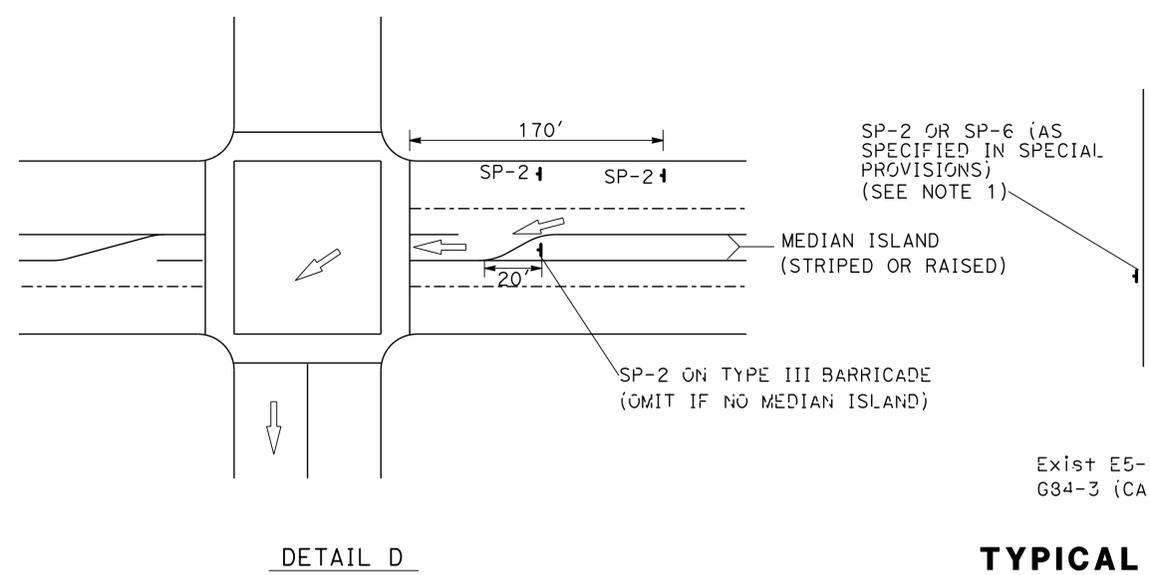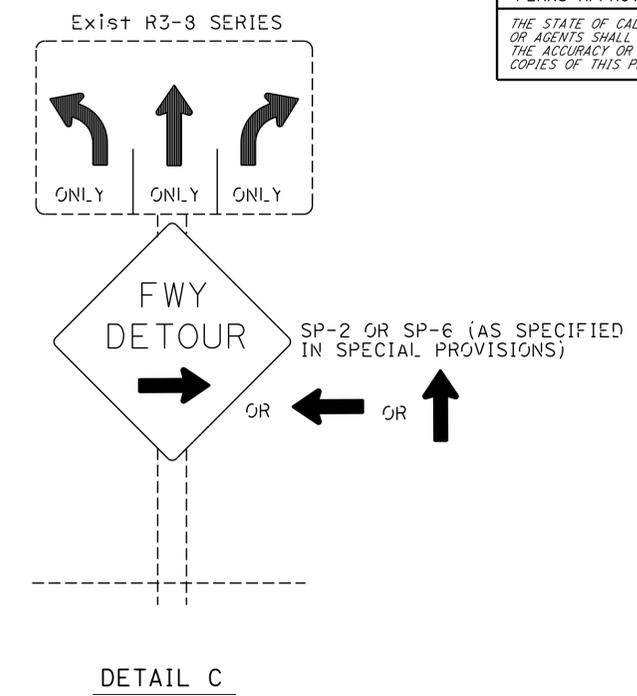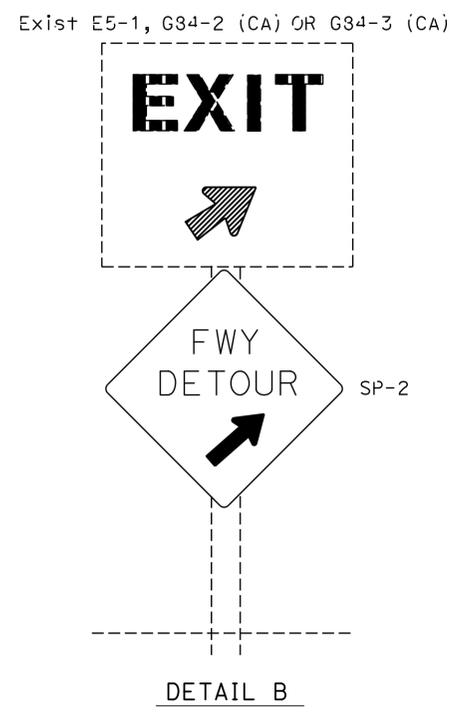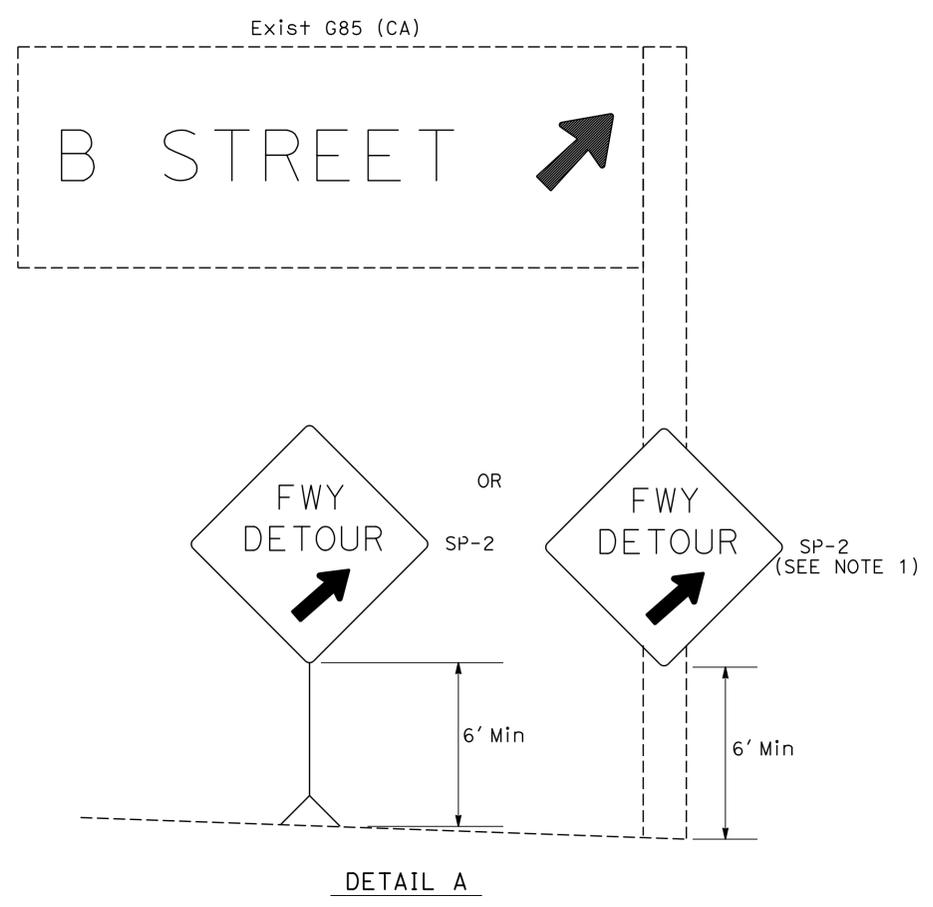NOTES:
 1. TEMPORARY SIGNS MAY BE STRAPPED ON EXISTING ELECTROLIER, SIGNAL POSTS, OR SIGN POSTS.

ABBREVIATIONS
 (CA) CALIFORNIA CODE

LEGENDS

- TRAFFIC CONE
- ⚡ TEMPORARY SIGN
- ➡ DIRECTION OF TRAVEL
- EXISTING OVERHEAD SIGN

**TRAFFIC HANDLING DETAILS
 TRAFFIC CONTROL SYSTEM
 FOR DETOUR SIGN INSTALLATION
 ALONG DESIGNATED DETOUR ROUTE
 SHEET 2 OF 2
 NO SCALE**

THD-4

STATE OF CALIFORNIA - DEPARTMENT OF TRANSPORTATION
Caltrans
 DT M
 FUNCTIONAL SUPERVISOR: MARTIN OREGEL
 CHECKED BY: JOCELYN C CHIANG
 REVISIONS: 7/10
 DESIGNED BY: ALBERT K YU
 DATE: 7/10

USERNAME => s125624
 DGN FILE => 725880me004.dgn

RELATIVE BORDER SCALE IS IN INCHES
 0 1 2 3

UNIT 1887

PROJECT NUMBER & PHASE

07000201951

LAST REVISION: 10-09-12 DATE PLOTTED: 02-JAN-2013 TIME PLOTTED: 19:24

WATER POLLUTION CONTROL QUANTITIES

ITEM DESCRIPTION	UNIT	QUANTITY
TEMPORARY SILT FENCE	LF	2000
TEMPORARY DRAINAGE INLET PROTECTION	EA	10
TEMPORARY FIBER ROLL	LF	1010

Dist	COUNTY	ROUTE	POST MILES TOTAL PROJECT	SHEET No.	TOTAL SHEETS
07	LA	5,10,14 47,60,etc.	Var	46	72

8-30-12
 REGISTERED CIVIL ENGINEER DATE

10-22-12
 PLANS APPROVAL DATE

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ROADWAY QUANTITIES

LOCATION	DESCRIPTION	CONCRETE BARRIER (TYPE 736B)	18" CORRUGATED STEEL PIPE CONDUIT (.079" THICK)	SHOTCRETE	STRUCTURE EXCAVATION (SOIL NAIL WALL)	SOIL NAIL	ROCK SLOPE PROTECTION FABRIC (CLASS 8)	MINOR CONCRETE (Misc CONSTRUCTION)	RECONSTRUCT CHAIN LINK FENCE	REMOVE CONCRETE (CHANNEL)	ROADWAY EXCAVATION	ROADWAY EXCAVATION (TYPE Z-2) (AERIALY DEPOSITED LEAD)	IMPORTED BORROW	CLASS 3 AGGREGATE BASE	CLASS D AGGREGATE BASE	HOT MIX ASPHALT (TYPE A)	PLACE HMA (Misc AREA)	ROCK SLOPE PROTECTION (NO. 3, METHOD B)	SLOPE PAVING (CONCRETE)	RELOCATE ROADSIDE SIGN-TWO POST	ROCK BLANKET	CEMENT TREATED PERMEABLE BASE	MULCH (N)	LEAN CONCRETE BASE	REMOVE PIPE	DITCH EXCAVATION	EROSION CONTROL (HYDROSEED)
		LF	LF	CY	CY	LF	SQYD	CY	LF	CY	CY	CY	CY	CY	CY	TON	SQYD	CY	CY	EA	SQYD	CY	CY	CY	LF	CY	SQFT
1	ON ROUTE 5 AT MAGIC MOUNTAIN PARKWAY OFF-RAMPS						11	31					20					18		1						15	
2	ON ROUTE 5 AT ROUTE 126 SEPARATION						10	3					1					11								11	
3	ON WB 10 AT EASTERN Ave OFF-RAMP		15	34				3					3												15		
4	ON SB ROUTE 14 AT SAND CANYON Rd ON-RAMP				64	10	3300																				
5	ON SB ROUTE 47 AT HARBOR Blvd OFF-RAMP	144																									
6	PARK & RIDE AREA BETWEEN NB ROUTE 57 AND WB ROUTE 60							20		20																	
7	ON ROUTE 60 AT GOLDEN SPRINGS DRIVE			70					320				10						72							30	
8	ON WB ROUTE 60 AT GAREY Ave OFF-RAMP							8		7								2								97	3
9	BETWEEN THE WB ROUTE 60 ON-RAMP AND CONNECTOR RAMP TO EB ROUTE 71 AT GAREY Ave										550				275							275					56000
10	ON SB ROUTE 110 AT MacARTHUR Ave OC																		19								
11	ON ROUTE 110 AT RTE 405 SEPARATION																		340		1800		10				
12	ON EB ROUTE 134 AT ARROYO SECO SEPARATION		75	12									8						12						75		
13	ON ROUTE 210 AT FAIR OAKS Ave OC							3					3						16								
14	ON EB ROUTE 210 AT LOS ROBLES Ave OC																		14								
15	ON SB ROUTE 405 AT LA CIENEGA BLVD UC										50	30		20		36	6						10				
16	ON ROUTE 605 AT ROSECRANS Ave UC							2	70				10						40								
17	ON ROUTE 605 AT FIRESTONE Blvd UC							8	600										300								
18	ON RTE 60/605 SEPARATION																		70								
	TOTAL	144	90	180	10	3300	21	78	990	27	600	30	55	20	275	36	6	31	883	1	1800	275	220	10	90	29	56000

(N) NOT A PAY ITEM

SUMMARY OF QUANTITIES Q-1

LAST REVISION | DATE PLOTTED => 02-JAN-2013
 10-09-12 TIME PLOTTED => 19:24

Dist	COUNTY	ROUTE	POST MILES TOTAL PROJECT	SHEET No.	TOTAL SHEETS
07	LA	5,10,14, 47,60,etc.	Var	47	72

 8-30-12
 LICENSED LANDSCAPE ARCHITECT

10-22-12
 PLANS APPROVAL DATE


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PLANT LIST AND PLANTING SPECIFICATIONS

PLANT GROUP	PLANT No.	SYMBOL	BOTANICAL NAME	COMMON NAME	SIZE	QUANTITY EACH	HOLE SIZE (INCH)		BASIN TYPE	IRON SULFATE	SOIL AMEND ①	COMMERCIAL FERTILIZER ①		BASIN MULCH	STAKING	PLANTING LIMITS							REMARKS
							Di	DEPTH				PLANTING	PLT ESTB			MINIMUM DISTANCE (F+) FROM					ON CENTER (F+)		
																TRVD WAY	PVMT	FENCE	WALL	PAVED DITCH		EARTH DITCH	
A	1		<u>BACCHARIS PILULARIS</u>	COYOTE BRUSH	NO. 1	32	②	②	I	—	1 CF	4 oz	4 oz	1.4 CF	—	—	20	20	20	20	22	15	SHRUB
	2		<u>MUHLENBERGIA RIGENS</u>	DEER GRASS	NO. 1	265	②	②	I	—	1 CF	4 oz	4 oz	1.4 CF	—	2	—	—	—	2	2	3	GRASS
B	3		<u>FREMONTODENDRON CALIFORNICUM</u>	FLANNEL BUSH	NO. 5	23	②	②	I	—	1 CF	4 oz	4 oz	1.4 CF	—	—	15	10	10	10	12	10	SHRUB
	4		<u>RHAPHIOLEPIS INDICA</u> 'SPRINGTIME'	INDIAN HAWTHORN 'SPRINGTIME'	NO. 5	22	②	②	I	—	1 CF	4 oz	4 oz	1.4 CF	—	—	8	8	8	6	10	6	SHRUB
	5		<u>RHAMNUS CALIFORNICA</u> 'R.BONITA LINDA'	CALIFORNIA COFFEEBERRY	NO. 5	28	②	②	I	—	1 CF	4 oz	4 oz	1.4 CF	—	—	15	15	10	10	12	15	SHRUB
U	6		<u>CERCIS OCCIDENTALIS</u>	WESTERN REDBUD	NO. 15	10	②	②	I	—	2 CF	8 oz	8 oz	2.1 CF	—	40	—	20	20	10	12	—	TREE
	7		<u>SAMBUCUS MEXICANA</u>	BLUE ELDERBERRY	NO. 15	6	②	②	I	—	2 CF	8 oz	8 oz	2.1 CF	—	40	—	20	20	10	12	—	TREE

- APPLICABLE WHEN CIRCLED:**
- ① - Quantities shown are "per plant" unless shown as SQFT or SQYD application rates.
 - ② - Sufficient to receive root ball.
 - 3 - Does not apply to mulch areas.
 - 4 - As shown on plans.
 - 5 - Unless otherwise shown on plans.
 - 6 - See detail.
 - 7 - See Special Provisions.



NOTE:
Underlined portions of botanical name indicate abbreviations used on Planting Plans.

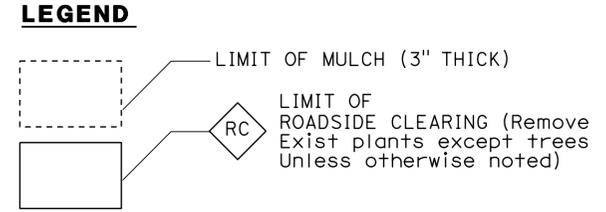STATE OF CALIFORNIA - DEPARTMENT OF TRANSPORTATION
 Ron Russak
 SENIOR LANDSCAPE ARCHITECT
 BONGKOD LOHMONGKOL
 RON RUSSAK
 CALCULATED/DESIGNED BY
 CHECKED BY
 REVISED BY
 DATE REVISED

PLANT LIST PL-1

LAST REVISION DATE PLOTTED => 02-JAN-2013 TIME PLOTTED => 19:24



Dist	COUNTY	ROUTE	POST MILES TOTAL PROJECT	SHEET No.	TOTAL SHEETS
07	LA	5,10,14, 47,60,etc.	Var	48	72

Ron Russak 8-30-12
 LICENSED LANDSCAPE ARCHITECT
 Signature
 10-22-12
 PLANS APPROVAL DATE
 Renewal Date
 8-31-13
 7-01-11
 Date
 STATE OF CALIFORNIA

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NOTES:

- EXISTING UTILITIES HAVE NOT BEEN PLOTTED ON THESE PLANS
- FOR ACCURATE RIGHT OF WAY DATE, CONTACT RIGHT OF WAY ENGINEERING AT THE DISTRICT OFFICE

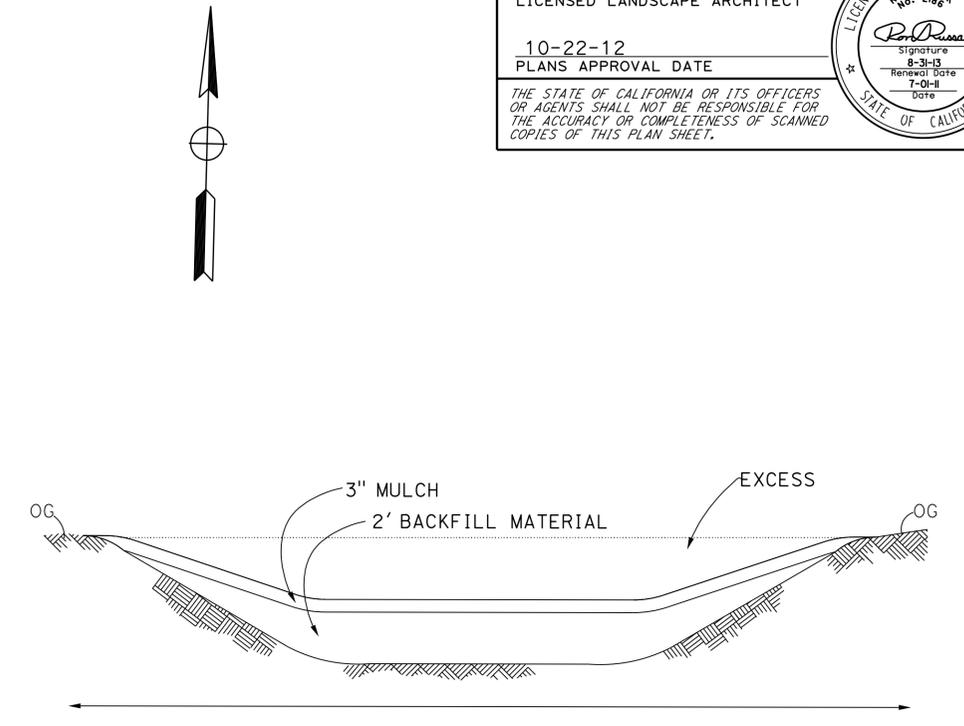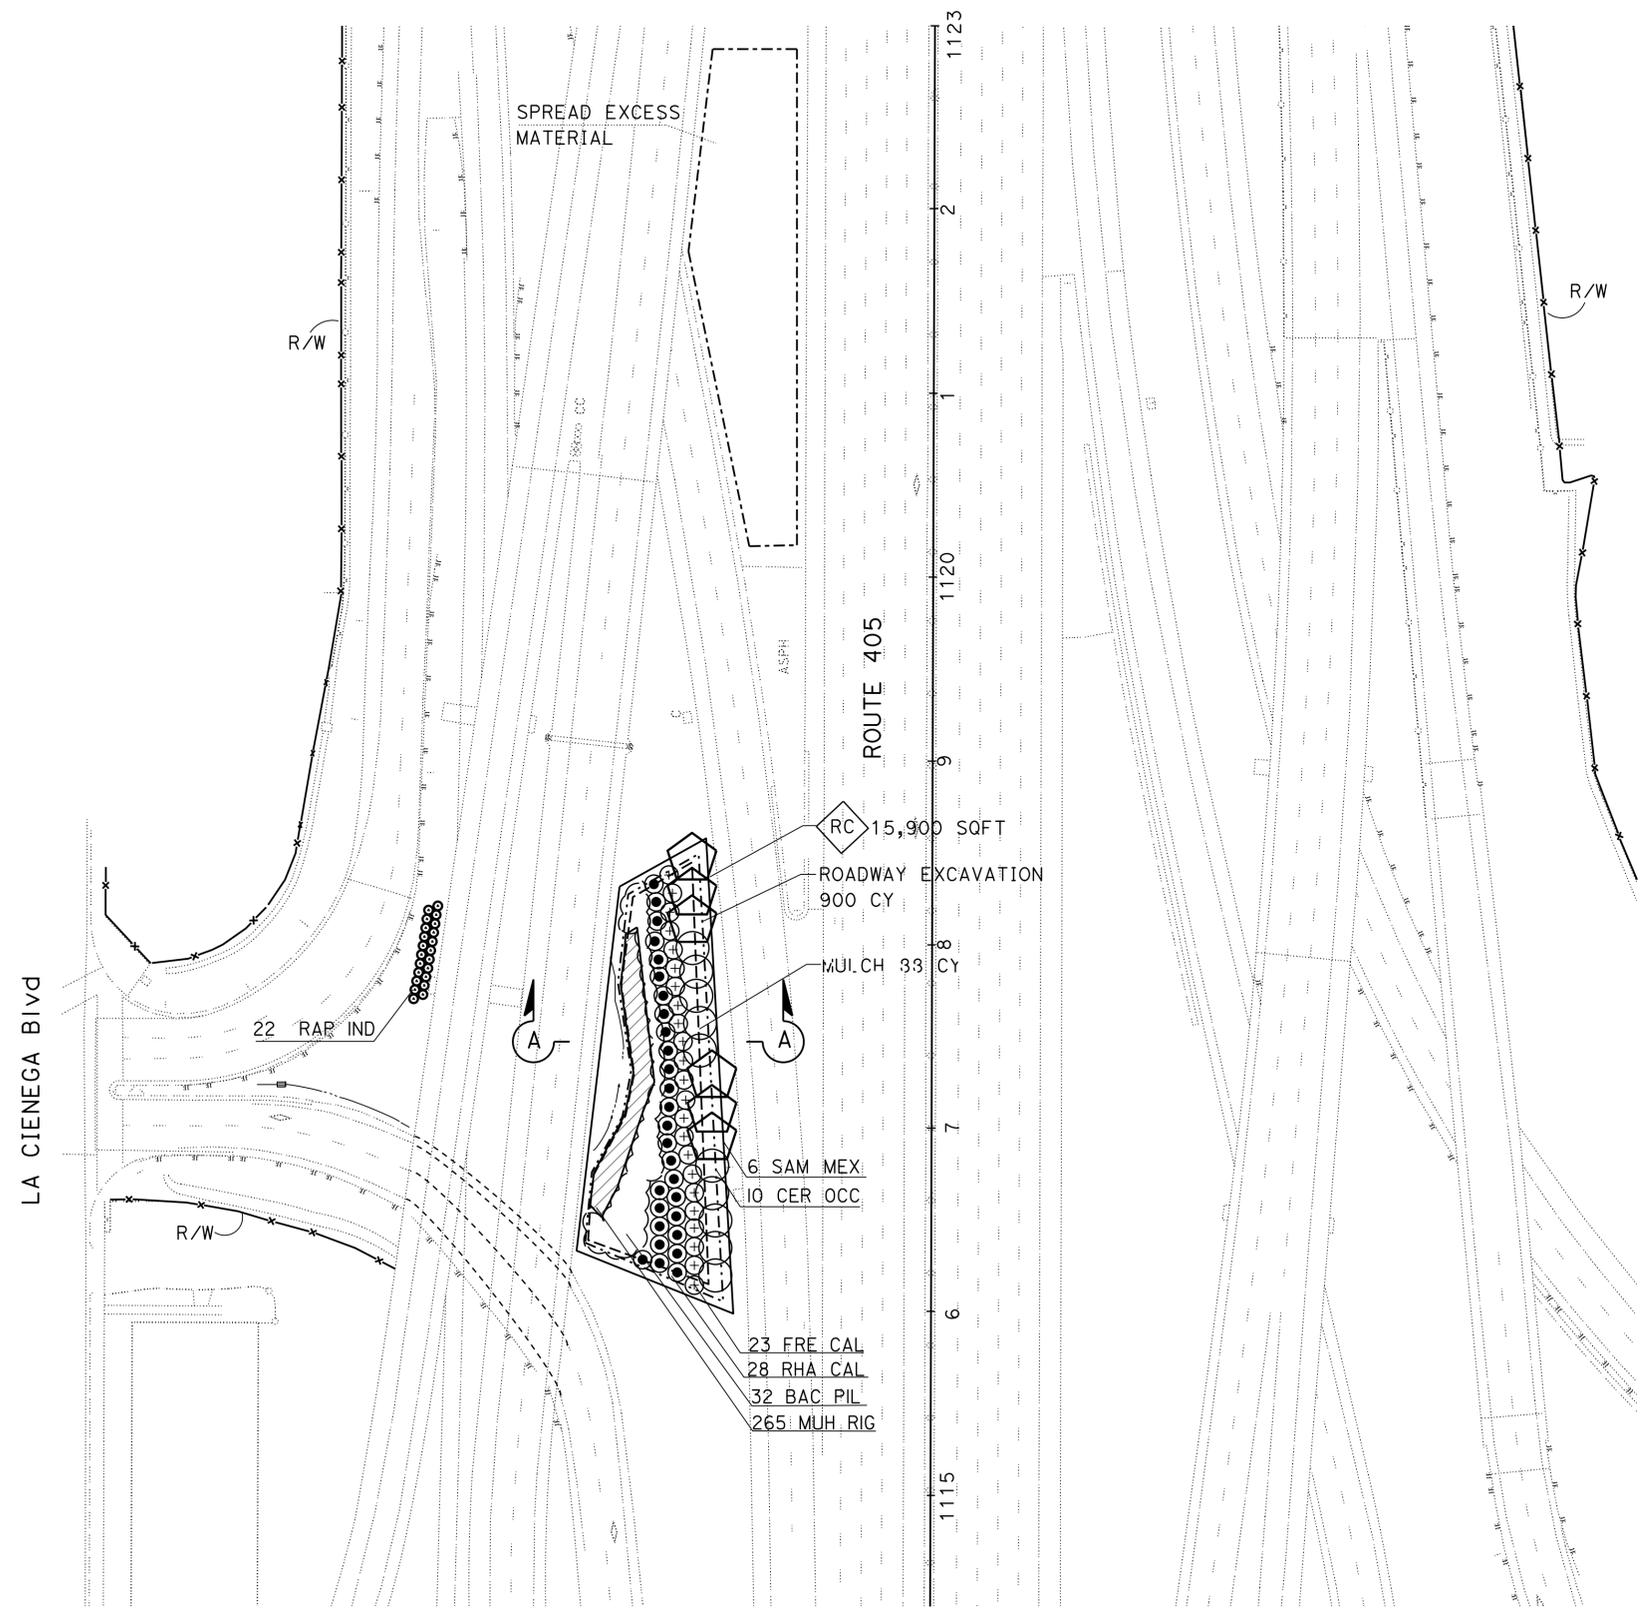

BACKFILL MATERIAL QUANTITIES

NATURAL SANDS	450 CY
COMPOST, INCORPORATE	1,200 SQYD
LOCAL TOPSOIL	180 CY

HAUL AWAY LOCAL EXCAVATED SOIL = 720 CY

PLANTING PLAN

SCALE: 1" = 50'

PP-1

STATE OF CALIFORNIA - DEPARTMENT OF TRANSPORTATION	SENIOR LANDSCAPE ARCHITECT	DESIGNED BY	REVISOR
Caltrans LANDSCAPE ARCHITECTURE	RON RUSSAK	RON RUSSAK	RON RUSSAK
	CHECKED BY	DATE	REVISION

USERNAME => s125624
DGN FILE => 725880+1001.dgn



UNIT 1849

PROJECT NUMBER & PHASE

07000201951

LAST REVISION DATE PLOTTED => 02-JAN-2013
10-05-12 TIME PLOTTED => 19:24

APPROVED FOR PLANTING WORK ONLY

Dist	COUNTY	ROUTE	POST MILES TOTAL PROJECT	SHEET No.	TOTAL SHEETS
07	LA	5,10,14, 47,60,etc.	Var	49	72

Ron Russak 8-30-12
 LICENSED LANDSCAPE ARCHITECT
 Signature
 8-31-13
 Renewal Date
 7-01-14
 Date



10-22-12
 PLANS APPROVAL DATE

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NOTES:

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- FOR ACCURATE RIGHT OF WAY DATE, CONTACT RIGHT OF WAY ENGINEERING AT THE DISTRICT OFFICE
- CONNECT CNC FROM EXISTING CONTROLLER TO VALVES
- LOCATE AV AT HIGHEST POINT.
- LOCATE STEEL SOIL STAPLES ALONG PPI @ 3, C-C
- SECURE FITTING WITH 2 STEEL SOIL STAPLES.

STATE OF CALIFORNIA - DEPARTMENT OF TRANSPORTATION	LANDSCAPE ARCHITECTURE	SENIOR LANDSCAPE ARCHITECT	CALCULATED-DESIGNED BY	BONGKOD LOHMONGKOL	REVISOR BY
		RON RUSSAK	CHECKED BY	RON RUSSAK	DATE REVISED

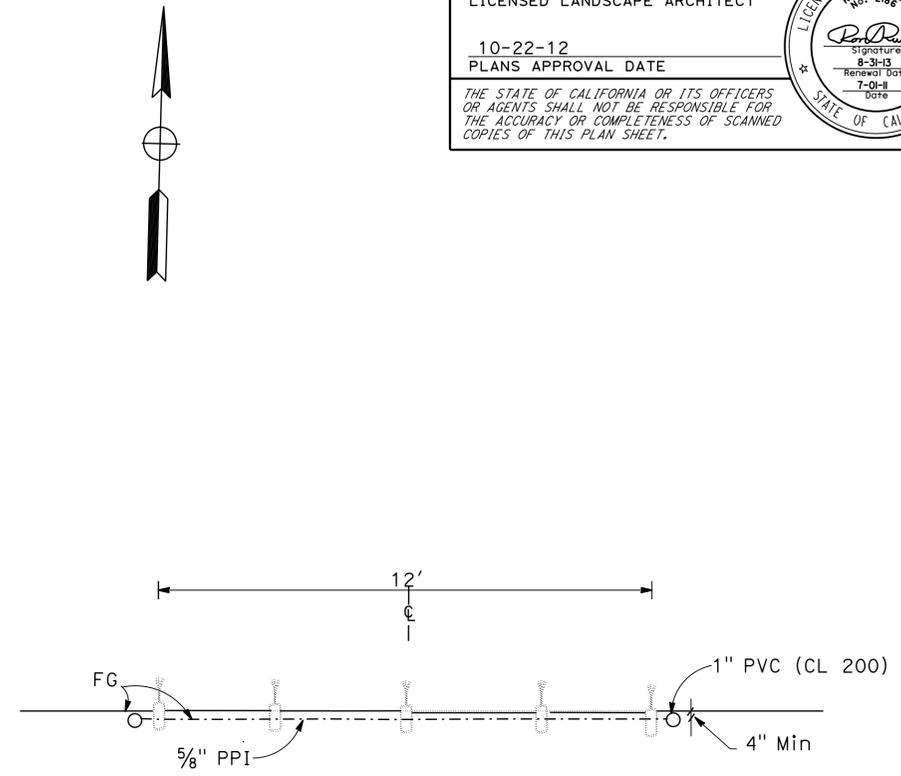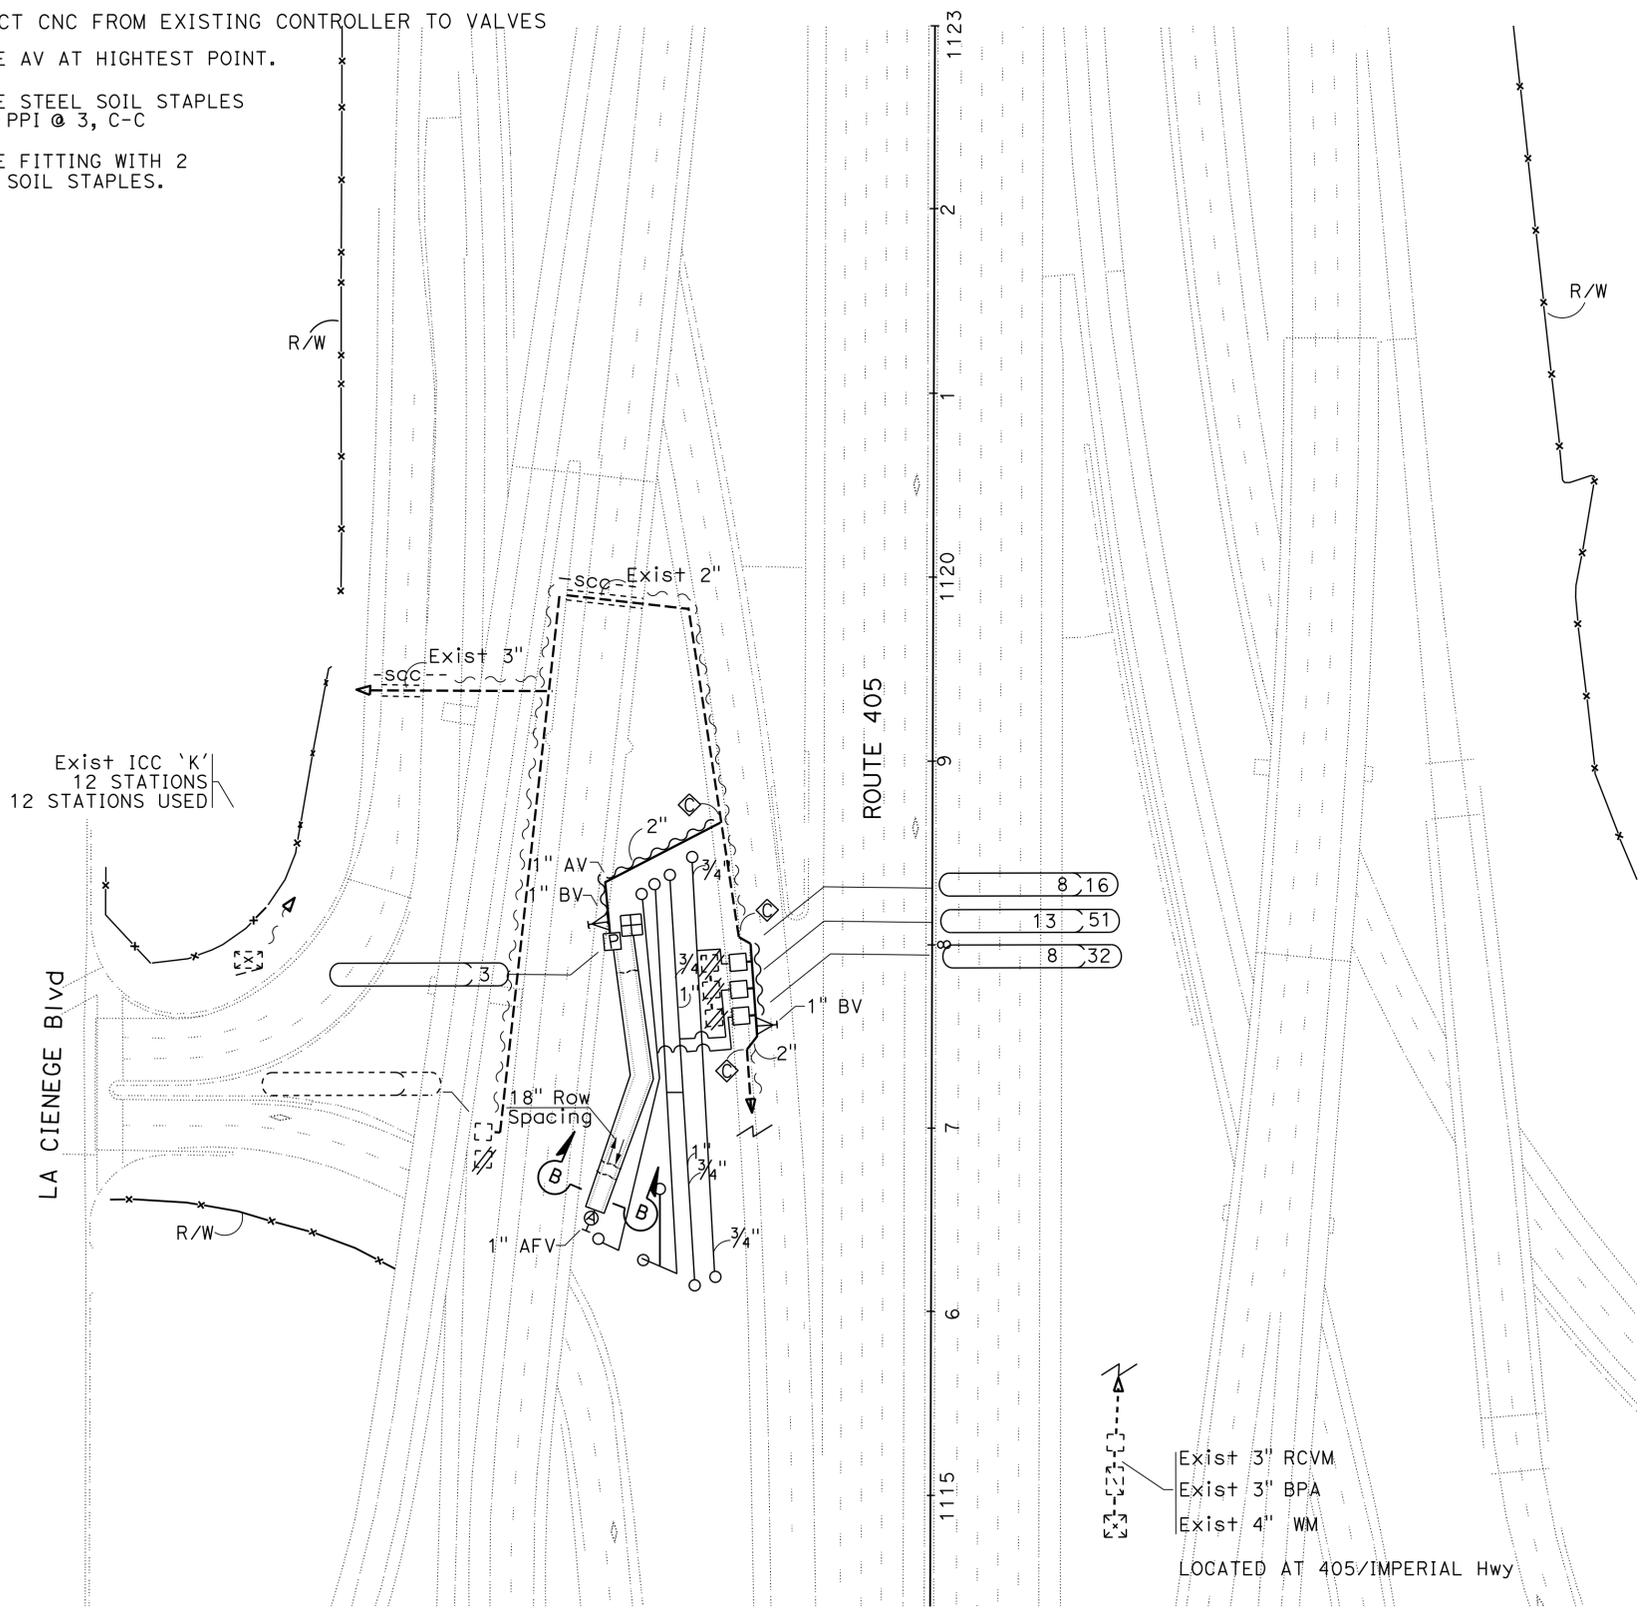

DRIP IRRIGATION SECTION B-B


Exist 3" RCVM
 Exist 3" BPA
 Exist 4" WM
 LOCATED AT 405/IMPERIAL Hwy

IRRIGATION PLAN


SCALE: 1" = 50'

IP-1


APPROVED FOR IRRIGATION WORK ONLY

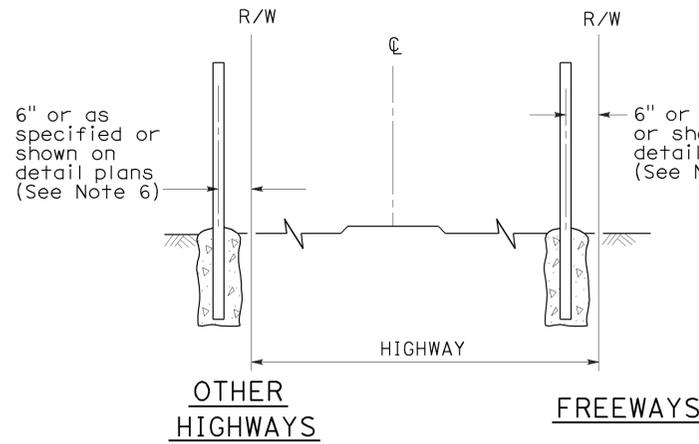

FENCE LOCATION


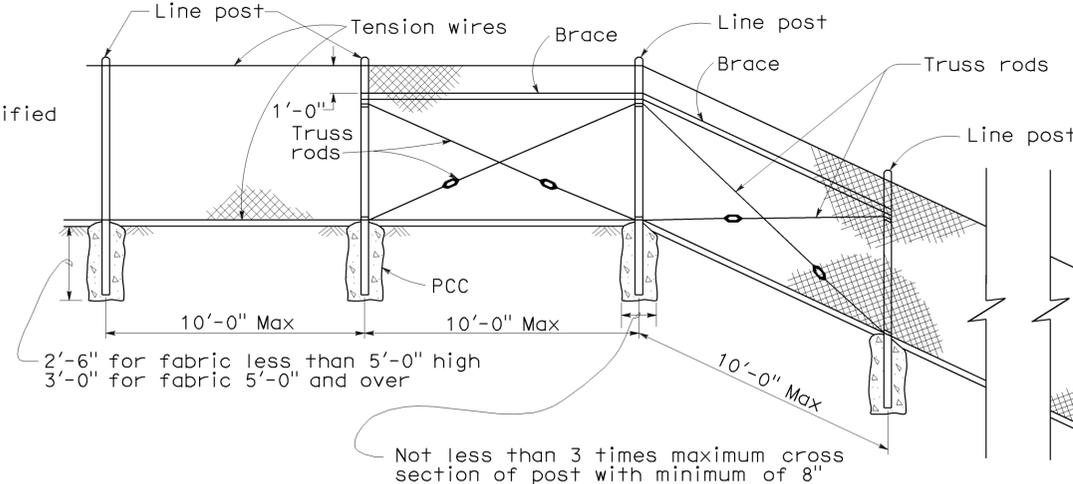


CHAIN LINK FENCE ON SHARP BREAK IN GRADE

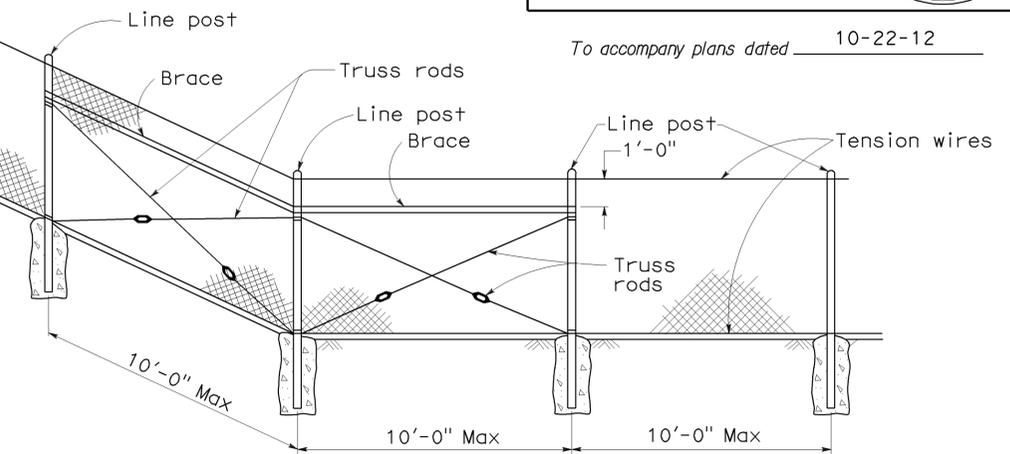

To accompany plans dated 10-22-12

Brace to be removed after all other fence construction is completed unless otherwise directed by the Engineer

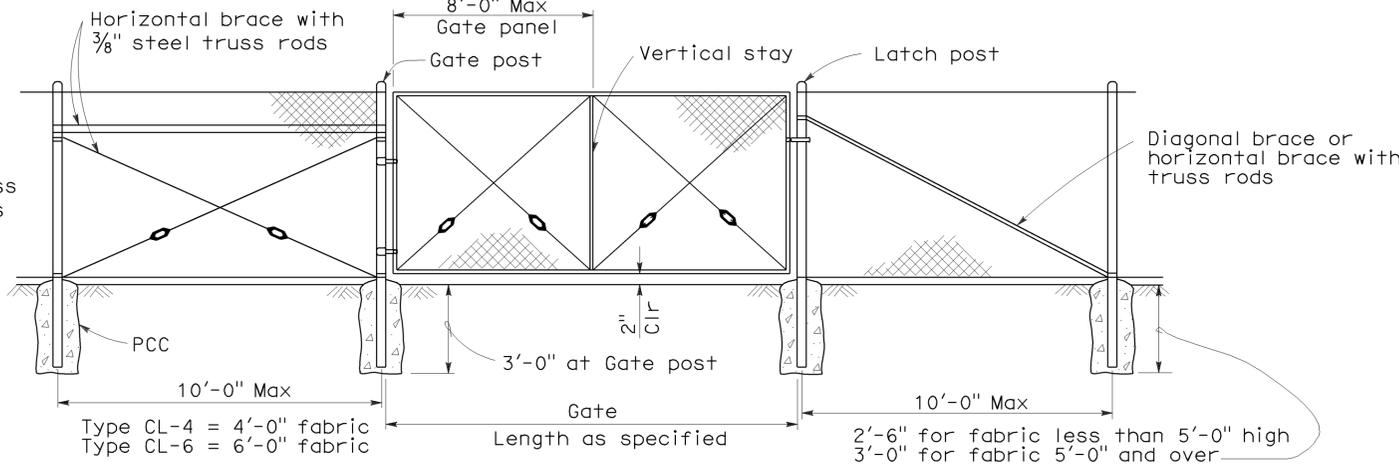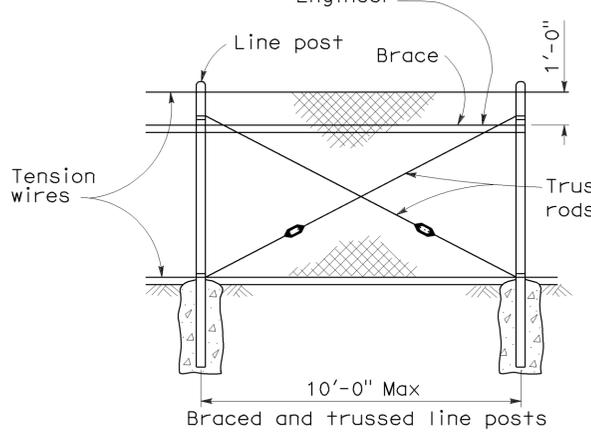

CHAIN LINK GATE INSTALLATION


GATE POST			
FENCE HEIGHT	GATE WIDTHS	NOMINAL ID	WEIGHT PER FOOT
6'-0" and Less	Up thru 6'-0"	2 1/2"	4.95 LB
	Over 6'-0" thru 12'-0"	4"	10.79 LB
	Over 12'-0" thru 18'-0"	5"	14.62 LB
	Over 18'-0" to 24'-0" Max	6"	18.97 LB
Over 6'-0"	Up thru 6'-0"	3"	7.58 LB
	Over 6'-0" thru 12'-0"	5"	14.62 LB
	Over 12'-0" thru 18'-0"	6"	18.97 LB
	Over 18'-0" to 24'-0" Max	8"	28.55 LB

Above post dimensions and weights are minimums. Larger sizes may be used on approval of the Engineer.

NOTES:

- The below table shows examples of post and brace sections which may comply with the Specifications.
- Sections shown in the tables must also comply with the strength requirements and other provisions of the Specifications.
- Other sections which comply with the strength requirements and other provisions of the Specifications may be used on approval of the Engineer.
- Options exercised shall be uniform on any one project.
- Dimensions shown are nominal.
- Offset to be 2'-0" at monument locations, measured at right angles to R/W lines. Taper to achieve offset to be at least 20'-0" long.

FENCE HEIGHT	TYPICAL MEMBER DIMENSIONS (See Notes)									
	LINE POSTS			END, LATCH & CORNER POSTS			BRACES			
	ROUND ID	H	ROLL FORMED	ROUND ID	ROLL FORMED		ROUND ID	H	ROLL FORMED	
6' & less	1 1/2"	1 7/8" x 1 5/8"	1 7/8" x 1 5/8"	2"	3 1/2" x 3 1/2"	2" x 1 3/4"	1 1/4"	1 1/2" x 1 5/16"	1 5/8" x 1 1/4"	1 3/4" x 1 1/4"
Over 6'	2"	2 1/4" x 2"	2" x 1 3/4"	2 1/2"	3 1/2" x 3 1/2"	2 1/2" x 2 1/2"	1 1/4"	1 1/2" x 1 5/16"	1 5/8" x 1 1/4"	1 3/4" x 1 1/4"

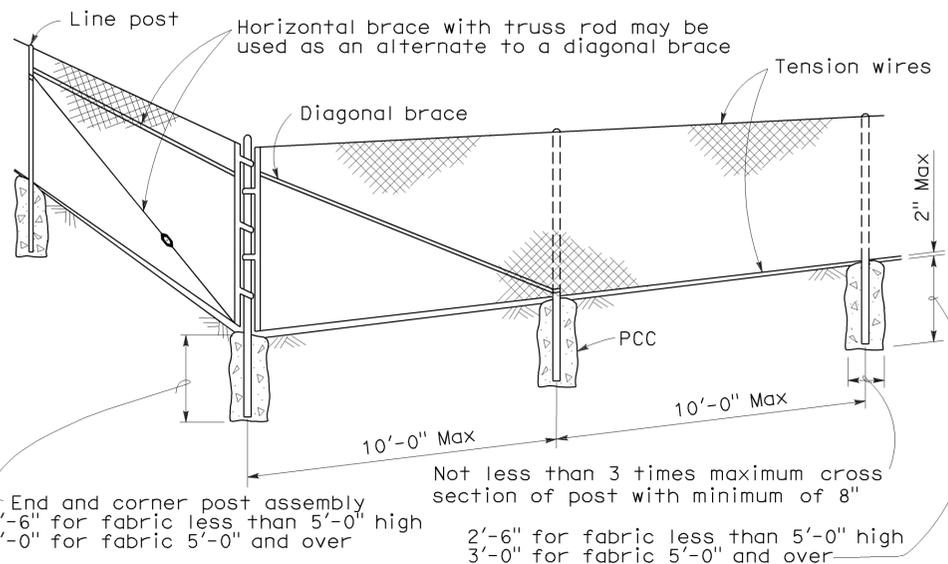

CORNER POST

STATE OF CALIFORNIA
DEPARTMENT OF TRANSPORTATION

CHAIN LINK FENCE

NO SCALE

RSP A85 DATED JUNE 5, 2009 SUPERSEDES STANDARD PLAN A85
DATED MAY 1, 2006 - PAGE 111 OF THE STANDARD PLANS BOOK DATED MAY 2006.

REVISED STANDARD PLAN RSP A85

2006 REVISED STANDARD PLAN RSP A85

DIST	COUNTY	ROUTE	POST MILES TOTAL PROJECT	SHEET NO.	TOTAL SHEETS
07	LA	5,10,14, 47,60,etc	Var	53	72


REGISTERED CIVIL ENGINEER
 Glenn DeCou
 No. C34547
 Exp. 9-30-09
 CIVIL
 STATE OF CALIFORNIA

June 5, 2009
 PLANS APPROVAL DATE


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To accompany plans dated 10-22-12


- NOTES:**
- H is 2'-6" for fabric less than 5'-0" high.
H is 3'-0" for fabric 5'-0" and over.
 - T is not less than 3 times maximum cross section of post with minimum of 8".
 - Arms with barbed wire to be used where shown on plans.
 - See Revised Standard Plan RSP A85 for Chain Link Fencing dimensions.
 - Reinforcing must comply with ASTM A 706.
 - See Detail A on New Standard Plan NSP A86B for connection at headwall.

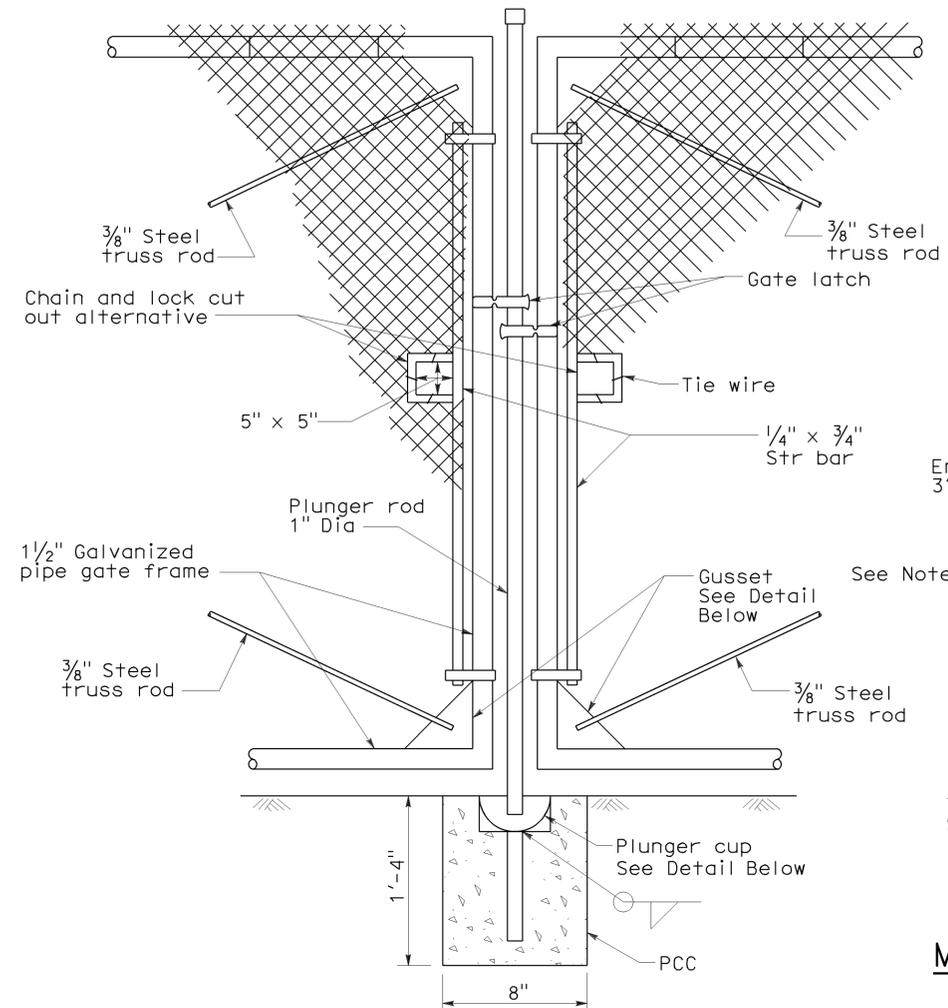


TYPICAL DOUBLE GATE REMOVABLE CENTER POST

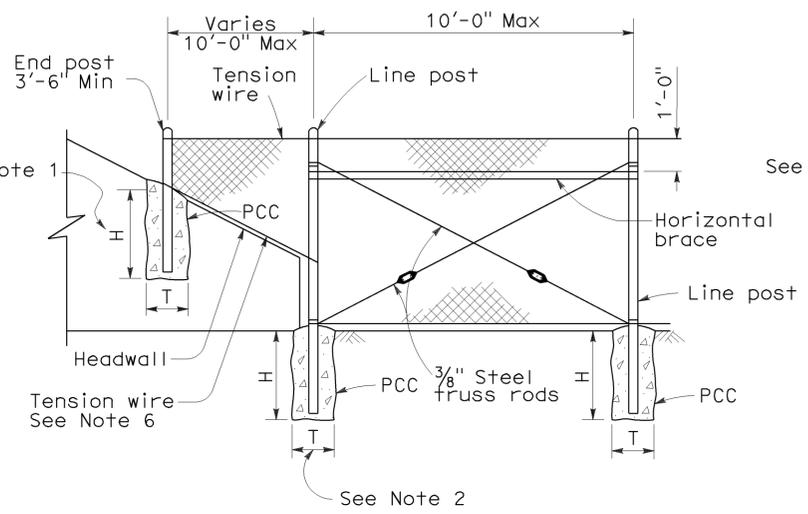


METHOD OF TYING FENCE TO HEADWALL

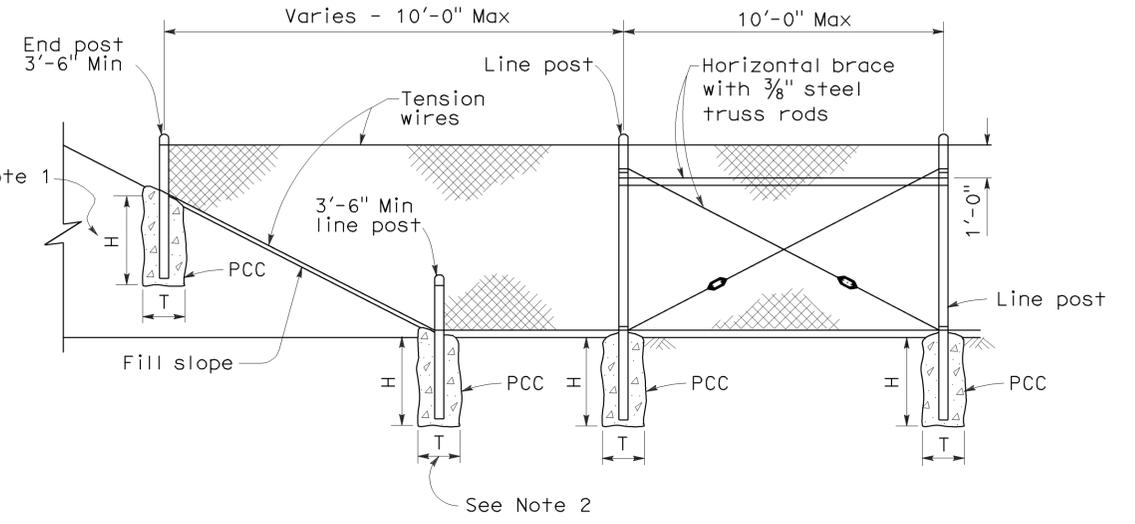


METHOD OF ERECTING FENCE FOR FILL SLOPE

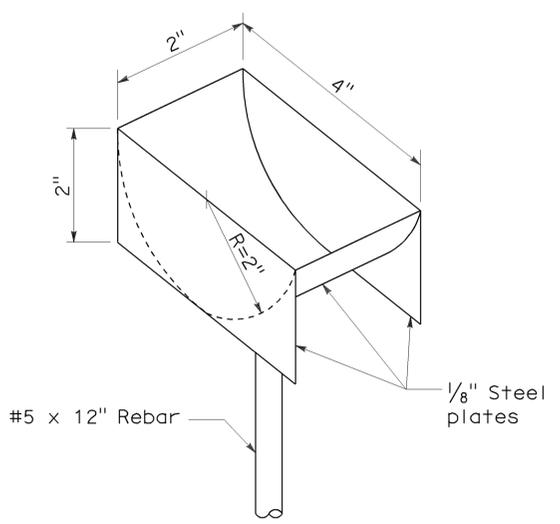



PLUNGER CUP DETAIL

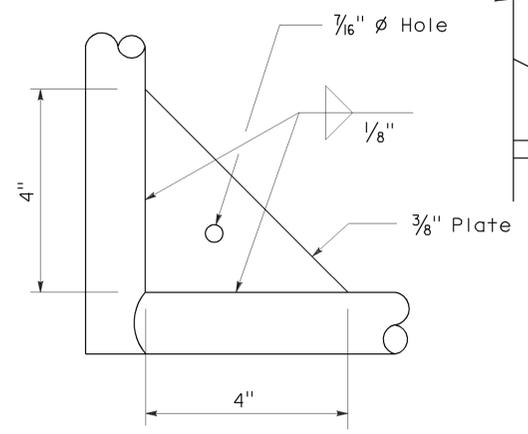


GUSSET DETAIL

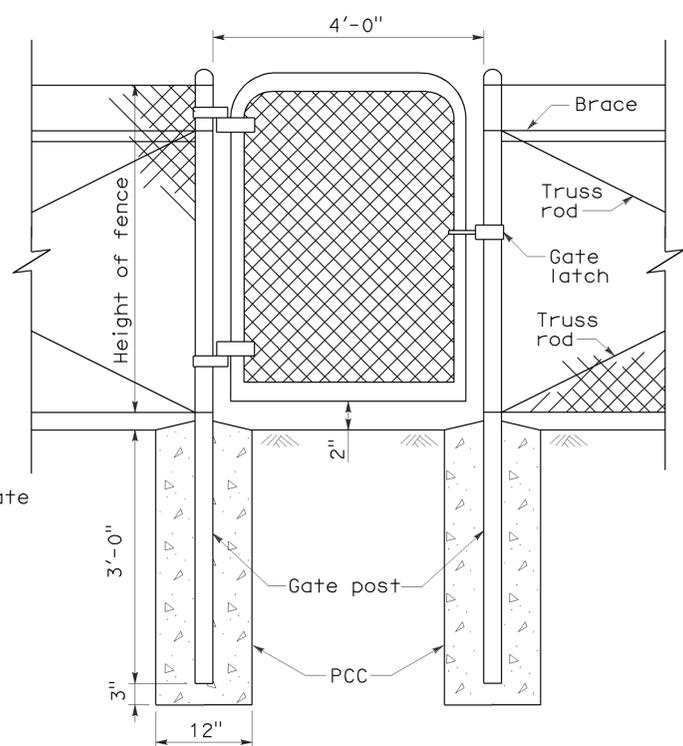

WALK GATE

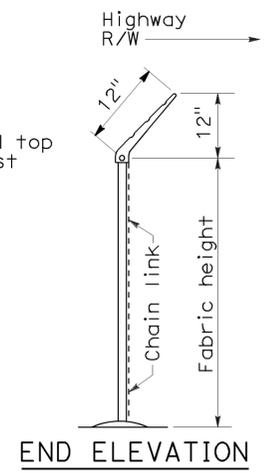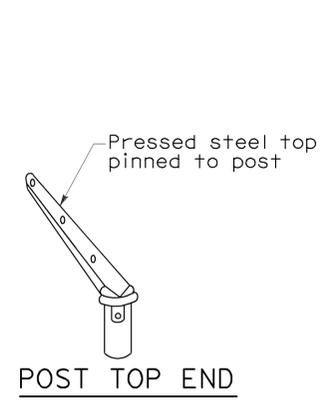

BARBED WIRE POST TOP
See Note 3

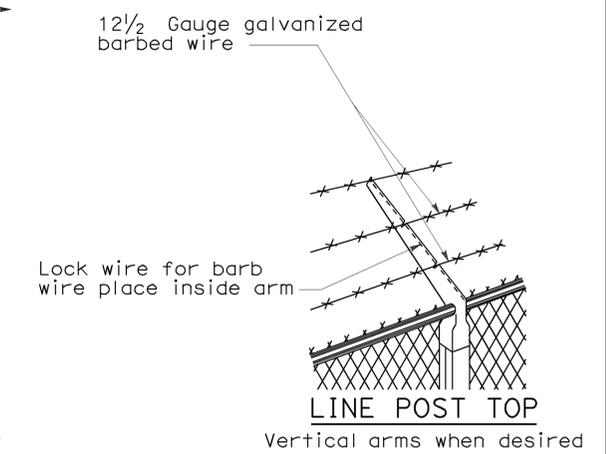

STATE OF CALIFORNIA
 DEPARTMENT OF TRANSPORTATION
CHAIN LINK FENCE DETAILS
 NO SCALE

NSP A85A DATED JUNE 5, 2009 SUPPLEMENTS THE STANDARD PLANS BOOK DATED MAY 2006.

NEW STANDARD PLAN NSP A85A

2006 NEW STANDARD PLAN NSP A85A


DIST	COUNTY	ROUTE	POST MILES TOTAL PROJECT	SHEET NO.	TOTAL SHEETS
07	LA	5,10,14, 47,60,etc	Var	54	72

Glenn DeCou
 REGISTERED CIVIL ENGINEER
 No. C34547
 Exp. 9-30-09
 STATE OF CALIFORNIA

June 5, 2009
 PLANS APPROVAL DATE


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To accompany plans dated 10-22-12

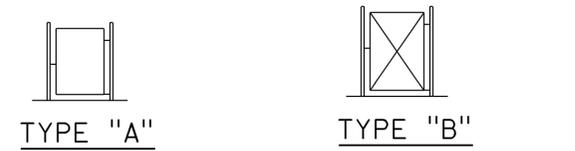

TYPE "A"
3' and 6' Single
6' and 12' Double


TYPE "B"
Over 6' to 12' Single.
Over 12' to 24' Double

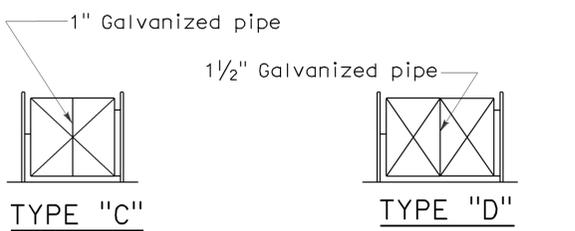


TYPE "C"
Over 12' to 18' Single
Over 24' to 36' Double.

TYPE "D"
Over 18' to 24' Single
Over 36' to 48' Double

TYPICAL FRAMEWORK SHOWING NUMBER OF BAYS IN GATE

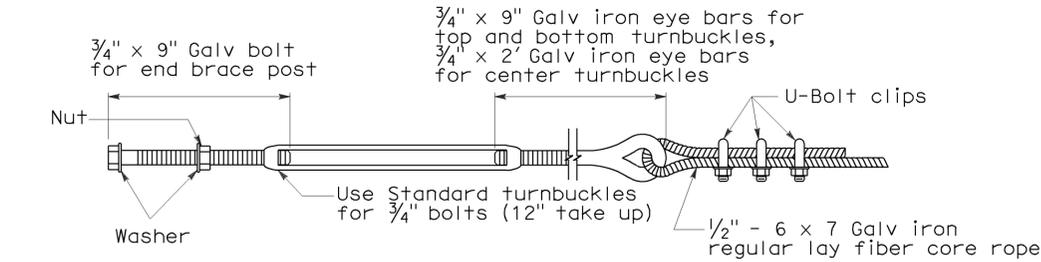


TURNBUCKLE A

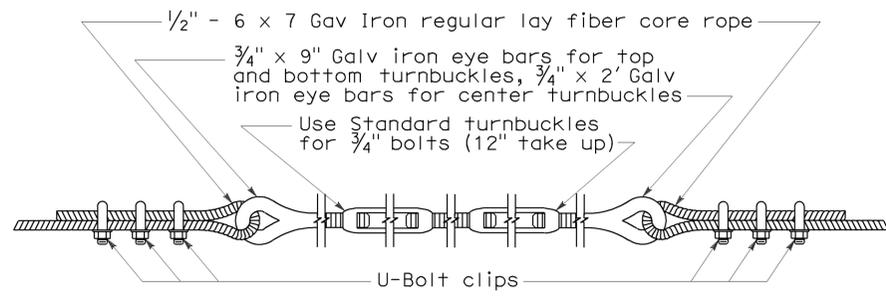


TURNBUCKLE B

NOTES:


1. All material for abutment connection to be galvanized.
2. The chain link fabric shall be replaced by barbed wire strands at 12" maximum centers between the double posts.
3. When the width of the culvert makes it necessary to anchor a post to the top of the culvert, a cast iron shoe or other device approved by the Engineer shall be used.
4. Fencing over stream and around headwall may also use Barbed Wire or Wire Mesh fencing with either wood post or steel post installation.
5. See Revised Standard Plan RSP A85 for Chain Link fence dimensions. See Standard Plan A86 for Barbed Wire and Wire Mesh fence dimensions and for wood post and steel post installation.

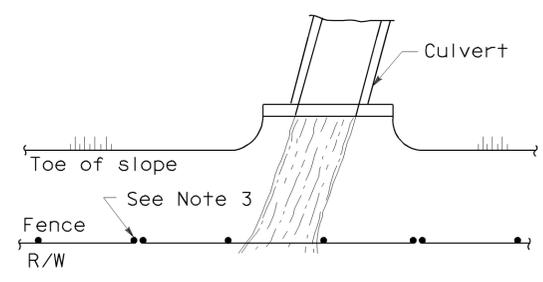

PLAN

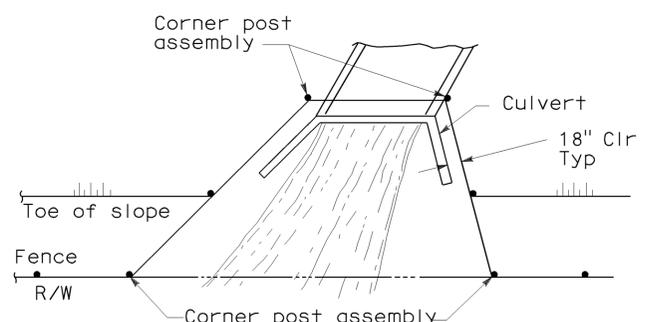


PLAN

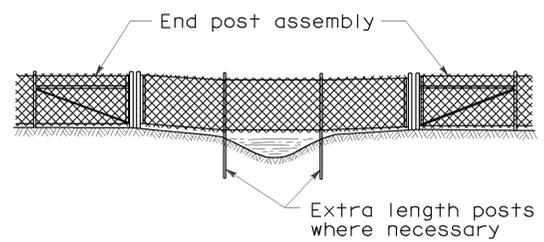

ELEVATION


INSTALLATION OVER STREAM

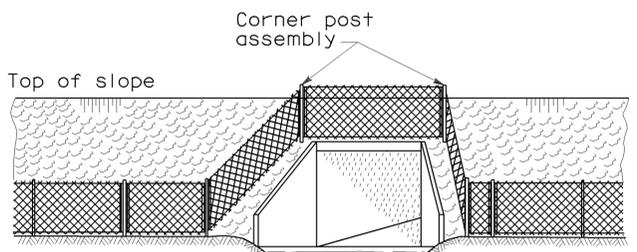


ELEVATION

INSTALLATION AROUND HEADWALL


See Note 4

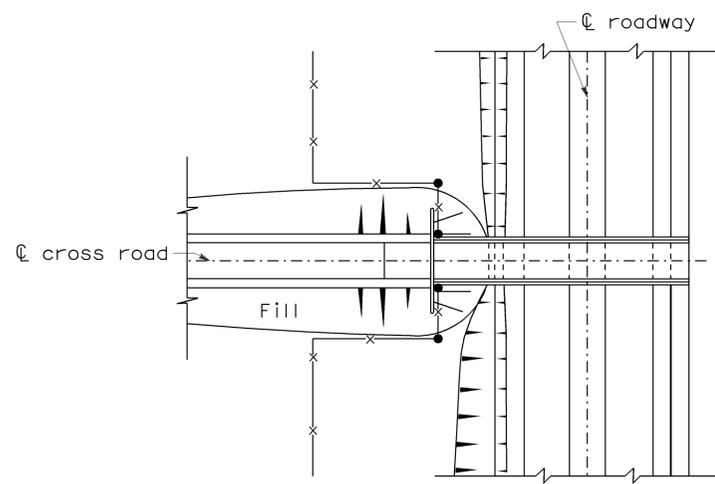

PLAN OF ROADWAY - UNDERPASS

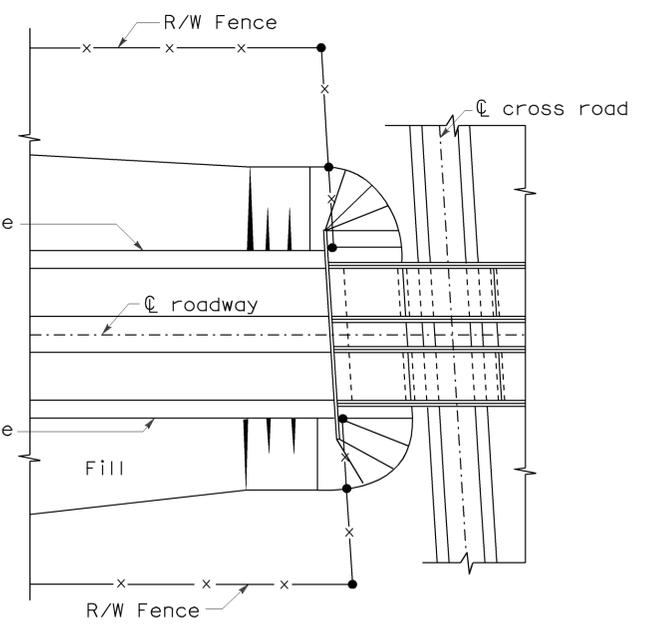

PLAN OF ROADWAY - OVERPASS

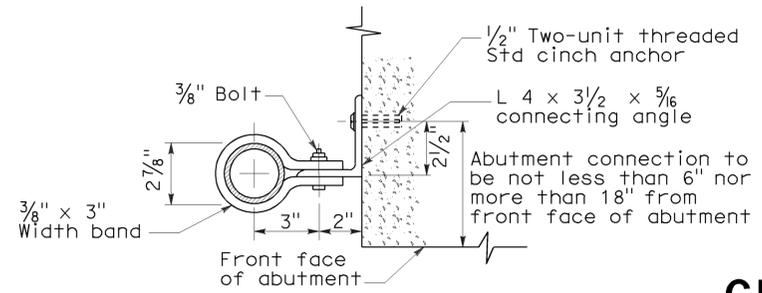

ABUTMENT CONNECTION

TYPICAL INSTALLATION AT BRIDGES


CHAIN LINK FENCE DETAILS

NO SCALE



NSP A85B DATED JUNE 5, 2009 SUPPLEMENTS THE STANDARD PLANS BOOK DATED MAY 2006.

NEW STANDARD PLAN NSP A85B


2006 NEW STANDARD PLAN NSP A85B

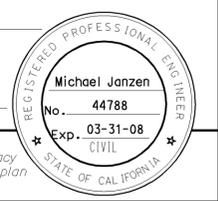

To accompany plans dated 10-22-12

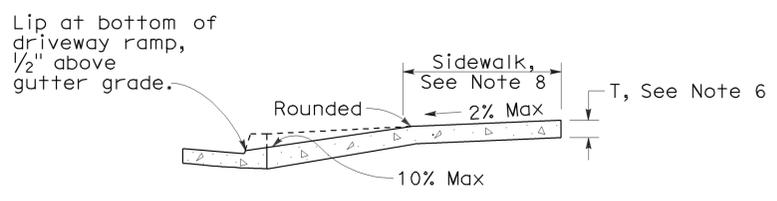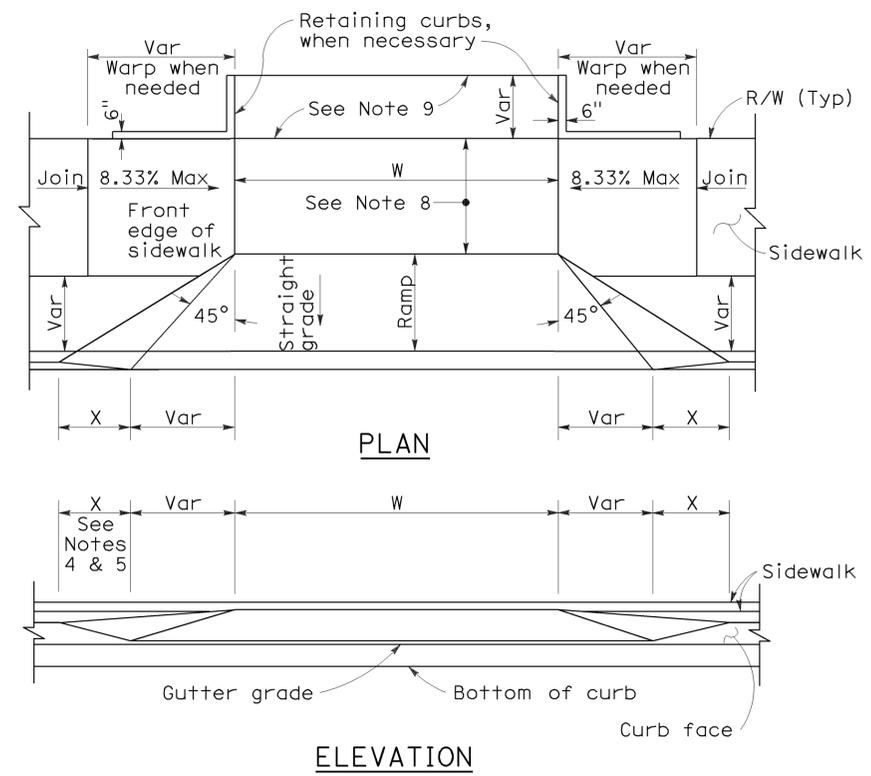

CASE A
Typical driveway, sidewalk not depressed

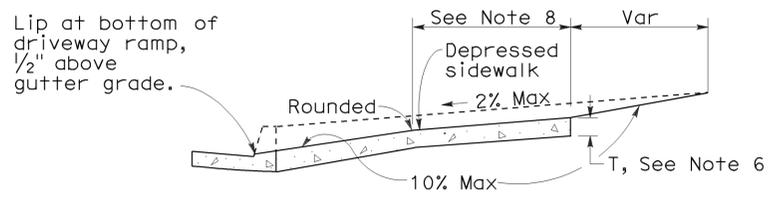

CASE B
Driveway with depressed sidewalk

SECTIONS


CURB QUANTITIES

TYPE	CUBIC YARDS PER LINEAR FOOT
A1-6	0.02585
A1-8	0.03084
A2-6	0.05903
A2-8	0.06379
A3-6	0.01036
A3-8	0.01435
B1-4	0.02185
B1-6	0.02930
B2-4	0.05515
B2-6	0.06171
B3-4	0.00641
B3-6	0.01074
B4	0.05709
D-4	0.04083
D-6	0.06804
E	0.06661


TABLE A

CURB TYPE	DIMENSIONS			
	"H1"	"H2"	"W1"	"W2"
A1-6	1'-2"	6"	7 1/2"	1 1/2"
A1-8	1'-4"	8"	8"	2"
A2-6	1'-0"	6"	2'-7 1/2"	1 1/2"
A2-8	1'-2"	8"	2'-8"	2"
A3-6	6"	5"	7 1/4"	1 1/4"
A3-8	8"	7"	7 3/4"	1 3/4"
B1-4	1'-0"	4"	7 1/2"	2 1/2"
B1-6	1'-2"	6"	9"	4"
B2-4	10"	4"	2'-7 1/2"	2 1/2"
B2-6	1'-0"	6"	2'-9"	4"
B3-4	4"	3"	7"	2"
B3-6	6"	5"	8 1/2"	3 1/2"
D-4	10"	4"	1'-6"	1'-1"
D-6	1'-0"	6"	2'-2"	1'-8"


DRIVEWAYS

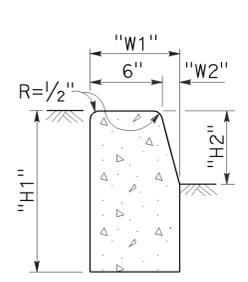


TYPE A1 CURBS
See Table A

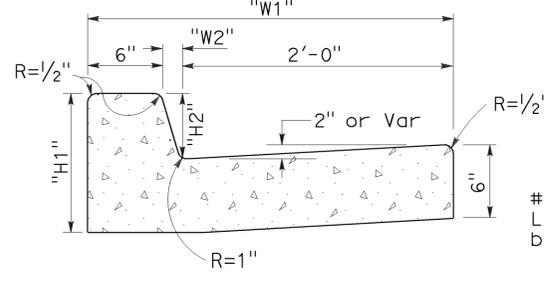


TYPE A2 CURBS
See Table A

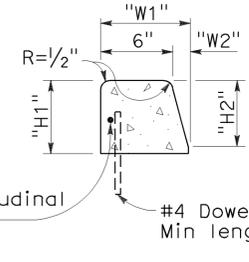


TYPE A3 CURBS
Superimposed on existing pavement
See Table A

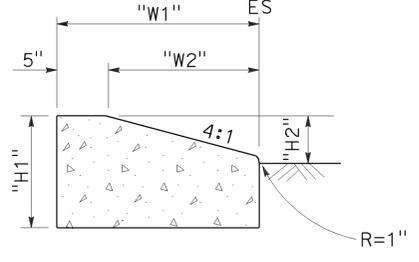


TYPE D CURBS
See Table A

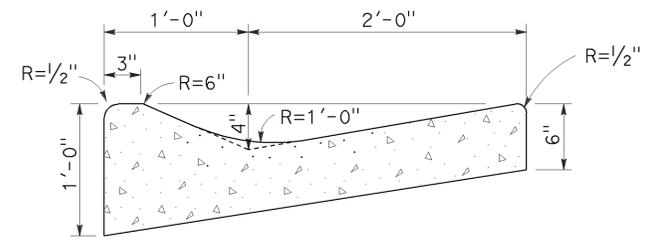


TYPE E CURB

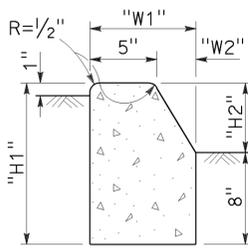


TYPE B1 CURBS
See Table A

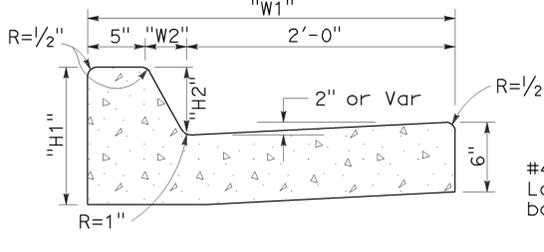


TYPE B2 CURBS
See Table A

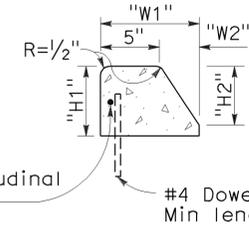

TYPE B3 CURBS
Superimposed on existing pavement
See Table A

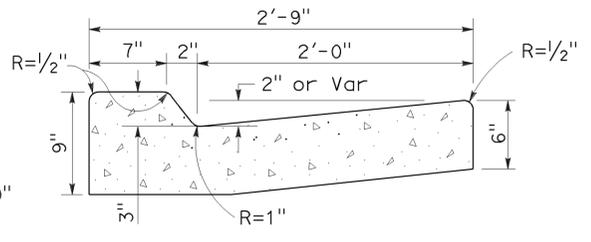

TYPE B4 CURBS

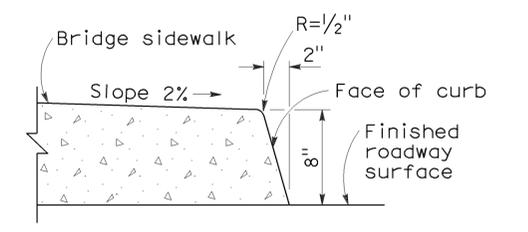

TYPE H CURB
On Bridges

CURBS

NOTES:

- Case A driveway section typically applies.
- Use Case B driveway section when ramp slopes would exceed 10% in Case A.
- Use Case B driveway section when sidewalk cross slope would exceed 2% in Case A.
- X=3'-0" except for curb heights over 10" where 4:1 slopes shall be used on curb slope.
- X is a variable when sidewalk is located where wheelchairs may traverse the surface. Slopes shall not exceed 8.33%.
- Sidewalk and ramp thickness "T" at driveway shall be 4" for residential and 6" for commercial.
- Difference in slope of the driveway ramp and the slope of a line between the gutter and a point on the roadway 5'-0" from gutter line shall not exceed 15%. Reduce driveway ramp slope, not gutter slope, where required.
- Minimum width of clear passageway for sidewalk shall be 4'-0".
- Retaining curbs and acquisition of construction easement may be necessary for narrow sidewalks or curb heights in excess of 6".
- Across the pedestrian route at curb ramp locations, the gutter pan slope shall not exceed 1" of depth for each 2'-0" of width.

STATE OF CALIFORNIA
DEPARTMENT OF TRANSPORTATION

CURBS AND DRIVEWAYS

NO SCALE

RSP A87A DATED NOVEMBER 17, 2006 SUPERSEDES STANDARD PLAN A87A
DATED MAY 1, 2006 - PAGE 113 OF THE STANDARD PLANS BOOK DATED MAY 2006.

REVISED STANDARD PLAN RSP A87A


2006 REVISED STANDARD PLAN RSP A87A

DIST	COUNTY	ROUTE	POST MILES TOTAL PROJECT	SHEET NO.	TOTAL SHEETS
07	LA	5,10,14, 47,60,etc	Var	56	72


Raymond Don Tsztoo
 REGISTERED CIVIL ENGINEER
 June 6, 2008
 PLANS APPROVAL DATE
 No. C37332
 Exp. 6-30-08
 CIVIL
 STATE OF CALIFORNIA

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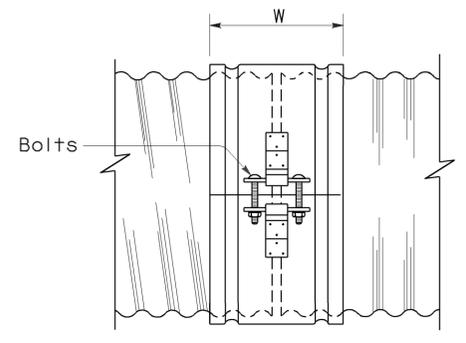
To accompany plans dated 10-22-12

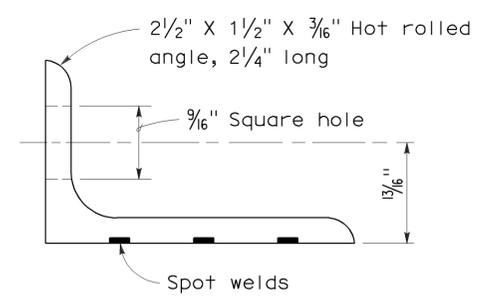


ANGLE

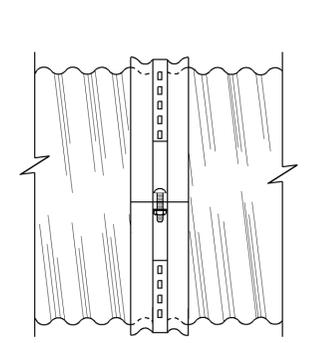

SIDE VIEW ANGLE




SIDE VIEW SINGLE BAR AND STRAP

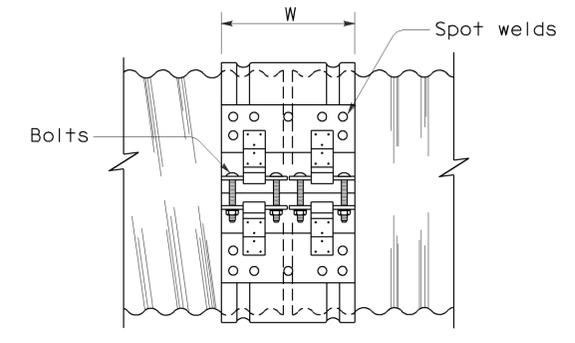


SIDE VIEW DOUBLE BAR AND STRAP

NOTES:


1. All ferrous metal coupling band connection hardware shall be galvanized or electroplated in accordance with the Standard Specifications.
2. Dimensions and thicknesses shown are minimum.
3. Spot welds shall develop minimum required strength of strap.
4. Fillet welds of equivalent strength may be substituted for spot welds or rivets.
5. Dimension depends upon whether end condition is lips up or lips down.

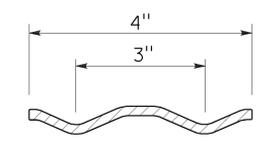


SECTION H-4 HUGGER BAND

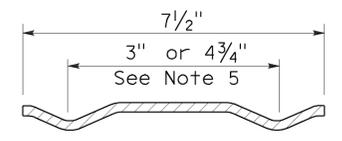

SECTION H-7 HUGGER BAND

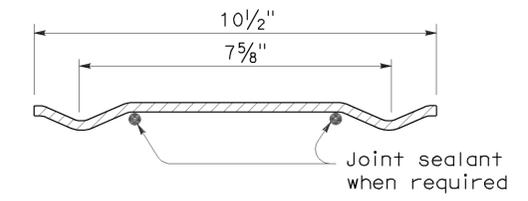

SECTION H-10 HUGGER BAND

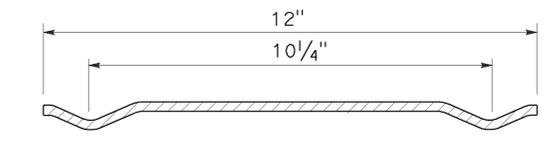

SECTION H-12 HUGGER BAND

HUGGER COUPLING BANDS

STATE OF CALIFORNIA
 DEPARTMENT OF TRANSPORTATION
**CORRUGATED METAL PIPE
 COUPLING DETAILS No. 4
 HUGGER COUPLING BANDS**

NO SCALE

RSP D97D DATED JUNE 6, 2008 SUPERSEDES STANDARD PLAN D97D
 DATED MAY 1, 2006 - PAGE 186 OF THE STANDARD PLANS BOOK DATED MAY 2006.

REVISED STANDARD PLAN RSP D97D

2006 REVISED STANDARD PLAN RSP D97D

ANNULAR AND HELICAL PROFILE

COUPLING TYPE	PIPE CORRUGATION	PIPE SIZE	W OR A	PIPE WALL THICKNESS				BAR AND STRAP (CSP ONLY)				ANGLE									
				CSP		CAP		STRAP THICKNESS	BOLTS Dia	BAR Dia	BAR YIELD STRENGTH	DIMENSIONS		BOLTS (No.- Dia)		RIVETS ANGLE TO BAND		SPOT WELDS ANGLE TO BAND			
				CSP	CAP	CSP	CAP					CSP	CAP	CSP	CAP	CSP	CAP	CSP			
TWO PIECE INTEGRAL FLANGE	1 1/2' x 1/4"	6"-10"	7"	0.052"-0.079"	0.048"-0.060"	0.052"	0.060"								2-3/8"	2-3/8"					
				12"-18"	7"	0.052"-0.079"		0.064"									2-1/2"				
				2 2/3' x 1/2"	12"-24"	7"	0.052"-0.079"	0.060"-0.105"	0.064"	0.060"								2-1/2"	2-1/2"		
UNIVERSAL	2 2/3' x 1/2"	THROUGH 36"	12"	0.052"-0.138"	0.060"-0.135"	0.052"	0.060"						2" x 2" x 3/16"	2" x 2" x 3/16"	3-1/2"	3-1/2"	3-3/8"	3-3/8"	3-1/2"		
		42"-60"	12"	0.052"-0.168"	0.075"-0.164"	0.052"	0.060"							2" x 2" x 3/16"	2" x 2" x 3/16"	3-1/2"	3-1/2"	3-3/8"	3-3/8"	5-1/2"	
		THROUGH 72"	12"	0.052"-0.168"	0.164"	0.052"	0.105"	0.079"	1/2"	7/8"	32 ksi	2" x 2" x 3/16"	2" x 2" x 3/16"	3-1/2"	3-1/2"	3-3/8"	3-3/8"	5-1/2"			
ANNULAR	2 2/3' x 1/2"	THROUGH 36"	7"	0.064"-0.138"	0.060"-0.135"	0.052"	0.060"	0.079"	1/2"	7/8"	32 ksi	2" x 2" x 3/16"	2" x 2" x 3/16"	2-1/2"	2-1/2"	3-3/8"	3-3/8"	3-1/2"			
		42"-72"	12"	0.064"-0.168"	0.075"-0.164"	0.052"	0.105"	0.079"	1/2"	7/8"	32 ksi	2" x 2" x 3/16"	2" x 2" x 3/16"	3-1/2"	3-1/2"	3-3/8"	3-3/8"	5-1/2"			
		78"-84"	12"	0.168"		0.079"		0.109"	1/2"	7/8"	45 ksi	2" x 2" x 3/16"		3-1/2"		3-3/8"		5-1/2"			
	3" x 1"	48"-90"	14"	0.064"-0.109"		0.052"		0.079"	1/2"	7/8"	32 ksi	2" x 2" x 3/16"		3-1/2"		3-3/8"		5-1/2"			
		96"-120"	14"	0.079"-0.109"		0.052"		0.109"	1/2"	7/8"	45 ksi	2" x 2" x 3/16"		3-1/2"		4-3/8"					
		42"-108"	14"		0.060"-0.135"		0.060"						2" x 2" x 3/16"		3-1/2"		3-3/8"				
HELICAL	2 2/3' x 1/2"	THROUGH 36"	12"	0.052"-0.138"	0.060"-0.135"	0.052"	0.060"	0.079"	1/2"	7/8"	32 ksi	2" x 2" x 3/16"	2" x 2" x 3/16"	3-1/2"	3-1/2"	3-3/8"	3-3/8"	3-1/2"			
		42"-72"	12"	0.052"-0.168"	0.075"-0.164"	0.052"	0.060"	0.079"	1/2"	7/8"	32 ksi	2" x 2" x 3/16"	2" x 2" x 3/16"	3-1/2"	3-1/2"	3-3/8"	3-3/8"	5-1/2"			
		78"-84"	12"	0.168"		0.079"		0.109"	1/2"	7/8"	45 ksi	2" x 2" x 3/16"		3-1/2"		3-3/8"		5-1/2"			
	3" x 1"	48"-90"	14"	0.064"-0.109"		0.052"		0.079"	1/2"	7/8"	32 ksi	2" x 2" x 3/16"		3-1/2"		3-3/8"		5-1/2"			
		96"-120"	14"	0.079"-0.109"		0.052"		0.109"	1/2"	7/8"	45 ksi	2" x 2" x 3/16"		3-1/2"		4-3/8"					
		42"-108"	14"		0.060"-0.135"		0.060"						2" x 2" x 3/16"		3-1/2"		3-3/8"				
HUGGER	2 2/3' x 1/2"	REROLLED END	12"-54"	4"	0.052"-0.109"		0.052"					2 1/2" x 1 1/2" x 3/16"	2 1/2" x 1 1/2" x 3/16"	1-1/2"				3-1/2"			
			60"-66"	4"	0.109"		0.064"						2 1/2" x 1 1/2" x 3/16"	2 1/2" x 1 1/2" x 3/16"	1-1/2"			3-1/2"			
			36"-48"	4"	0.138"		0.064"						2 1/2" x 1 1/2" x 3/16"	2 1/2" x 1 1/2" x 3/16"	1-1/2"			3-1/2"			
		THROUGH 72"	10 1/2"	0.052"-0.168"		0.052"		0.079"	1/2"	7/8"	32 ksi										
		78"-84"	10 1/2"	0.168"		0.079"		0.109"	1/2"	7/8"	45 ksi										
		THROUGH 72"	10 1/2"	0.052"-0.168"		0.052"		0.079"	1/2"	7/8"	32 ksi										
	3" x 1"	REROLLED END	48"-90"	10 1/2"	0.064"-0.109"		0.052"		0.079"	1/2"	7/8"	32 ksi									
			96"-120"	10 1/2"	0.079"-0.109"		0.052"		0.109"	1/2"	7/8"	45 ksi									
			48"-66"	7 1/2"	0.064"-0.109"		0.064"		0.079"	1/2"	7/8"	32 ksi	2 1/2" x 1 1/2" x 3/16"	2 1/2" x 1 1/2" x 3/16"	1-1/2"				3-1/2"		
		72"-90"	7 1/2"	0.064"-0.079"		0.064"		0.079"	1/2"	7/8"	32 ksi	2 1/2" x 1 1/2" x 3/16"	2 1/2" x 1 1/2" x 3/16"	1-1/2"				3-1/2"			
		48"-90"	7 1/2"	0.064"-0.138"		0.064"		0.079"	1/2"	7/8"	32 ksi										
		48"-120"	12" SEE NOTE	0.064"-0.109"		0.064"		0.079"	1/2"	7/8"	32 ksi										
5" x 1"	REROLLED END	48"-84"	12" NOTE	0.138"		0.064"		0.079"	1/2"	7/8"	32 ksi										
		90"-120"	12" 11	0.138"		0.064"		0.079"	1/2"	7/8"	32 ksi										
		DOUBLE 0.079"	1/2"	7/8"	32 ksi																

SPIRAL RIB PROFILE

COUPLING TYPE	PIPE CORRUGATION	PIPE SIZE	W	PIPE WALL THICKNESS				BAR AND STRAP (SSRP ONLY)				ANGLE						
				SSRP		ASRP		STRAP THICKNESS	BOLTS Dia	BAR Dia	BAR YIELD STRENGTH	DIMENSIONS		BOLTS (No.- Dia)		RIVETS ANGLE TO BAND		SPOT WELDS ANGLE TO BAND
				SSRP	ASRP	SSRP	ASRP					SSRP	ASRP	SSRP	ASRP	SSRP	ASRP	SSRP
ANNULAR	2 2/3' x 1/2" * REROLLED END	24"-36"	12"	0.064"-0.109"	0.060"-0.105"	0.052"	0.060"	0.079"	1/2"	7/8"	32 ksi	2" x 2" x 3/16"	2" x 2" x 3/16"	3-1/2"	3-1/2"	3-3/8"	3-3/8"	5-1/2"
		42"-60"	12"	0.064"-0.109"	0.075"-0.105"	0.052"	0.105"	0.079"	1/2"	7/8"	32 ksi	2" x 2" x 3/16"	2" x 2" x 3/16"	3-1/2"	3-1/2"	3-3/8"	3-3/8"	5-1/2"
		66"-72"	12"	0.064"-0.109"		0.052"		0.079"	1/2"	7/8"	32 ksi	2" x 2" x 3/16"	2" x 2" x 3/16"	3-1/2"	3-1/2"	3-3/8"	3-3/8"	5-1/2"
		78"-114"	12"	0.079"-0.109"		0.079"		0.109"	1/2"	7/8"	45 ksi	2" x 2" x 3/16"	2" x 2" x 3/16"	3-1/2"	3-1/2"	3-3/8"	3-3/8"	5-1/2"
HUGGER	2 2/3' x 1/2" * REROLLED END	24"-72"	10 1/2"	0.064"-0.109"		0.052"		0.079"	1/2"	7/8"	32 ksi							
		78"-84"	10 1/2"	0.109"		0.079"		0.109"	1/2"	7/8"	45 ksi							

* See Note 14.

14. All profiles of Spiral Rib Pipe (3/4" x 3/4" ribs at 7 1/2" pitch and 3/4" x 1" ribs at 11 1/2" pitch in both steel and aluminum and 3/4" x 1" ribs at 8 1/2" pitch in steel only) shall be manufactured with rerolled ends. Corrugation profile of the rerolled ends shall be 2 2/3' x 1/2" annual corrugations with a minimum of two full corrugations at each end.

- NOTES:** To accompany plans dated 10-22-12
- All ferrous metal coupling band connection hardware shall be galvanized or electroplated in accordance with the Standard Specifications.
 - For helically corrugated coupling bands, the connection angles may be oriented parallel to the pipe axis, provided connecting holes are slotted lengthwise sufficiently to allow adjustment for the helix angle.
 - Tension strap may be connected to band with either spot welds or fillet welds that develop minimum required strength of strap.
 - Use 1 1/4" gage line dimension on attached angle leg for rivets and spot welds.
 - Band thickness shall not be less than:
 - 3 standard thicknesses lighter than the thickness of the pipe for Corrugated Steel Pipe.
 - 2 standard thicknesses lighter than the thickness of the pipe and in no case lighter than 0.060" for Corrugated Aluminum Pipe.
 - Dimensions, thicknesses and strengths shown are minimum.
 - For pipe arches use same width band as for round pipe of equal periphery.
 - Fillet welds of equivalent strength may be substituted for spot welds or rivets.
 - Spot welds shall develop minimum required strength of strap.
 - Pipe with rerolled ends having at least two 2 2/3' x 1/2" annular corrugations at each end with or without an upturned flange may be connected with any of the annular coupling bands shown for pipe of the same diameter and wall thickness and having 2 2/3' x 1/2" corrugations.
 - In the case of H-12 huggerbands, two piece bands are required for diameters through 96" and three piece bands are required for diameters 102" through 120".
 - Two piece bands are required for pipes greater than 42" diameter.
 - The 2 1/4" x 2" x 0.109" thick galvanized die-formed angle connector may be used in lieu of the 2" x 2" x 3/16" angle connector for standard joints only on pipes through 72" diameter.

STATE OF CALIFORNIA
DEPARTMENT OF TRANSPORTATION
**CORRUGATED METAL PIPE
COUPLING DETAILS No. 5
STANDARD JOINT**
NO SCALE

RSP D97E DATED JUNE 6, 2008 SUPERSEDES STANDARD PLAN D97E
DATED MAY 1, 2006 - PAGE 187 OF THE STANDARD PLANS BOOK DATED MAY 2006.

REVISED STANDARD PLAN RSP D97E

DIST	COUNTY	ROUTE	POST MILES TOTAL PROJECT	SHEET NO.	TOTAL SHEETS
07	LA	5,10,14, 47,60,etc	Var	57	72

Raymond Don Tsztou
REGISTERED CIVIL ENGINEER

June 6, 2008
PLANS APPROVAL DATE

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REGISTERED PROFESSIONAL ENGINEER
Raymond Don Tsztou
No. C37332
Exp. 6-30-08
CIVIL
STATE OF CALIFORNIA

2006 REVISED STANDARD PLAN RSP D97E

ANNULAR AND HELICAL PROFILE

DIST	COUNTY	ROUTE	POST MILES TOTAL PROJECT	SHEET NO.	TOTAL SHEETS
07	LA	5,10,14, 47,60,etc	Var	58	72

Raymond Don Tsztso
REGISTERED CIVIL ENGINEER

June 6, 2008
PLANS APPROVAL DATE

STATE OF CALIFORNIA
REGISTERED PROFESSIONAL ENGINEER
Raymond Don Tsztso
No. C37332
Exp. 6-30-08
CIVIL

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COUPLING TYPE	PIPE CORRUGATION	PIPE SIZE	W OR A	PIPE WALL THICKNESS		BAND THICKNESS		BAR AND STRAP (CSP ONLY)				ANGLE							
				CSP	CAP	CSP	CAP	STRAP THICKNESS	BOLTS Dia	BAR Dia	BAR YIELD STRENGTH	DIMENSIONS		BOLTS (No. - Dia)		RIVETS ANGLE TO BAND		SPOT WELDS ANGLE TO BAND	
												CSP	CAP	CSP	CAP	CSP	CAP	CSP	CAP
TWO PIECE INTEGRAL FLANGE	1 1/2" x 1/4"	6"-10"	7"	0.064"-0.079"	0.060"	0.064"	0.060"							2-3/8"	2-3/8"				
	2 2/3" x 1/2"	12"-24"	12"		0.060"-0.105"		0.060"								3-1/2"				
UNIVERSAL	2 2/3" x 1/2"	THROUGH 36"	12"	0.064"-0.138"	0.060"-0.135"	0.064"	0.060"	0.079"	1/2"	7/8"	32 ksi	2" x 2" x 3/16"	2" x 2" x 3/16"	3-1/2"	3-1/2"	3-3/8"	3-3/8"	5-1/2"	
		42"-60"	16 1/4"	0.064"-0.168"	0.060"-0.164"	0.064"	0.060"	DOUBLE 0.079"	1/2"	7/8"	32 ksi	2" x 2" x 1/4"	2" x 2" x 1/4"	4-1/2"	4-1/2"	5-3/8"	5-3/8"		
ANNULAR	2 2/3" x 1/2"	THROUGH 36"	12"	0.064"-0.138"	0.060"-0.135"	0.064"	0.060"					2" x 2" x 3/16"	2" x 2" x 3/16"	3-1/2"	3-1/2"	3-3/8"	3-3/8"	5-1/2"	
		42"-60"	12"	0.064"-0.079"		0.064"							2" x 2" x 3/16"		3-1/2"		3-3/8"		5-1/2"
		42"-60"	12"	0.109"-0.168"	0.135"-0.164"	0.064"	0.075"						2" x 2" x 1/4"	2" x 2" x 1/4"	3-1/2"	3-1/2"	5-3/8"	5-3/8"	
		66"-72"	24"		0.164"		0.105"						2" x 2" x 1/4"	2" x 2" x 1/4"		5-1/2"		5-1/2"	
		66"-84"	24"	0.109"-0.168"		0.064"							2" x 2" x 1/4"		5-1/2"		7-3/8"		
		42"-54"	12"		0.060"-0.105"		0.060"						2" x 2" x 3/16"		3-1/2"		3-3/8"		
	3" x 1"	48"-60"	14"	0.064"-0.079"		0.064"							2" x 2" x 3/16"		3-1/2"		3-3/8"		5-1/2"
		48"-60"	14"	0.109"		0.064"							2" x 2" x 3/16"		3-1/2"		5-3/8"		
		66"-120"	25"	0.064"-0.109"		0.064"							2" x 2" x 3/16"		5-1/2"		9-3/8"		
		42"-60"	14"		0.060"-0.105"		0.060"						2" x 2" x 3/16"		3-1/2"		5-3/8"		
		42"-60"	14"		0.135"		0.075"						2" x 2" x 1/4"		3-1/2"		5-3/8"		
		66"-96"	25"		0.060"-0.135"		0.060"						2" x 2" x 1/4"		5-1/2"		7-3/8"		
	HELICAL	2 2/3" x 1/2"	THROUGH 36"	12"	0.064"-0.138"	0.060"-0.135"	0.064"	0.060"					2" x 2" x 3/16"	2" x 2" x 3/16"	3-1/2"	3-1/2"	3-3/8"	3-3/8"	5-1/2"
			42"-54"	12"		0.060"-0.105"		0.060"					2" x 2" x 3/16"		3-1/2"		3-3/8"		
42"-60"			12"	0.064"-0.079"		0.064"							2" x 2" x 3/16"		3-1/2"		3-3/8"		5-1/2"
42"-60"			12"	0.109"-0.168"	0.135"-0.164"	0.064"	0.075"						2" x 2" x 1/4"	2" x 2" x 1/4"	3-1/2"	3-1/2"	5-3/8"	5-3/8"	
66"-84"			24"	0.109"-0.168"		0.064"							2" x 2" x 1/4"		5-1/2"		7-3/8"		
66"-72"		24"		0.164"		0.105"						2" x 2" x 1/4"		5-1/2"		5-3/8"			
3" x 1"		48"-60"	14"	0.064"-0.079"		0.064"							2" x 2" x 3/16"		3-1/2"		3-3/8"		5-1/2"
		48"-60"	14"	0.109"		0.064"							2" x 2" x 3/16"		3-1/2"		5-3/8"		
		66"-120"	25"	0.064"-0.109"		0.064"							2" x 2" x 3/16"		5-1/2"		9-3/8"		
		42"-60"	14"		0.060"-0.105"		0.060"						2" x 2" x 3/16"		3-1/2"		5-3/8"		
	42"-60"	14"		0.135"		0.075"						2" x 2" x 1/4"		3-1/2"		5-3/8"			
HUGGER	2 2/3" x 1/2" REROLLED END	THROUGH 48"	10 1/2"	0.109"		0.064"		0.079"	1/2"	7/8"	32 ksi								
		54"-66"	10 1/2"	0.109"		0.064"		DOUBLE 0.079"	1/2"	7/8"	32 ksi								
		THROUGH 54"	10 1/2"	0.064"-0.079"		0.064"		0.079"	1/2"	7/8"	32 ksi								
		THROUGH 60"	10 1/2"	0.138"		0.079"		DOUBLE 0.079"	1/2"	7/8"	32 ksi								
		66"-72"	10 1/2"	0.138"		0.109"		DOUBLE 0.079"	1/2"	7/8"	32 ksi								
	THROUGH 72"	10 1/2"	0.168"		0.109"		DOUBLE 0.109"	1/2"	7/8"	45 ksi									
	3" x 1" REROLLED END	48"-84"	10 1/2"	0.109"		0.079"		DOUBLE 0.079"	1/2"	7/8"	32 ksi								
		48"-90"	10 1/2"	0.064"-0.079"		0.064"		DOUBLE 0.079"	1/2"	7/8"	32 ksi								
		96"-102"	10 1/2"	0.079"		0.079"		DOUBLE 0.079"	1/2"	7/8"	32 ksi								
90"-120"		10 1/2"	0.109"		0.109"		DOUBLE 0.109"	1/2"	7/8"	45 ksi									

To accompany plans dated 10-22-12

NOTES:

- All ferrous metal coupling band connection hardware shall be galvanized or electroplated in accordance with the Standard Specifications.
- For helically corrugated coupling bands, the connection angles may be oriented parallel to the pipe axis, provided connecting holes are slotted lengthwise sufficiently to allow adjustment for the helix angle.
- Tension strap may be connected to band with either spot welds or fillet welds that develop minimum required strength of strap.
- Use 1/4" gage line dimension on attached angle leg for rivets and spot welds.
- Band thickness shall not be less than:
 - 3 standard thicknesses lighter than the thickness of the pipe for Corrugated Steel Pipe.
 - 2 standard thicknesses lighter than the thickness of the pipe and in no case lighter than 0.060" for Corrugated Aluminum Pipe.
- Dimensions, thicknesses and strengths shown are minimum.
- For pipe arches use same width band as for round pipe of equal periphery.
- Fillet welds of equivalent strength may be substituted for spot welds or rivets.
- Spot welds shall develop minimum required strength of strap.
- Pipe with rerolled ends having at least two 2 2/3" x 1/2" annular corrugations at each end with or without an upturned flange may be connected with any of the annular coupling bands shown for pipe of the same diameter and wall thickness and having 2 2/3" x 1/2" corrugations.
- In the case of H-12 huggerbands, two piece bands are required for diameters through 96" and three piece bands are required for diameters 102" through 120".
- Two piece bands are required for pipes greater than 42" diameter.

SPIRAL RIB PROFILE

COUPLING TYPE	PIPE CORRUGATION	PIPE SIZE	W	PIPE WALL THICKNESS		BAND THICKNESS		BAR AND STRAP (SSRP ONLY)				ANGLE						
				SSRP	ASRP	SSRP	ASRP	STRAP THICKNESS	BOLTS Dia	BAR Dia	BAR YIELD STRENGTH	DIMENSIONS		BOLTS (No.- Dia)		RIVETS ANGLE TO BAND		SPOT WELDS ANGLE TO BAND
												SSRP	ASRP	SSRP	ASRP	SSRP	ASRP	SSRP
ANNULAR	2 2/3" x 1/2" * REROLLED END	24"-36"	12"	0.064"-0.109"	0.060"-0.105"	0.064"	0.060"	0.079"	1/2"	7/8"	32 ksi	2" x 2" x 3/16"	2" x 2" x 3/16"	3-1/2"	3-1/2"	3-3/8"	3-3/8"	5-1/2"
		42"-60"	12"	0.064"-0.079"	0.075"-0.105"	0.064"	0.075"	0.079"	1/2"	7/8"	32 ksi	2" x 2" x 3/16"	2" x 2" x 3/16"	3-1/2"	3-1/2"	3-3/8"	3-3/8"	5-1/2"
		42"-60"	12"	0.109"		0.064"		0.079"	1/2"	7/8"	32 ksi	2" x 2" x 1/4"		3-1/2"		5-3/8"		
		66"-84"	24"	0.109"		0.064"		0.079"	1/2"	7/8"	32 ksi	2" x 2" x 1/4"		5-1/2"		7-3/8"		
HUGGER	2 2/3" x 1/2" * REROLLED END	24"-54"	10 1/2"	0.064"-0.079"		0.064"		0.079"	1/2"	7/8"	32 ksi							
		24"-48"	10 1/2"	0.109"		0.064"		0.079"	1/2"	7/8"	32 ksi							
		54"-66"	10 1/2"	0.109"		0.064"		Double 0.079"	1/2"	7/8"	32 ksi							

* See Note 13.

13. All profiles of Spiral Rib Pipe (3/4" x 3/4" ribs at 7 1/2" pitch and 3/4" x 1" ribs at 11 1/2" pitch in both steel and aluminum and 3/4" x 1" ribs at 8 1/2" pitch in steel only) shall be manufactured with rerolled ends. Corrugation profile of the rerolled ends shall be 2 2/3" x 1/2" annual corrugations with a minimum of two full corrugations at each end.

CORRUGATED METAL PIPE COUPLING DETAILS No. 6 POSITIVE JOINT

NO SCALE

RSP D97F DATED JUNE 6, 2008 SUPERSEDES STANDARD PLAN D97F DATED MAY 1, 2006 - PAGE 188 OF THE STANDARD PLANS BOOK DATED MAY 2006.

REVISED STANDARD PLAN RSP D97F

2006 REVISED STANDARD PLAN RSP D97F

DIST	COUNTY	ROUTE	POST MILES TOTAL PROJECT	SHEET NO.	TOTAL SHEETS
07	LA	5,10,14, 47,60,etc	Var	59	72

Gregory A. Balzer
 LICENSED LANDSCAPE ARCHITECT
 June 5, 2009
 PLANS APPROVAL DATE
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To accompany plans dated 10-22-12

2006 REVISED STANDARD PLAN RSP H1

A

AB aggregate base
 ABS acrylonitrile-butadiene-styrene
 AC asphalt concrete
 Adj adjacent/adjustable
 AIC auxiliary irrigation controller
 Alt alternative
 AMEND amendment
 ARV air release valve
 AUTO automatic
 AUX auxiliary
 AVB atmospheric vacuum breaker

B

B&B balled and burlapped
 B/B brass/bronze
 B/B/PL brass/bronze/plastic
 B/PL brass/plastic
 BFM bonded fiber matrix
 Bit Ctd bituminous coated
 BP booster pump
 BPA backflow preventer assembly
 BPAE backflow preventer assembly in enclosure
 BPE backflow preventer enclosure
 BV ball valve

C

CAP corrugated aluminum pipe
 CARV combination air release valve
 CCA cam coupler assembly
 CEC controller enclosure cabinet
 CHDPE corrugated high density polyethylene
 CL chain link
 CNC control and neutral conductors
 Conc concrete
 Cond conduit
 CSP corrugated steel pipe
 CST center strip
 CV check valve

D

Dia diameter
 DIP ductile iron pipe
 DN diameter nominal

E

EA each
 Elect electric/electrical
 Elev elevation
 ENCL enclosure
 EP edge of pavement
 ES edge of shoulder
 EST end strip
 ESTB establishment
 ETW edge of traveled way

F

F full circle
 F/P full/part circle
 FAU filter assembly unit
 FCV flow control valve
 FERT fertilizer
 FG finished grade
 FIPT female iron pipe thread
 FIS fertilizer injector system
 FL flow line
 FM flow monitor
 FS flow sensor
 Ft foot/feet
 FV flush valve

G

GAL Gallon(s)
 Galv galvanized
 GARV garden valve
 GPH gallons per hour
 GPM gallons per minute
 GSP galvanized steel pipe
 GV gate valve

H

H half circle
 HB hose bib
 HDPE high density polyethylene
 HP horsepower/hinge point
 HPL high pressure line
 Hwy highway

I

IC irrigation controller
 ICC irrigation controller(s) in controller enclosure cabinet
 ID inside diameter
 In inches
 IFS irrigation filtration system
 IPS iron pipe size
 IPT iron pipe thread
 Irr irrigation

L

L length
 LF linear foot

M

Max maximum
 MBGR metal beam guard railing
 MCV manual control valve
 MIC master irrigation controller
 Min minimum
 MIPT male iron pipe thread
 Misc miscellaneous
 Mtl material
 MVP maintenance vehicle pullout

N

NCN no common name
 NL nozzle line
 No. number
 NPT national pipe thread

O

O/C on center
 OD outside diameter
 Oz ounce

P

P part circle
 PB pull box
 PCC portland cement concrete
 PE polyethylene
 Pkt packet
 PL plastic
 PLT plant/planting
 PLT ESTB plant establishment
 PM post mile
 PR pressure rated
 PRLV pressure relief valve
 PSFM polymer stabilized fiber matrix
 PSI pounds per square inch
 PRV pressure reducing valve
 PVC polyvinyl chloride
 Pvmnt pavement

Q

Q quarter circle
 QCV quick coupling valve

R

R radius
 RCP reinforced concrete pipe
 RCV remote control valve
 RCVM remote control valve (master)
 RCVMF remote control valve (master) w/ flow meter
 RCW recycled/reclaimed water
 RECP rolled erosion control product
 REQ required
 R/W right of way

S

S slip
 SCC sprinkler control conduit
 SCH schedule
 SF state-furnished
 Shld shoulder
 SQFT square foot/feet
 SQYD square yard(s)
 SST side strip
 Sta station
 Std standard
 SW sidewalk/sound wall

T

T third circle/thread
 TLS truck loading standpipe
 TQ three quarter circle
 TRM turf reinforcement mat
 TRVD traveled
 TT two third circle
 Typ typical

U

UG underground

V

VAU valve assembly unit

W

W width
 W/ with
 WM water meter
 WS wye strainer
 WSP welded steel pipe
 WWM welded wire mesh

NOTE:
 FOR ADDITIONAL ABBREVIATIONS,
 SEE STANDARD PLANS A10A AND A10B.

PLANTING AND IRRIGATION ABBREVIATIONS

NO SCALE

RSP H1 DATED JUNE 5, 2009 SUPERSEDES STANDARD PLAN H1
 DATED MAY 1, 2006 - PAGE 201 OF THE STANDARD PLANS BOOK DATED MAY 2006.

REVISED STANDARD PLAN RSP H1

DIST	COUNTY	ROUTE	POST MILES TOTAL PROJECT	SHEET NO.	TOTAL SHEETS
07	LA	5,10,14, 47,60,etc	Var	60	72



Gregory A. Balzer
 LICENSED LANDSCAPE ARCHITECT
 June 5, 2009
 PLANS APPROVAL DATE
The State of California or its officers or agents shall not be responsible for the accuracy or completeness of electronic copies of this plan sheet.

To accompany plans dated 10-22-12

EXISTING	PROPOSED	ITEM DESCRIPTION
		WATER METER (WM)
		BACKFLOW PREVENTER ASSEMBLY (BPA)
		BACKFLOW PREVENTER ASSEMBLY IN ENCLOSURE (BPAE)
		BACKFLOW PREVENTER ENCLOSURE (BPE)
		BOOSTER PUMP (BP)
		TRUCK LOADING STANDPIPE (TLS)
		FLOW SENSOR (FS)
		MASTER IRRIGATION CONTROLLER (MIC)
		AUXILIARY IRRIGATION CONTROLLER (AIC)
		IRRIGATION CONTROLLER (IC)/ IRRIGATION CONTROLLER (IC) (BATTERY) IRRIGATION CONTROLLER (IC) (SOLAR)
		IRRIGATION CONTROLLER(S) IN CONTROLLER ENCLOSURE CABINET (ICC)
		CONTROL AND NEUTRAL CONDUCTORS (CNC)
		SPRINKLER CONTROL CONDUIT (SCC)
		IRRIGATION CROSSOVER
		EXTEND IRRIGATION CROSSOVER
		IRRIGATION SLEEVE
		DUCTILE IRON PIPE (SUPPLY LINE) (MAIN) (DIP)
		GALVANIZED STEEL PIPE (SUPPLY LINE) (MAIN) (GSP)
		GALVANIZED STEEL PIPE (SUPPLY LINE) (LATERAL) (GSP)
		PLASTIC PIPE (PR 200) (SUPPLY LINE) (MAIN)
		PLASTIC PIPE (PR 200) (SUPPLY LINE) (LATERAL)
		PLASTIC PIPE (IRRIGATION LINE)
		REMOTE CONTROL VALVE (RCV) REMOTE CONTROL VALVE (MASTER) (RCVM) REMOTE CONTROL VALVE (MASTER) W/FLOW METER (RCVMF)
		MANUAL CONTROL VALVE (MCV)
		VALVE ASSEMBLY UNIT (VAU)
		WYE STRAINER (WS)
		FILTER ASSEMBLY UNIT (FAU)
		GATE VALVE (GV)
		BALL VALVE (BV)

EXISTING	PROPOSED	ITEM DESCRIPTION
		QUICK COUPLING VALVE (QCV)
		CAM COUPLER ASSEMBLY (CCA)
		PRESSURE REDUCING VALVE (PRV)
		PRESSURE RELIEF VALVE (PRLV)
		FLOW CONTROL VALVE (FCV)
		COMBINATION AIR RELEASE VALVE (CARV)
		CHECK VALVE (CV)
		FLUSH VALVE (FV)
		NOZZLE LINE W/TURNING UNION
		IRRIGATION SYSTEM
		IRRIGATION SYSTEM TO BE REMOVED
		CHAIN LINK GATE
		QUICK COUPLING VALVE W/SPRINKLER PROTECTOR
		SPRINKLER W/SPRINKLER PROTECTOR
		CONNECT TO EXISTING SYSTEM
		CAP
		CAP EXISTING

VALVE CODE

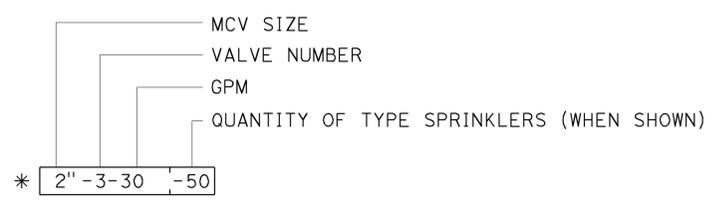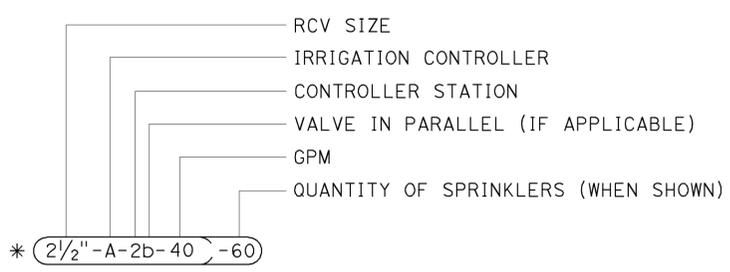

* VALVE CODES FOR EXISTING VALVES ARE SHOWN IN A DASHED ENCLOSURE.

STATE OF CALIFORNIA
DEPARTMENT OF TRANSPORTATION
PLANTING AND IRRIGATION SYMBOLS
NO SCALE


RSP H2 DATED JUNE 5, 2009 SUPERSEDES RSP H2 DATED MARCH 7, 2008 AND STANDARD PLAN H2 DATED MAY 1, 2006 - PAGE 202 OF THE STANDARD PLANS BOOK DATED MAY 2006.

REVISED STANDARD PLAN RSP H2


2006 REVISED STANDARD PLAN RSP H2

DIST	COUNTY	ROUTE	POST MILES TOTAL PROJECT	SHEET NO.	TOTAL SHEETS
07	LA	5,10,14, 47,60,etc	Var	61	72


Gregory A. Balzer
 LICENSED LANDSCAPE ARCHITECT
 June 5, 2009
 PLANS APPROVAL DATE
The State of California or its officers or agents shall not be responsible for the accuracy or completeness of electronic copies of this plan sheet.

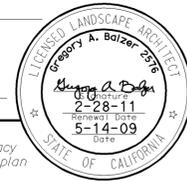


To accompany plans dated 10-22-12

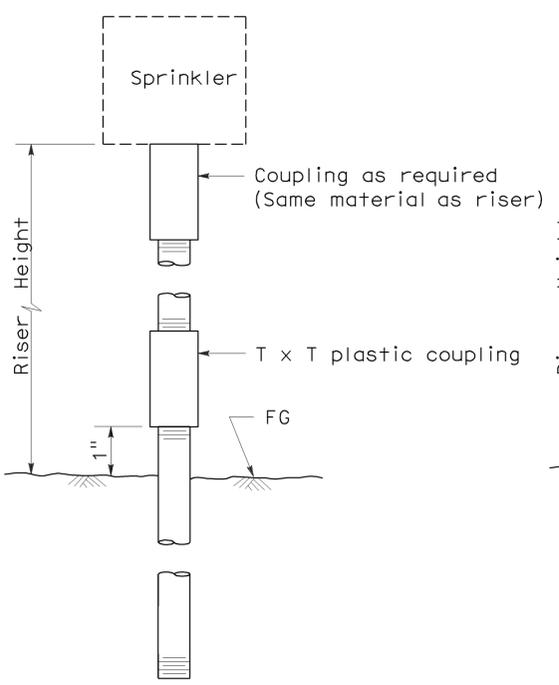


ELEVATION
RISER TYPE I

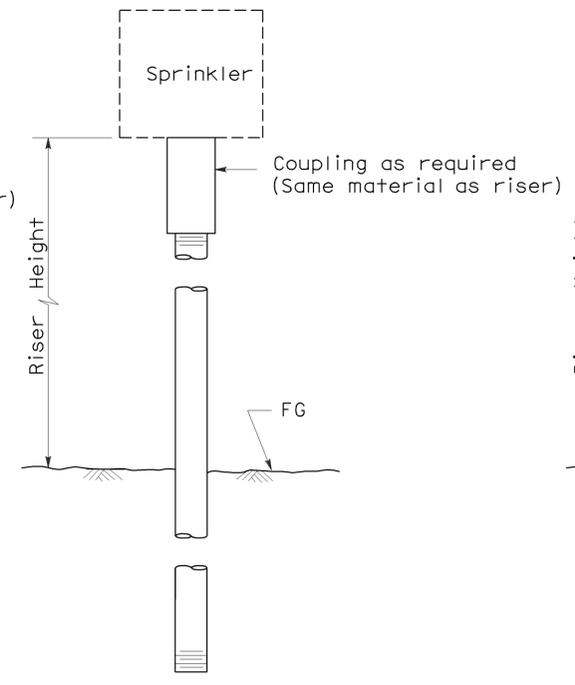


ELEVATION
RISER TYPE II

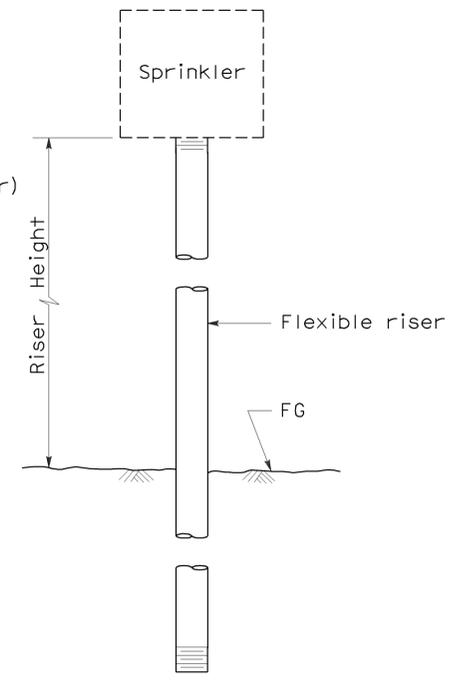


ELEVATION
RISER TYPE III

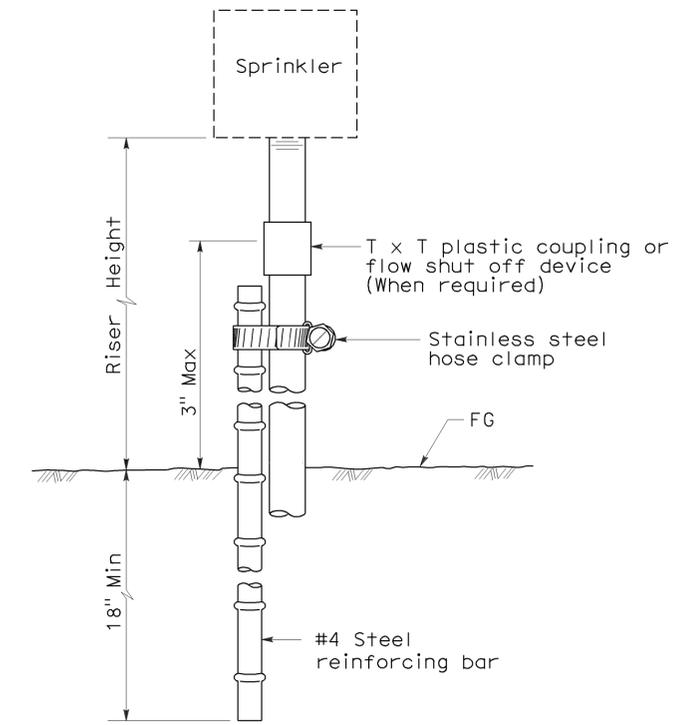

ELEVATION
RISER TYPE IV

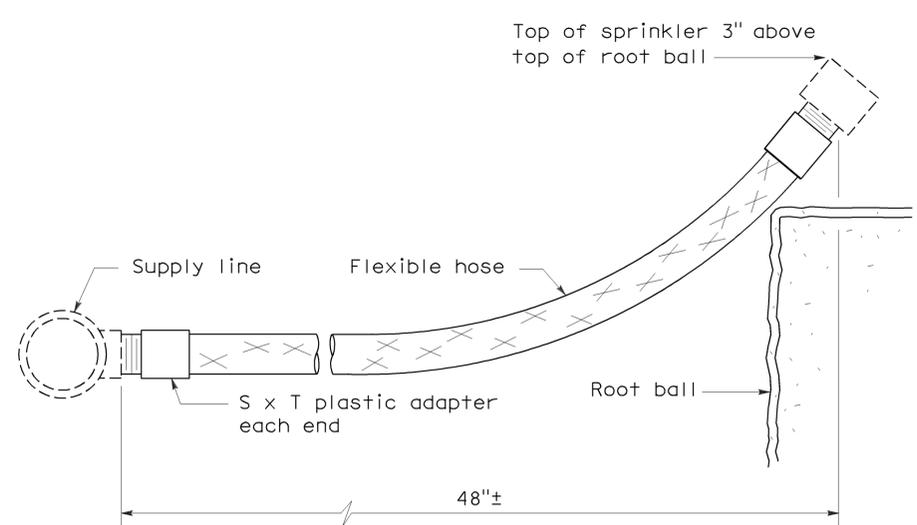

ELEVATION
RISER TYPE V

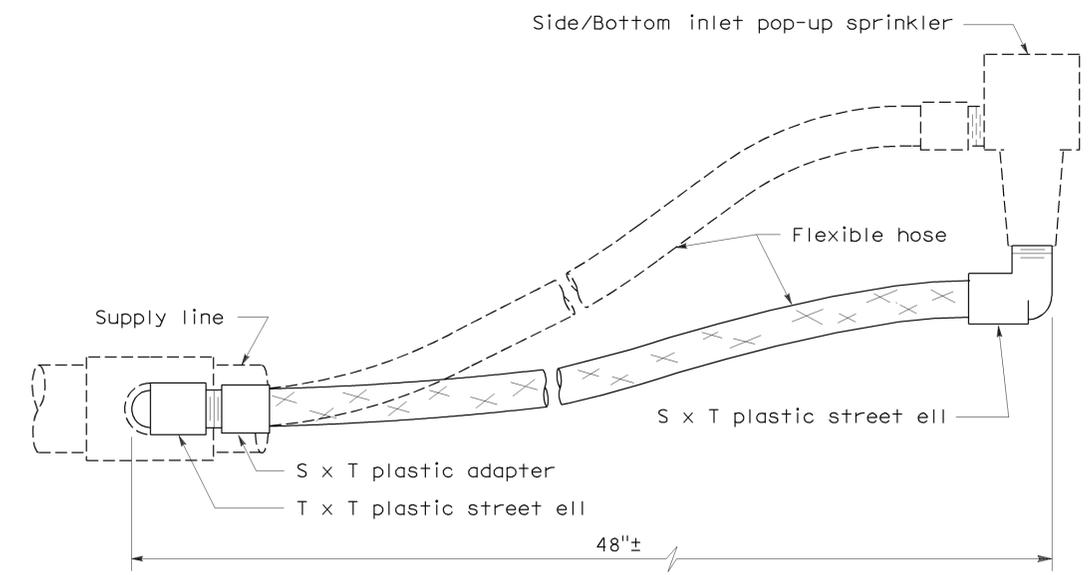

ELEVATION
RISER TYPE VI

STATE OF CALIFORNIA
DEPARTMENT OF TRANSPORTATION
**PLANTING AND IRRIGATION
DETAILS**
NO SCALE



RSP H5 DATED JUNE 5, 2009 SUPERSEDES STANDARD PLAN H5
DATED MAY 1, 2006 - PAGE 205 OF THE STANDARD PLANS BOOK DATED MAY 2006.

REVISED STANDARD PLAN RSP H5


2006 REVISED STANDARD PLAN RSP H5

DIST	COUNTY	ROUTE	POST MILES TOTAL PROJECT	SHEET NO.	TOTAL SHEETS
07	LA	5,10,14, 47,60,etc	Var	62	72


Gregory A. Balzer
 LICENSED LANDSCAPE ARCHITECT
 June 5, 2009
 PLANS APPROVAL DATE
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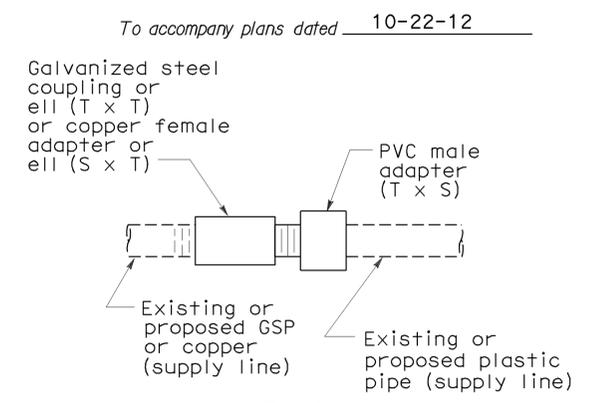
**ELEVATION
WYE STRAINER**

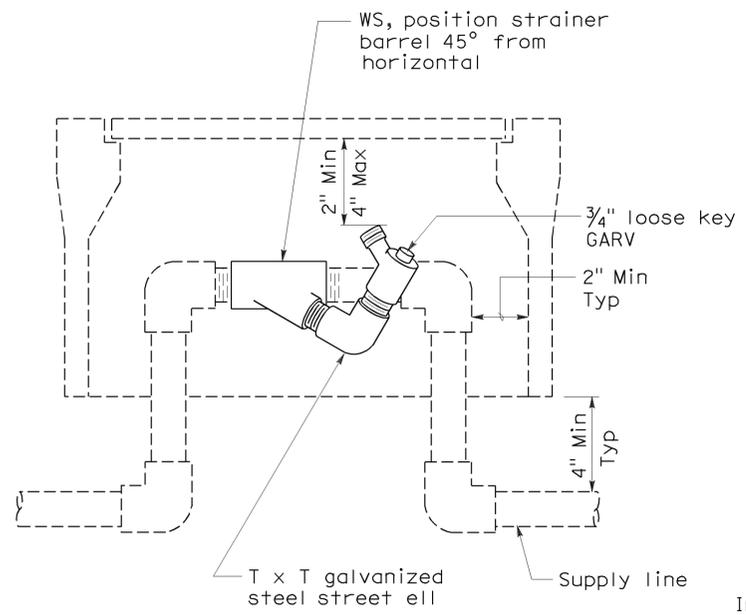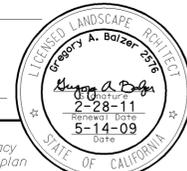


**ELEVATION
VALVE**

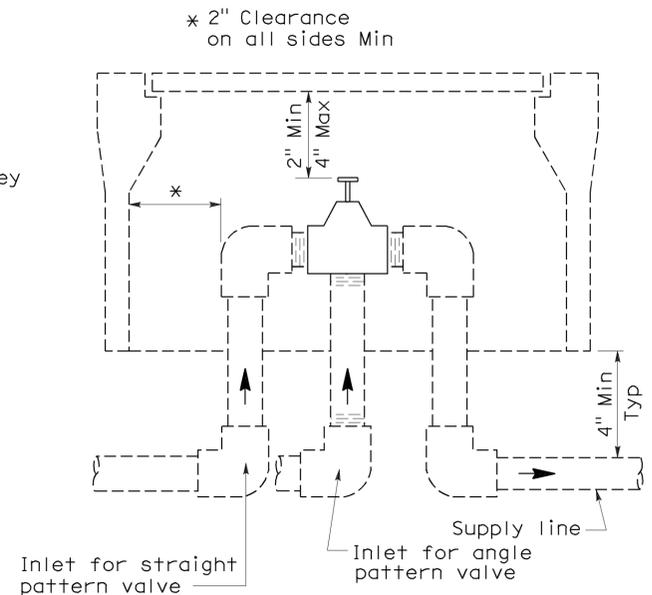


**SECTION
VALVE BOX**

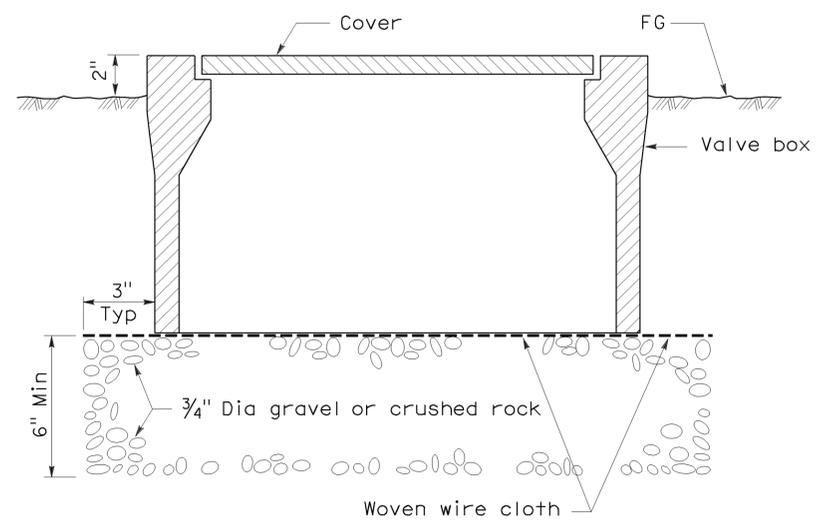


**PLAN
GALVANIZED OR COPPER PIPE
CONNECTION TO PLASTIC PIPE**

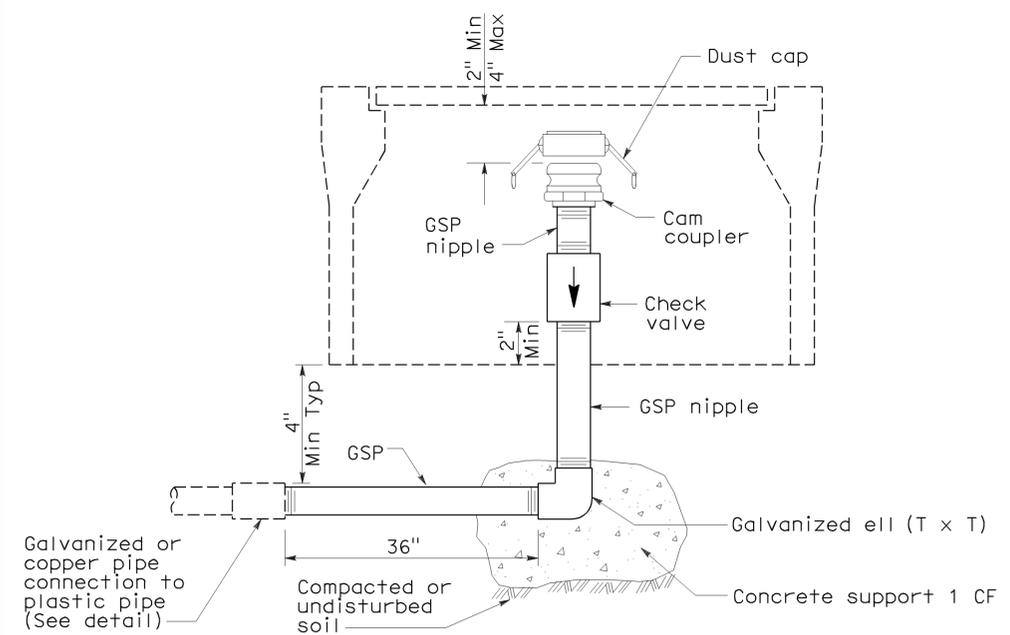


**ELEVATION
CAM COUPLER ASSEMBLY**

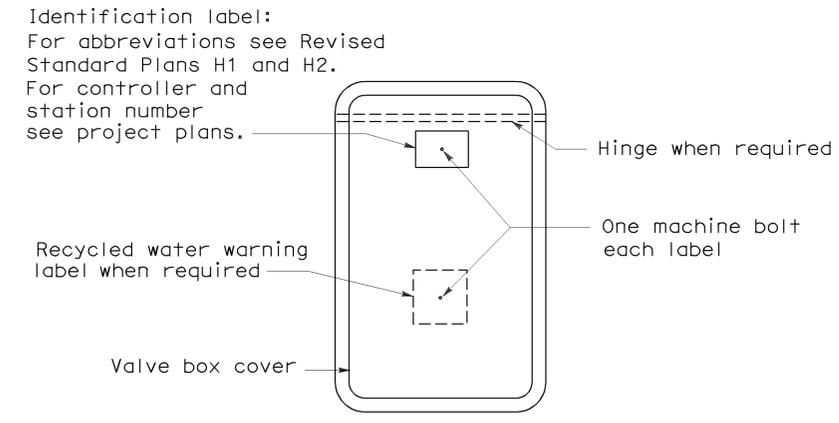

PLAN

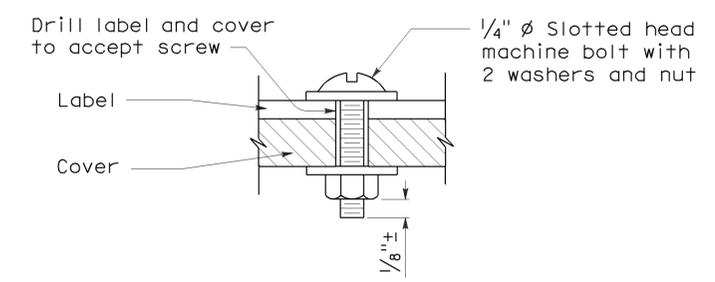

**SECTION
VALVE BOX IDENTIFICATION**

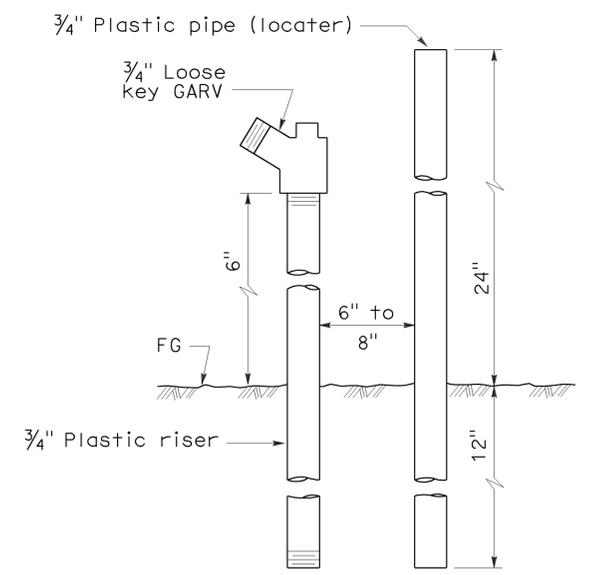

**ELEVATION
FLUSH VALVE**

STATE OF CALIFORNIA
DEPARTMENT OF TRANSPORTATION

**PLANTING AND IRRIGATION
DETAILS**

NO SCALE

RSP H7 DATED JUNE 5, 2009 SUPERSEDES STANDARD PLAN H7
DATED MAY 1, 2006 - PAGE 207 OF THE STANDARD PLANS BOOK DATED MAY 2006.

REVISED STANDARD PLAN RSP H7

2006 REVISED STANDARD PLAN RSP H7


DIST	COUNTY	ROUTE	POST MILES TOTAL PROJECT	SHEET NO.	TOTAL SHEETS
07	LA	5,10,14, 47,60,etc	Var	63	72

Randell D. Hiatt
REGISTERED CIVIL ENGINEER

June 6, 2008
PLANS APPROVAL DATE


Randell D. Hiatt
No. C50200
Exp. 6-30-09
CIVIL
STATE OF CALIFORNIA

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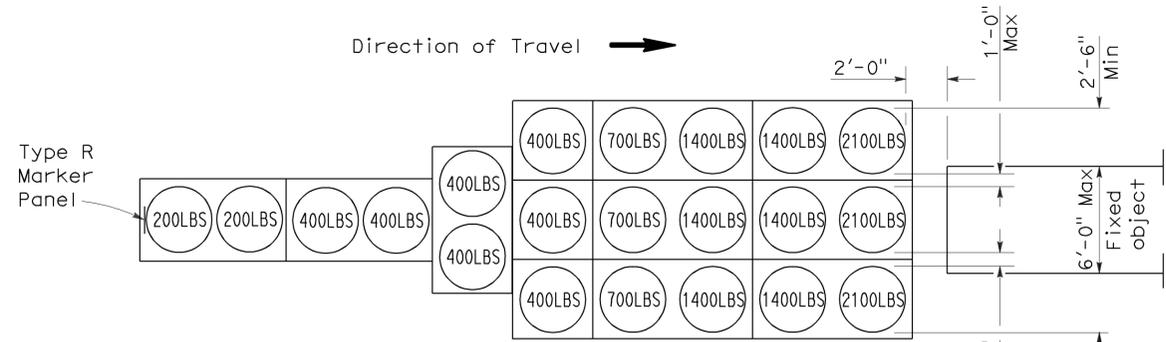
ARRAY 'TU14'

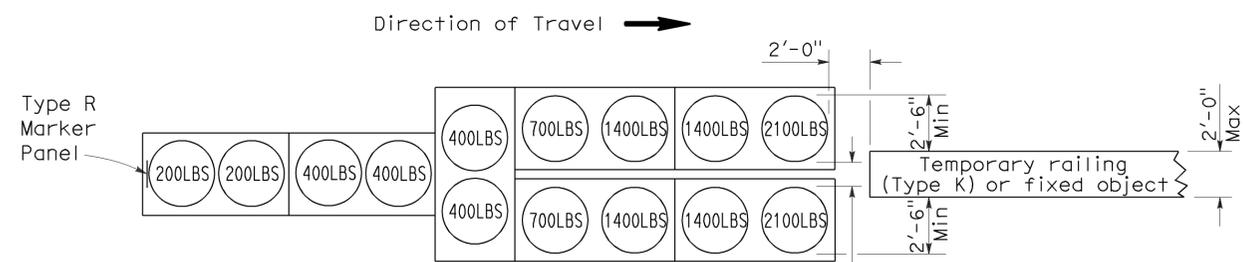Approach speed 45 mph or more




ARRAY 'TU11'

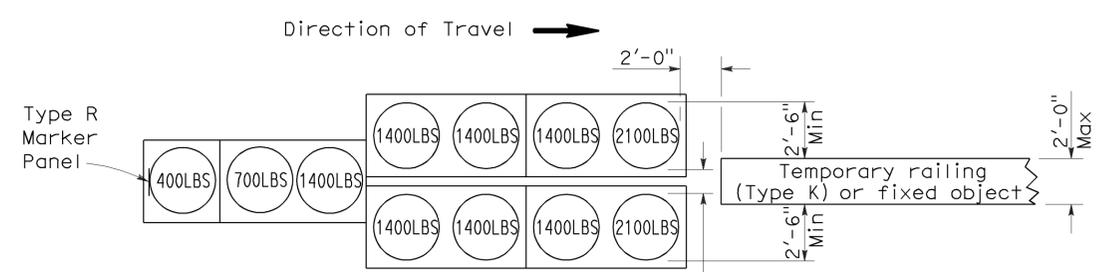Approach speed less than 45 mph




ARRAY 'TU21'

Approach speed 45 mph or more

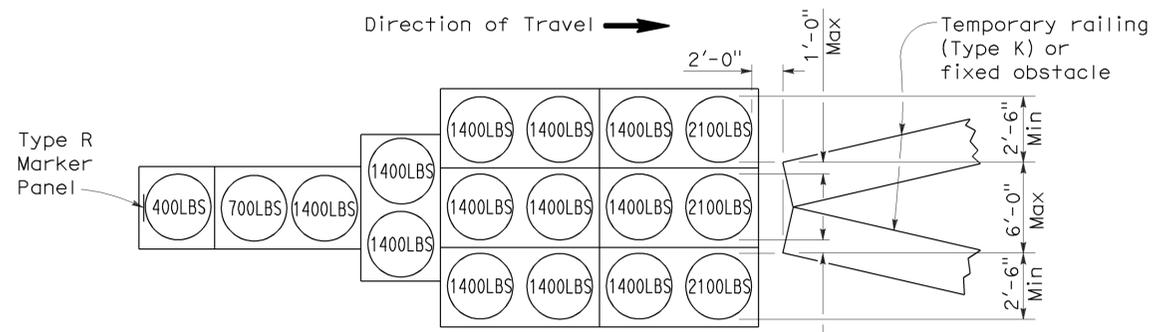


ARRAY 'TU17'

Approach speed less than 45 mph

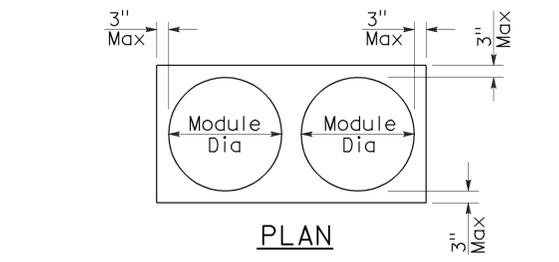

PLAN

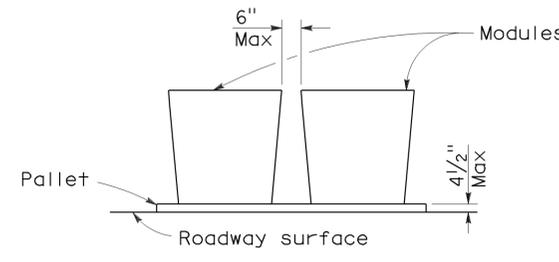

ELEVATION

CRASH CUSHION PALLET DETAIL

See Note 7

NOTES:

1. (XXX) Indicates sand filled module location and weight of sand in pounds for each module. Module spacing is based on the greater diameter of the module.
2. All sand weights are nominal.
3. Temporary crash cushion arrays shall not encroach on the traveled way.
4. Place the top of Type R marker panel 1" below the module lid.
5. Refer to Standard Plan A73B for marker details.
6. Approach speeds indicated conform to NCHRP 350 Report criteria.
7. Use of pallets is optional.

STATE OF CALIFORNIA
DEPARTMENT OF TRANSPORTATION

**TEMPORARY CRASH CUSHION,
SAND FILLED
(UNIDIRECTIONAL)**

NO SCALE

RSP T1A DATED JUNE 6, 2008 SUPERSEDES STANDARD PLAN T1A
DATED MAY 1, 2006 - PAGE 211 OF THE STANDARD PLANS BOOK DATED MAY 2006.

REVISED STANDARD PLAN RSP T1A

2006 REVISED STANDARD PLAN RSP T1A

DIST	COUNTY	ROUTE	POST MILES TOTAL PROJECT	SHEET NO.	TOTAL SHEETS
07	LA	5,10,14, 47,60,etc	Var	64	72


Randell D. Hiatt
REGISTERED CIVIL ENGINEER

June 6, 2008
PLANS APPROVAL DATE

Randell D. Hiatt
No. C50200
Exp. 6-30-09
CIVIL
STATE OF CALIFORNIA


The State of California or its officers or agents shall not be responsible for the accuracy or completeness of electronic copies of this plan sheet.

To accompany plans dated 10-22-12

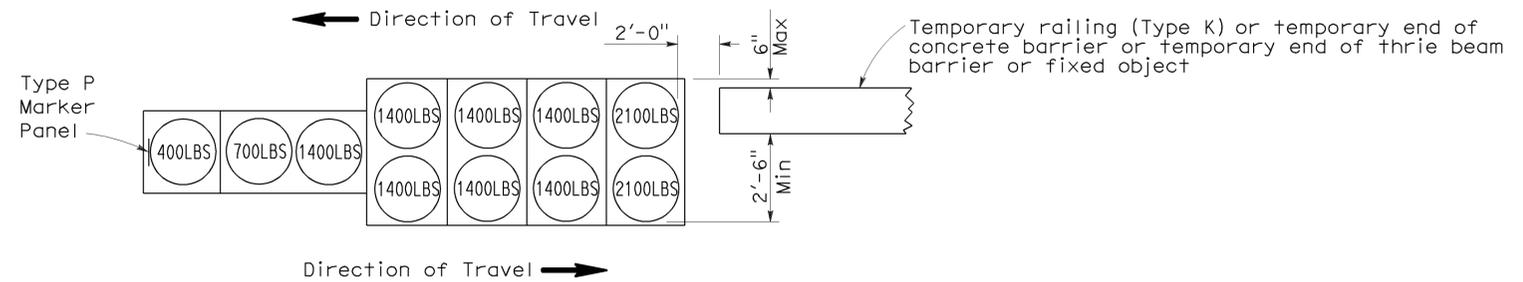


ARRAY 'TB11'

Approach speed less than 45 mph

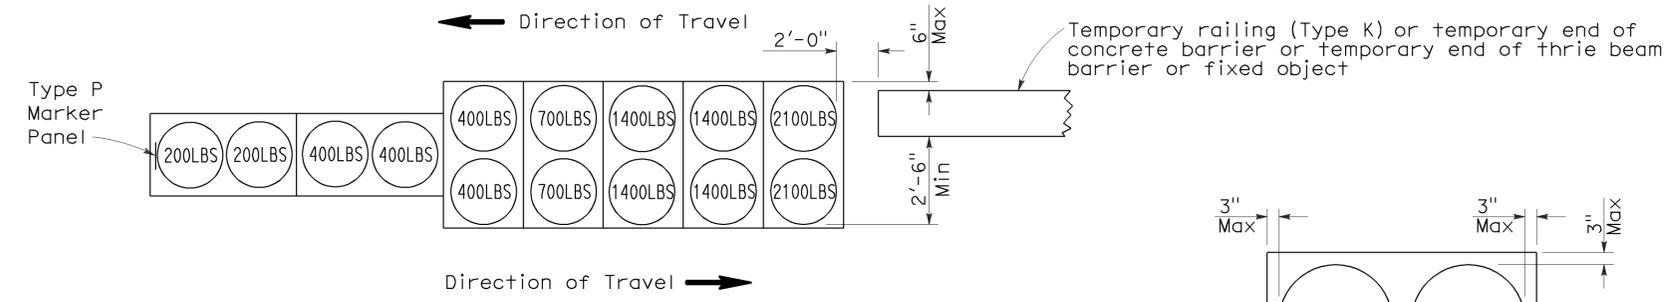


ARRAY 'TB14'

Approach speed 45 mph or more

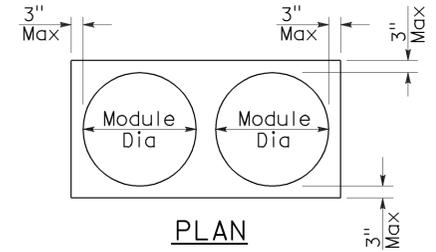

PLAN

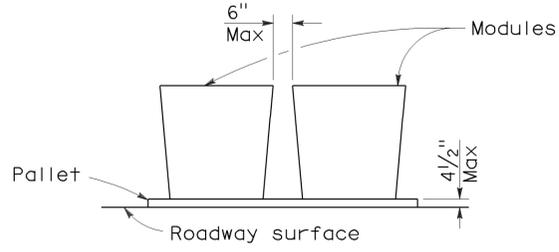

ELEVATION

CRASH CUSHION PALLET DETAIL

See Note 7

NOTES:

1. (XXX) Indicates sand filled module location and weight of sand in pounds for each module. Module spacing is based on the greater diameter of the module.
2. All sand weights are nominal.
3. Temporary crash cushion arrays shall not encroach on the traveled way.
4. Place the Type P marker panel so that the bottom of the panel rests upon the pallet.
5. Refer to Standard Plan A73B for marker details.
6. Approach speeds indicated conform to NCHRP 350 Report criteria.
7. Use of pallets is optional.

STATE OF CALIFORNIA
DEPARTMENT OF TRANSPORTATION

**TEMPORARY CRASH CUSHION,
SAND FILLED
(BIDIRECTIONAL)**

NO SCALE

RSP T1B DATED JUNE 6, 2008 SUPERSEDES STANDARD PLAN T1B
DATED MAY 1, 2006 - PAGE 212 OF THE STANDARD PLANS BOOK DATED MAY 2006.

REVISED STANDARD PLAN RSP T1B


2006 REVISED STANDARD PLAN RSP T1B

DIST	COUNTY	ROUTE	POST MILES TOTAL PROJECT	SHEET NO.	TOTAL SHEETS
07	LA	5,10,14, 47,60,etc	Var	65	72


Randell D. Hiatt
REGISTERED CIVIL ENGINEER

June 6, 2008
PLANS APPROVAL DATE


The State of California or its officers or agents shall not be responsible for the accuracy or completeness of electronic copies of this plan sheet.

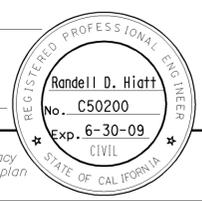



To accompany plans dated 10-22-12

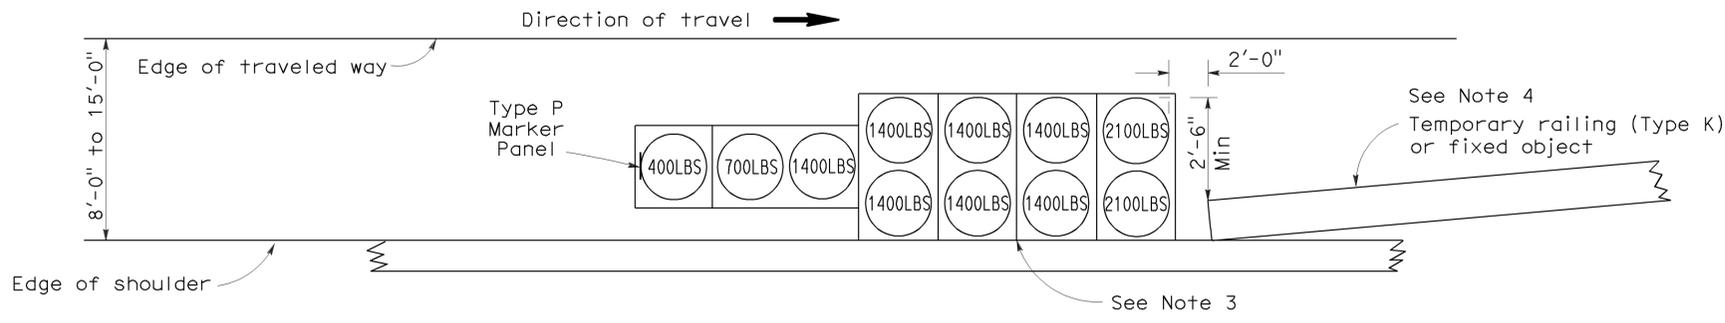

ARRAY 'TS11'
Approach speed less than 45 mph
See Note 9

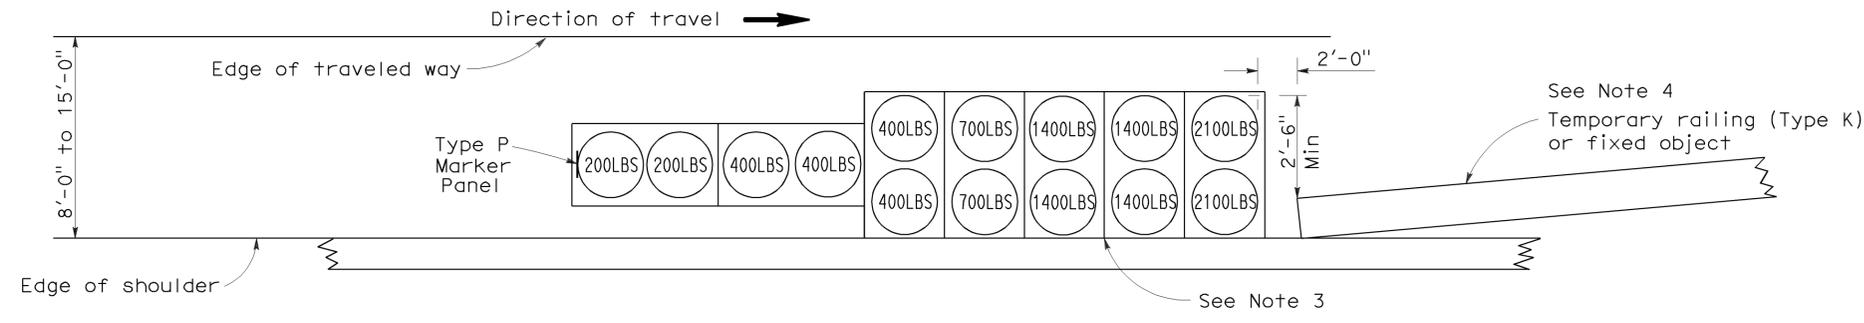

ARRAY 'TS14'
Approach speed 45 mph or more
See Note 9

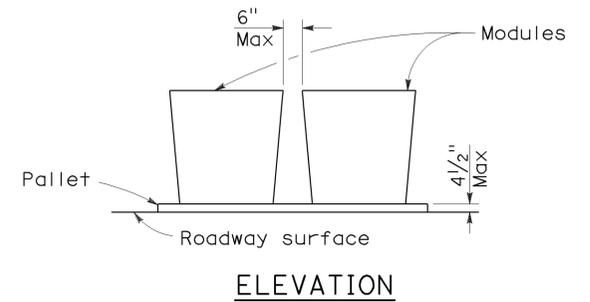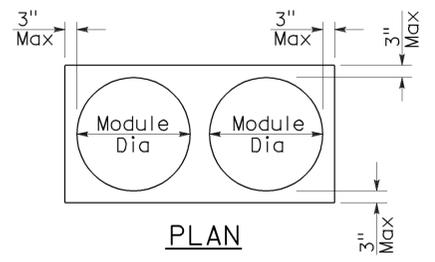

CRASH CUSHION PALLET DETAIL
See Note 11

NOTES:

- (XXX) Indicates sand filled module location and weight of sand in pounds for each module. Module spacing is based on the greater diameter of the module.
- All sand weights are nominal.
- The temporary crash cushion arrays shown on this plan shall be used only in locations where there will be traffic on one side of the temporary crash cushion array.
- If the fixed object or approach end of the temporary railing is less than 15'-0" from the edge of traveled way, a temporary crash cushion is required in a construction or work zone.
- Temporary crash cushion arrays shall not encroach on the traveled way.
- Arrays for median shoulders shall conform to details shown on this plan for outside shoulders.
- Place the Type P marker panel so that the bottom of the panel rests upon the pallet and faces traffic.
- Refer to Standard Plan A73B for marker details.
- For shoulder widths less than 8'-0", appropriate approved crash cushion protection, other than sand filled modules, shall be provided at fixed objects and at approach ends of temporary railing. The specific type of crash cushion shall be as shown on the project plans or as specified in the Special Provisions, or if not shown on the project plans or specified in the Special Provisions, shall be as approved by the Engineer.
- Approach speeds indicated conform to NCHRP 350 Report criteria.
- Use of pallets is optional.

STATE OF CALIFORNIA
DEPARTMENT OF TRANSPORTATION
**TEMPORARY CRASH CUSHION,
SAND FILLED
(SHOULDER INSTALLATIONS)**

NO SCALE
RSP T2 DATED JUNE 6, 2008 SUPERSEDES STANDARD PLAN T2
DATED MAY 1, 2006 - PAGE 213 OF THE STANDARD PLANS BOOK DATED MAY 2006.

REVISED STANDARD PLAN RSP T2

2006 REVISED STANDARD PLAN RSP T2

Dist	COUNTY	ROUTE	POST MILES TOTAL PROJECT	SHEET No.	TOTAL SHEETS
07	LA	5,10,14, 47,60,etc	Var	66	72


Randell D. Hiatt
REGISTERED CIVIL ENGINEER

May 20, 2011
PLANS APPROVAL DATE


The State of California or its officers or agents shall not be responsible for the accuracy or completeness of electronic copies of this plan sheet.

REGISTERED PROFESSIONAL ENGINEER
No. C50200
Exp. 6-30-11
CIVIL
STATE OF CALIFORNIA

To accompany plans dated 10-22-12

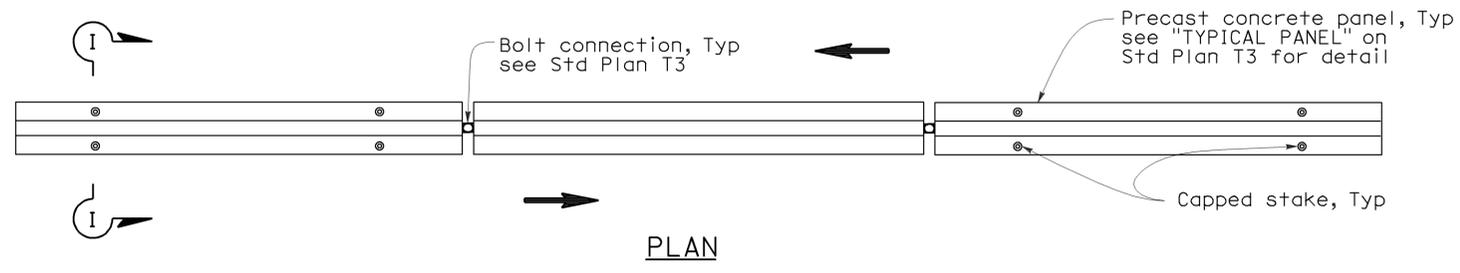


RAILING STAKING CONFIGURATION FOR TWO-WAY TRAFFIC
See Note 1

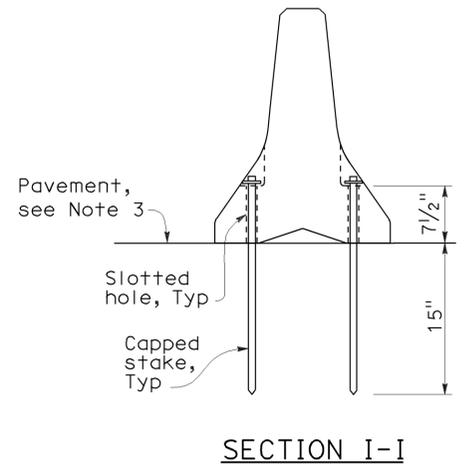


NOTES:

1. Where Type K Temporary Railing is placed as a temporary or long term barrier in two-way traffic on highways with less than 24" from the edge of traveled way, use four capped stakes per every other panel with end panels staked.
2. Where Type K Temporary Railing is placed 3" to 24" from the edge of an excavation on highways, use two capped stakes per panel along the traffic side.
3. Staked Type K Temporary Railing must be supported by at least 4" thick concrete, hot mix asphalt or existing asphalt concrete pavement.
4. The minimum yield strength for the washer must be 60,000 psi.
5. Direction of adjacent traffic indicated by \Rightarrow .


SECTION I-I

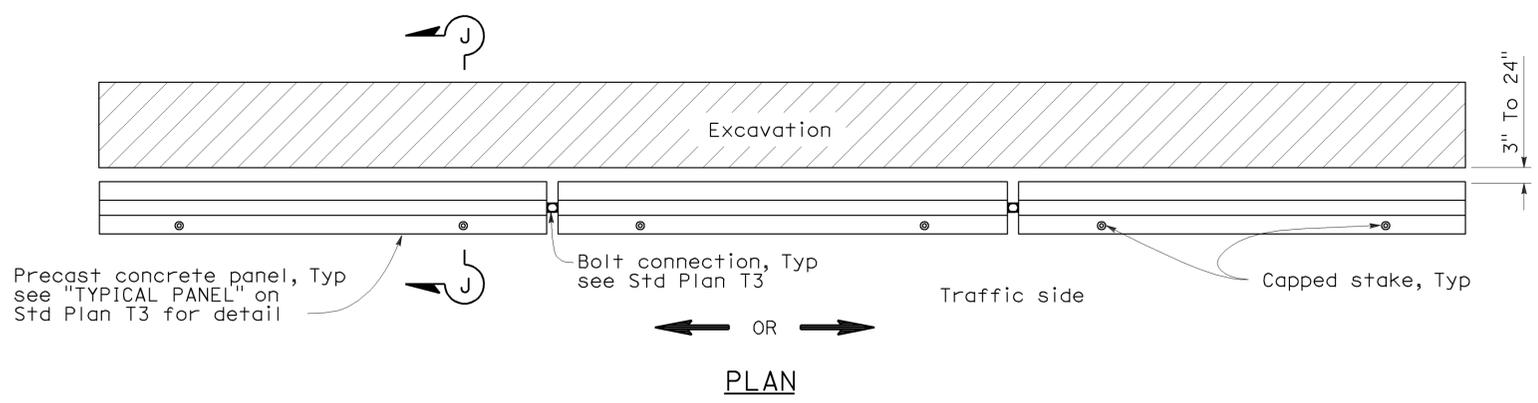

RAILING STAKING CONFIGURATION ADJACENT TO AN EXCAVATION
See Note 2

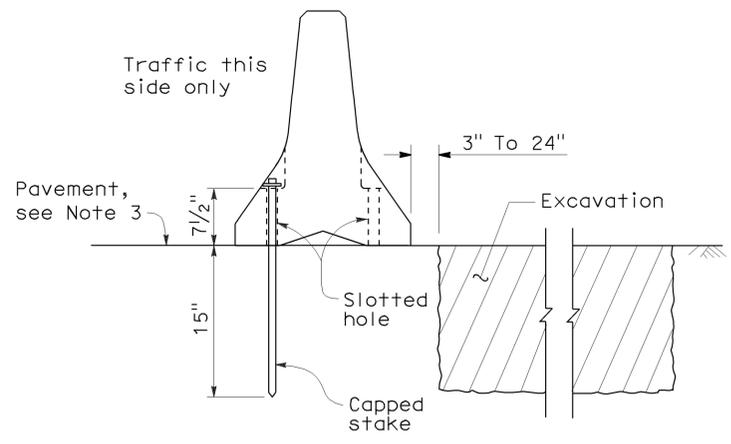

SECTION J-J

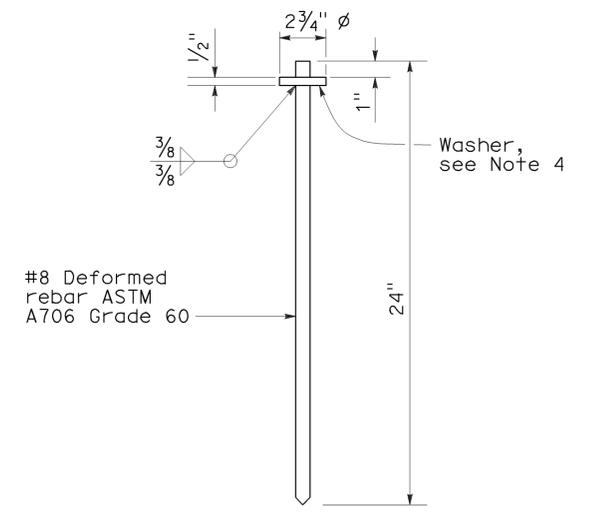

CAPPED STAKE DETAIL


STATE OF CALIFORNIA
DEPARTMENT OF TRANSPORTATION
**TEMPORARY RAILING
(TYPE K)**
NO SCALE

NSP T3A DATED MAY 20, 2011 SUPPLEMENTS
THE STANDARD PLANS BOOK DATED MAY 2006.


2006 NEW STANDARD PLAN NSP T3A

DIST	COUNTY	ROUTE	POST MILES TOTAL PROJECT	SHEET NO.	TOTAL SHEETS
07	LA	5,10,14, 47,60,etc	Var	68	72


Robert B. Schott
 LICENSED LANDSCAPE ARCHITECT
 April 3, 2009
 PLANS APPROVAL DATE
The State of California or its officers or agents shall not be responsible for the accuracy or completeness of electronic copies of this plan sheet.

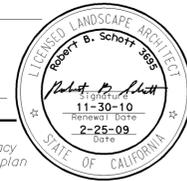


To accompany plans dated 10-22-12

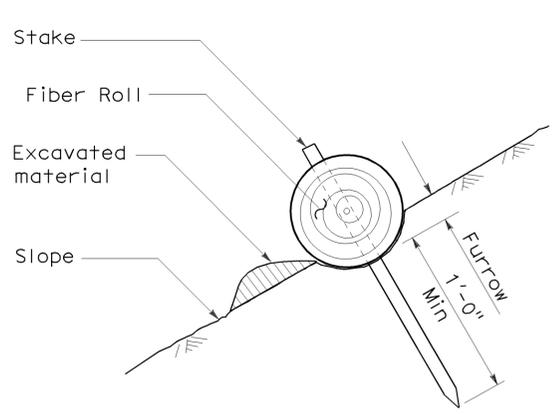


SECTION
TEMPORARY FIBER ROLL (TYPE 1)

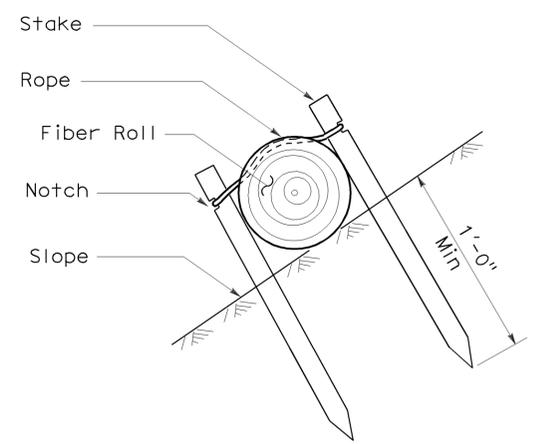

SECTION
TEMPORARY FIBER ROLL (TYPE 2)

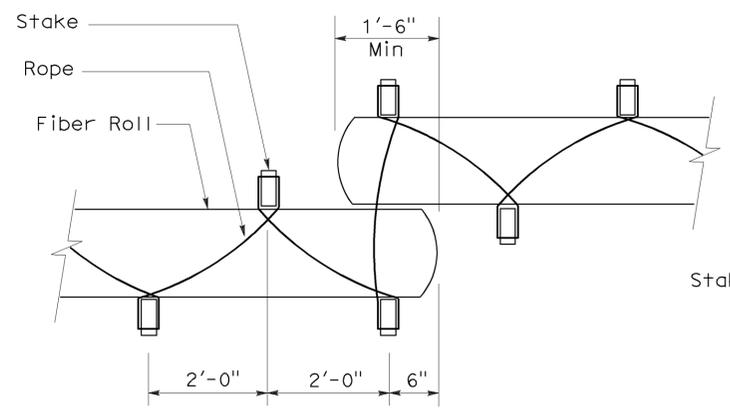


PLAN
TEMPORARY FIBER ROLL (TYPE 2)

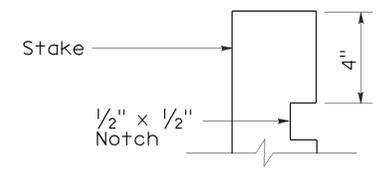


ELEVATION
STAKE NOTCH DETAIL

- NOTES:**
1. Temporary fiber roll spacing varies depending upon slope inclination.
 2. Installations shown in the perspectives are for slope inclination of 10:1 and steeper.

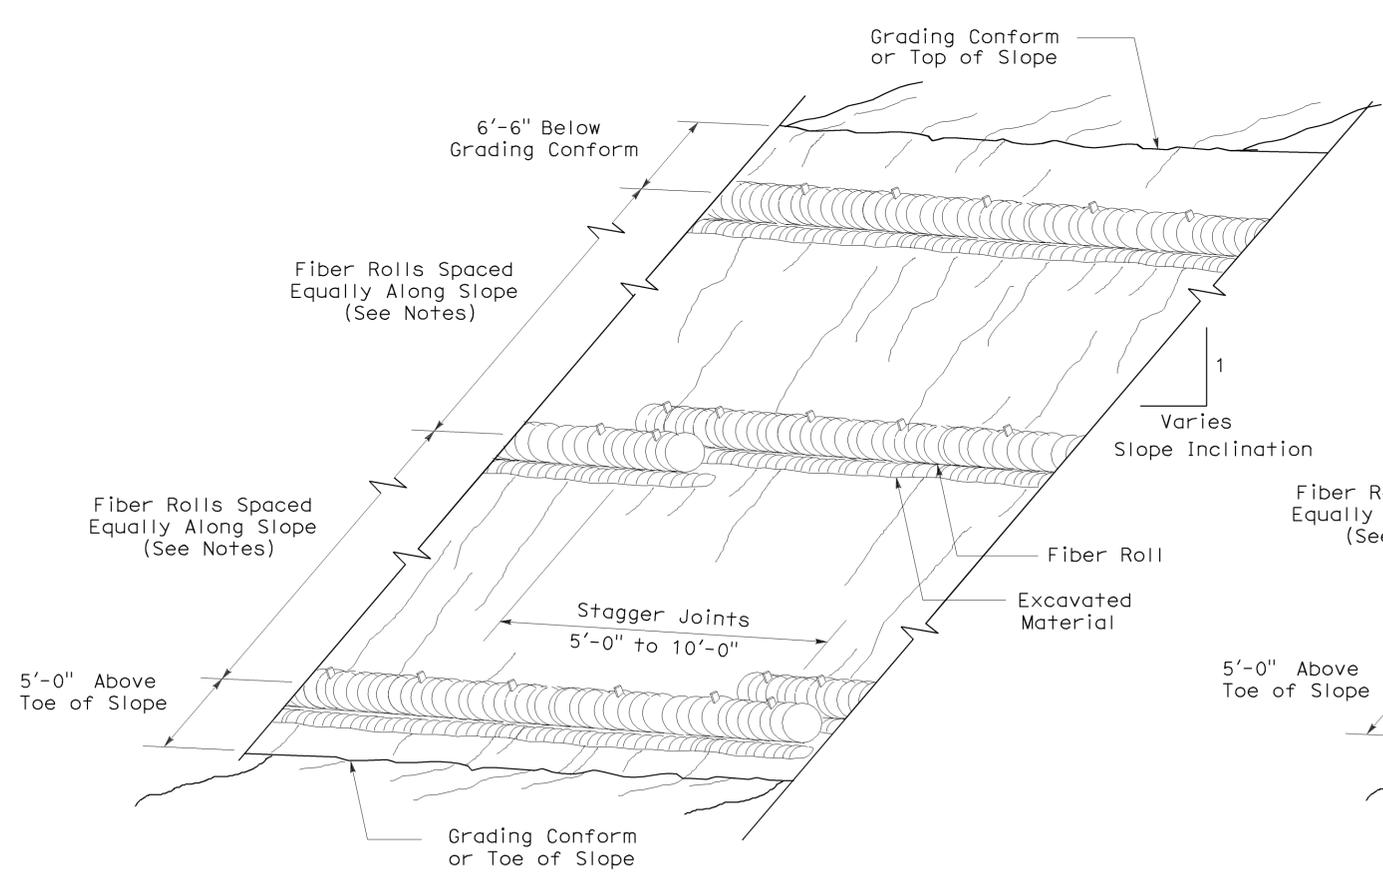

PERSPECTIVE
TEMPORARY FIBER ROLL (TYPE 1)

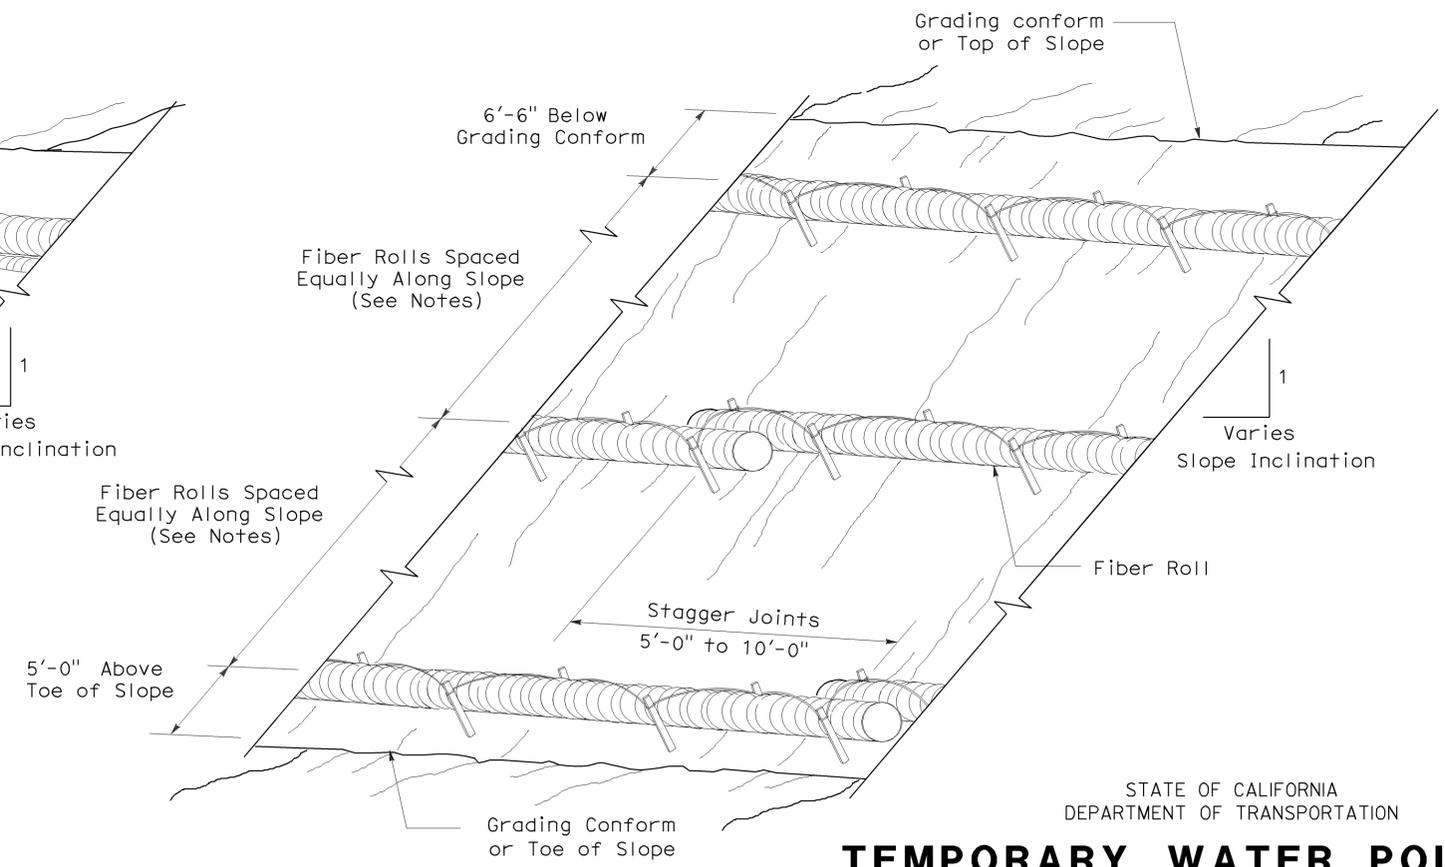

PERSPECTIVE
TEMPORARY FIBER ROLL (TYPE 2)

STATE OF CALIFORNIA
DEPARTMENT OF TRANSPORTATION
TEMPORARY WATER POLLUTION CONTROL DETAILS (TEMPORARY FIBER ROLL)
NO SCALE


2006 REVISED STANDARD PLAN RSP T56

DIST	COUNTY	ROUTE	POST MILES TOTAL PROJECT	SHEET NO.	TOTAL SHEETS
07	LA	5,10,14, 47,60,etc	Var	69	72


Robert B. Schott
 LICENSED LANDSCAPE ARCHITECT
 August 15, 2008
 PLANS Approval DATE
 The State of California or its officers or agents shall not be responsible for the accuracy or completeness of electronic copies of this plan sheet.



To accompany plans dated 10-22-12

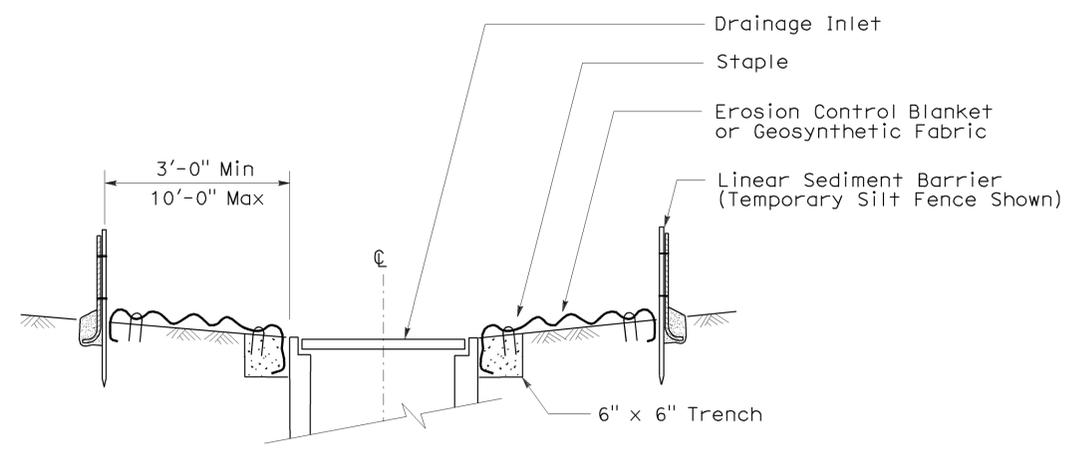


SECTION A-A

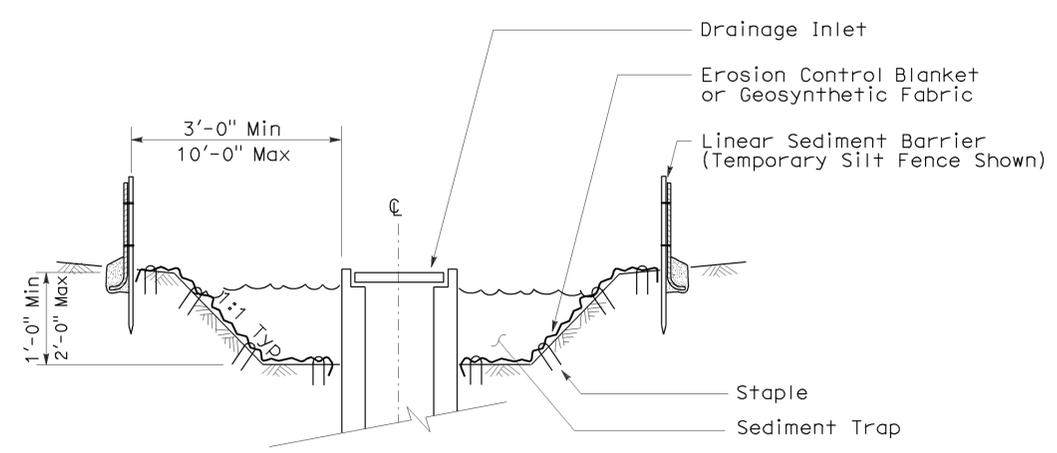


SECTION B-B

NOTES:


1. See Standard Plan T51 for Temporary Silt Fence.
2. Dimensions may vary to fit field conditions.

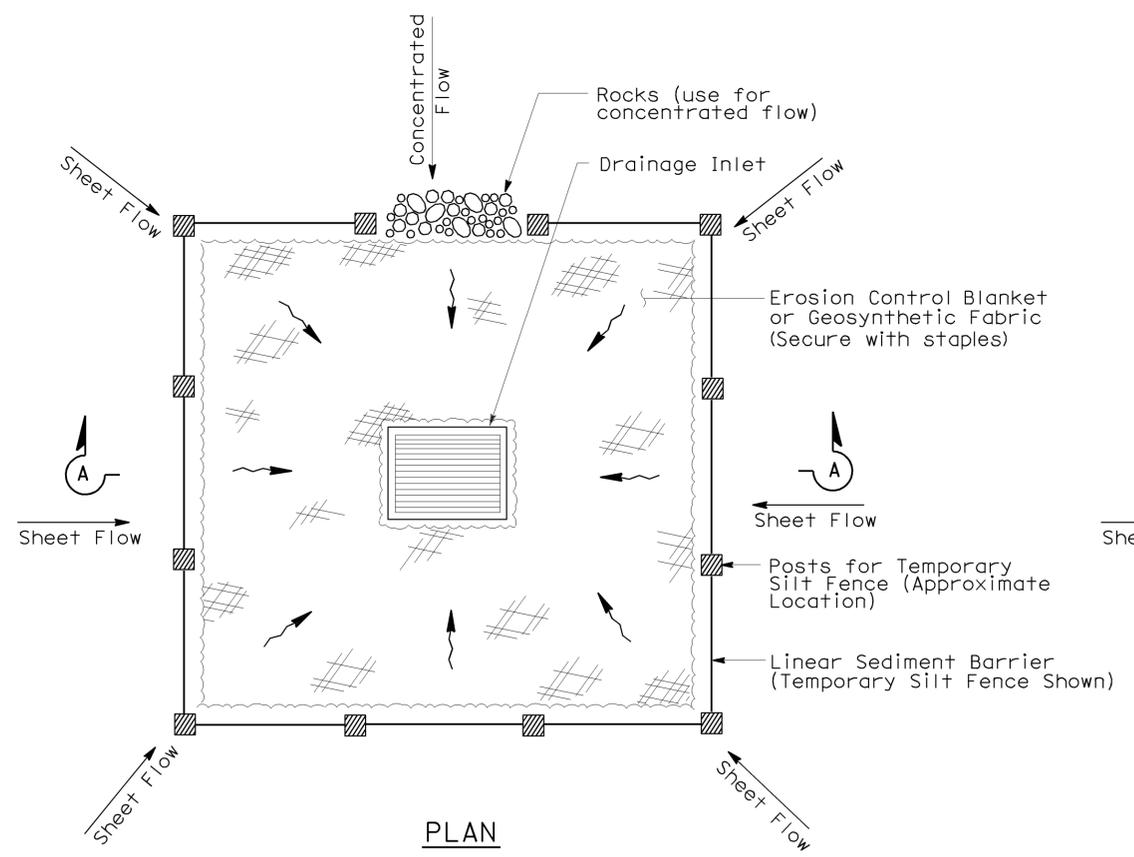

TEMPORARY DRAINAGE INLET PROTECTION (TYPE 1)

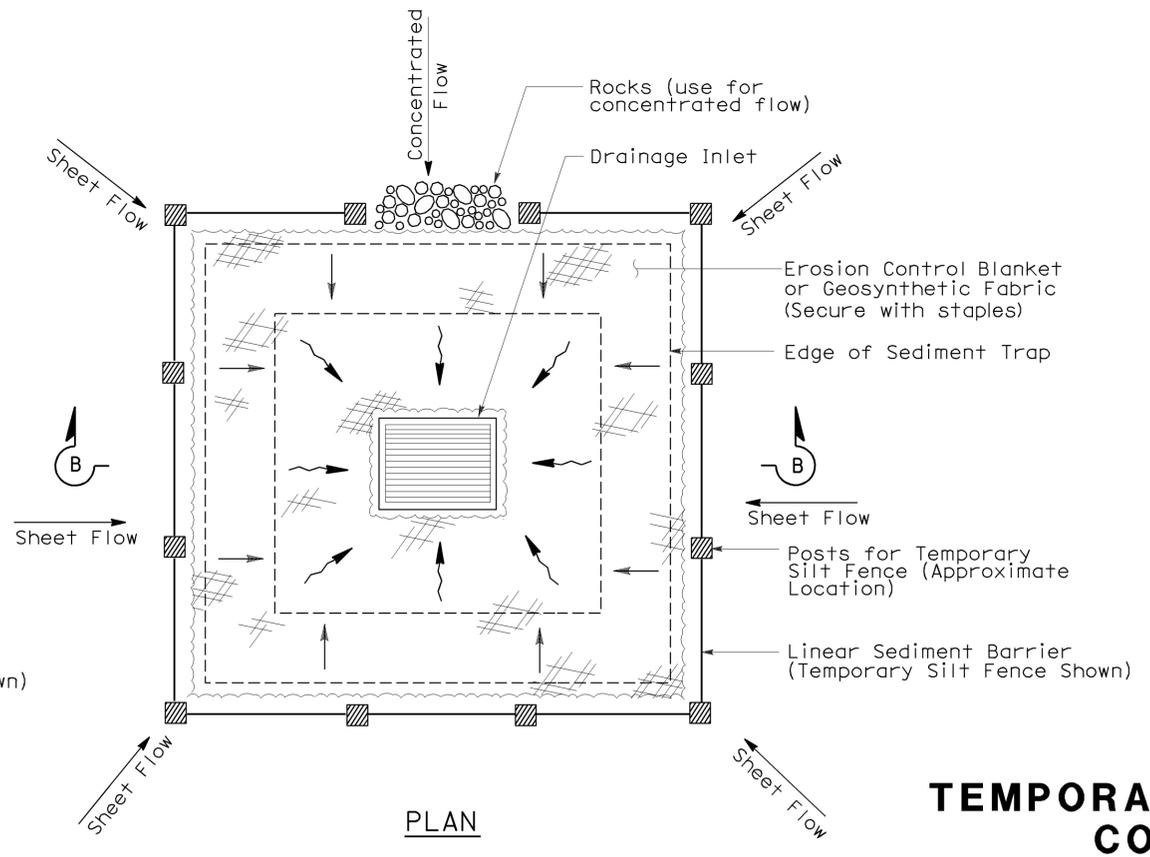

TEMPORARY DRAINAGE INLET PROTECTION (TYPE 2) (EXCAVATED SEDIMENT TRAP)

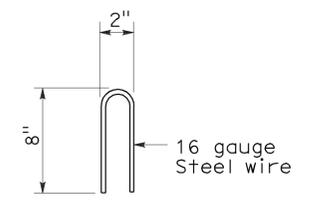

STAPLE DETAIL

STATE OF CALIFORNIA
DEPARTMENT OF TRANSPORTATION
TEMPORARY WATER POLLUTION CONTROL DETAILS (TEMPORARY DRAINAGE INLET PROTECTION)
NO SCALE

NSP T61 DATED AUGUST 15, 2008 SUPPLEMENTS THE STANDARD PLANS BOOK DATED MAY 2006.

2006 NEW STANDARD PLAN NSP T61

DIST	COUNTY	ROUTE	POST MILES TOTAL PROJECT	SHEET NO.	TOTAL SHEETS
07	LA	5,10,14, 47,60,etc	Var	70	72

Robert B. Schott
LICENSED LANDSCAPE ARCHITECT

August 15, 2008
PLANS APPROVAL DATE

The State of California or its officers or agents shall not be responsible for the accuracy or completeness of electronic copies of this plan sheet.


To accompany plans dated 10-22-12




GRAVEL BAG BERM (TYPE 3A) SPACING TABLE

SLOPE OF ROADWAY (PERCENT)	1 to 3.9	4 to 5.9	6 to 7.9	8 to 10	10+
INTERVAL BETWEEN BERM	100'	75'	50'	25'	12'

For slope of less than 1%, install barriers only if erosion/sediment is prevalent

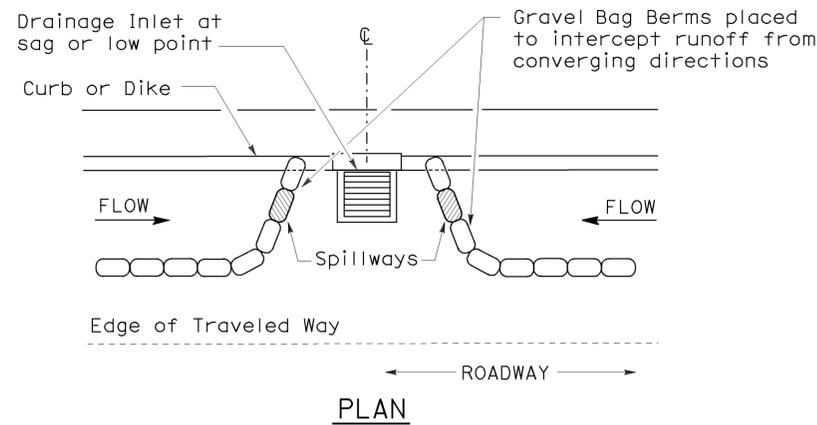


PLAN
CONFIGURATION FOR SAG POINT INLET (GRAVEL BAG BERM)

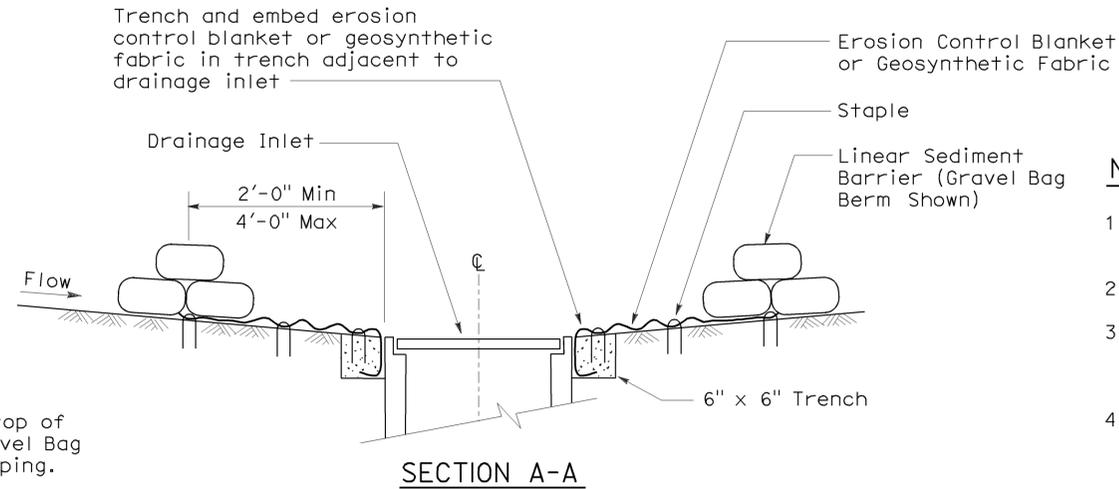


SECTION A-A

NOTES:


1. Place safety cones adjacent to drainage inlet protection.
2. Dimensions may vary to fit field conditions.
3. Install a minimum of 3 gravel bag berms upstream of each drainage inlet to be protected.
4. Position erosion control blanket or geosynthetic fabric at edge of concrete apron and secure in trench.
5. Erosion control blanket or geosynthetic fabric is not required if the area adjacent to the drainage inlet is vegetated or paved.

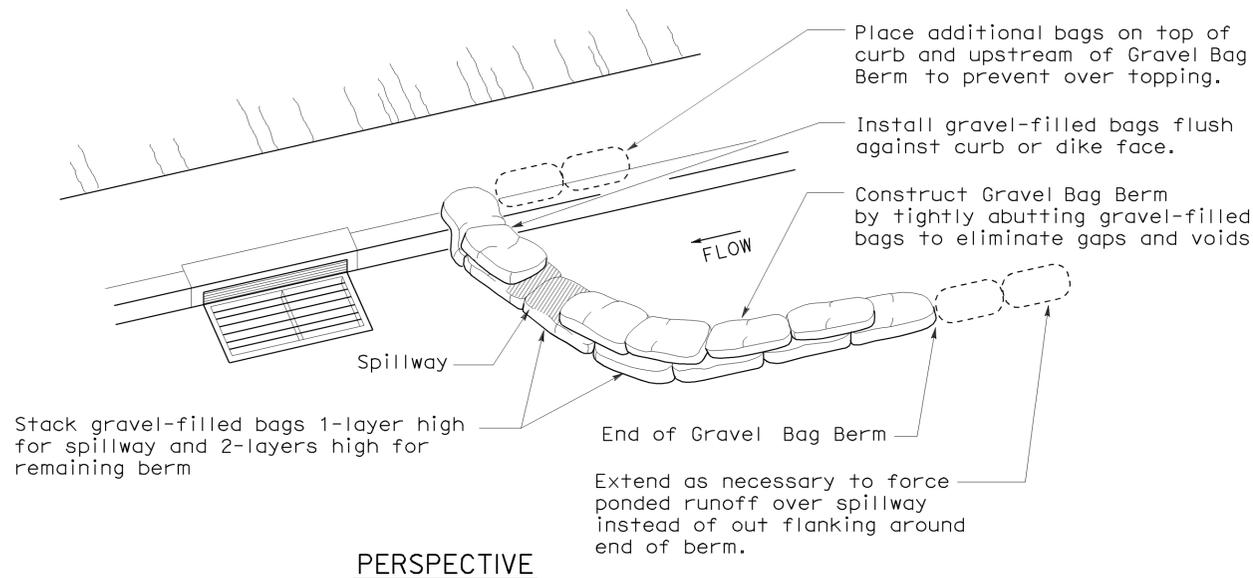


PERSPECTIVE

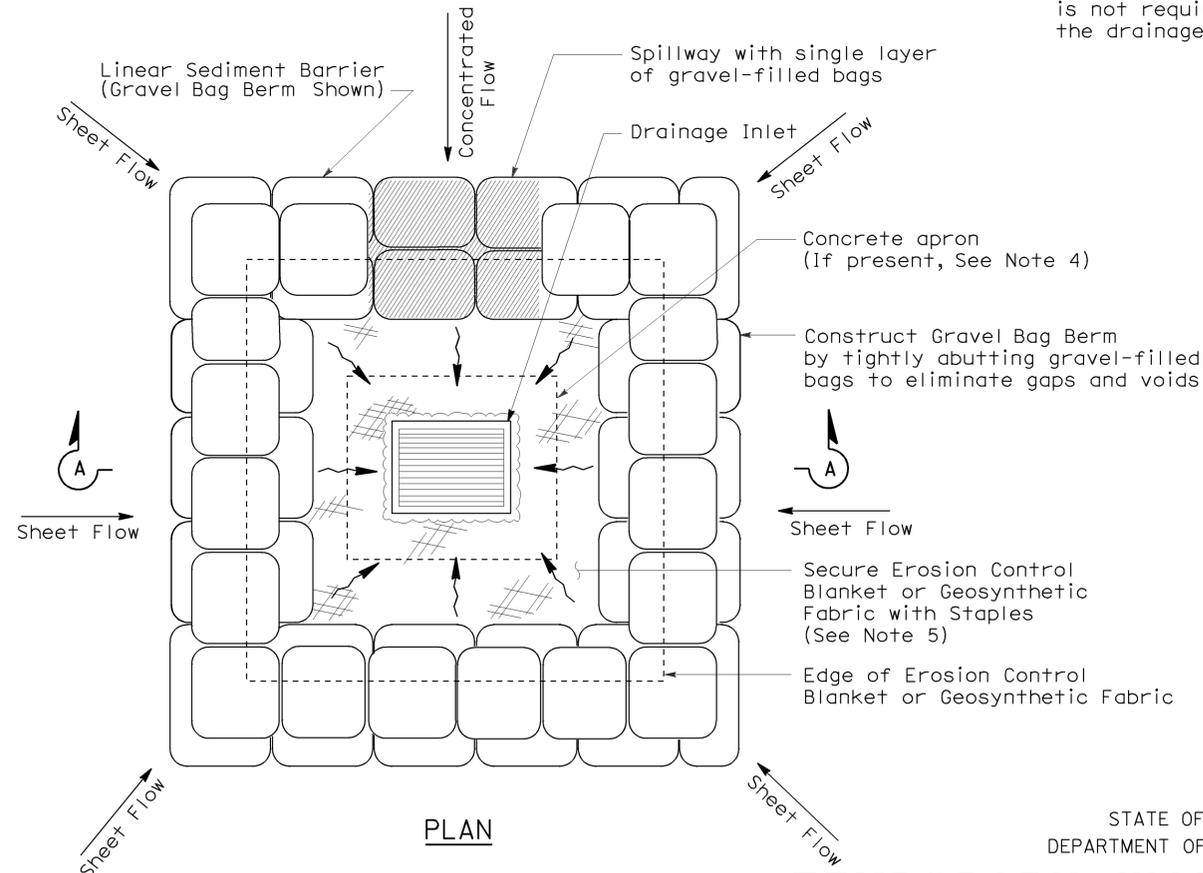

PLAN
TEMPORARY DRAINAGE INLET PROTECTION (TYPE 3B)

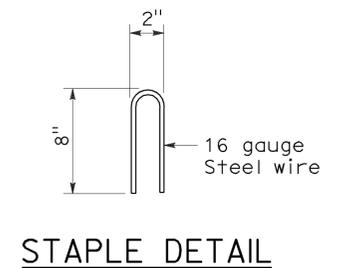

STAPLE DETAIL

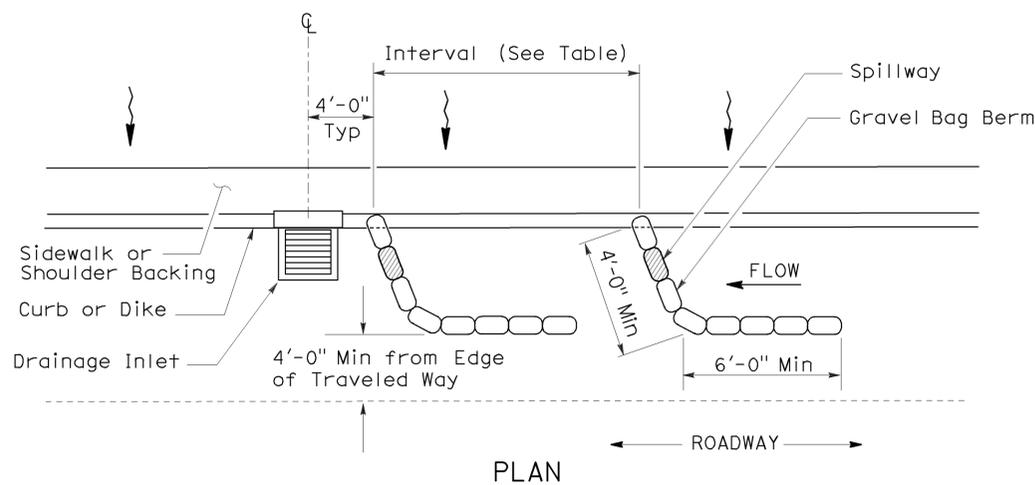


PLAN
TEMPORARY DRAINAGE INLET PROTECTION (TYPE 3A) (GRAVEL BAG BERM)

STATE OF CALIFORNIA
DEPARTMENT OF TRANSPORTATION
TEMPORARY WATER POLLUTION CONTROL DETAILS (TEMPORARY DRAINAGE INLET PROTECTION)


NO SCALE
NSP T62 DATED AUGUST 15, 2008 SUPPLEMENTS THE STANDARD PLANS BOOK DATED MAY 2006.

FLEXIBLE SEDIMENT BARRIER SPACING TABLE

SLOPE OF ROADWAY (PERCENT)	0 to 0.9	1 to 1.9	2 to 2.9	3 to 4	5+
INTERVAL BETWEEN BARRIERS	50'	35'	30'	25'	20'
ANGLE FROM FACE OF CURB	70°	70°	70°	45°	45°
SUGGESTED BARRIER LENGTH	6'	6'	6'	6'	6'

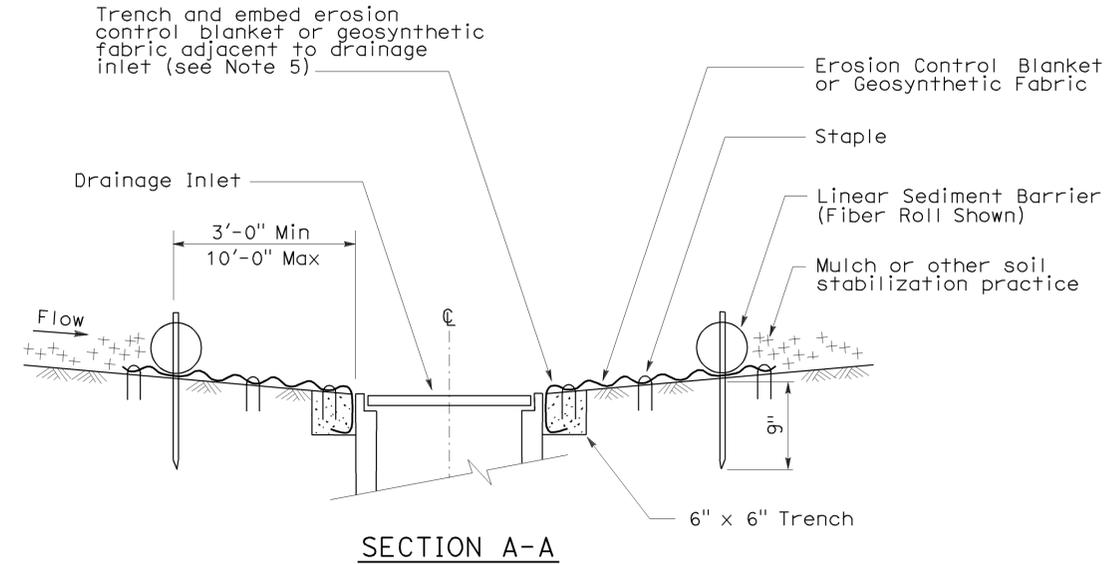


SECTION A-A

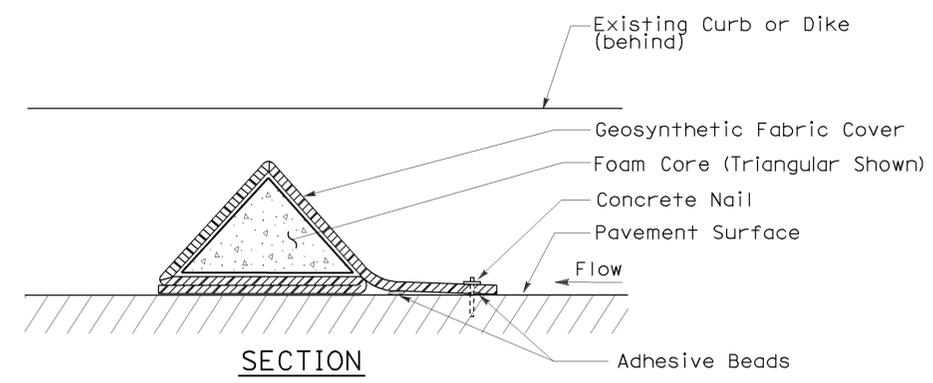


SECTION FLEXIBLE SEDIMENT BARRIER DETAIL (FOAM BARRIER SHOWN)

NOTES:


1. See Standard Plan T51 for Temporary Silt Fence.
2. Dimensions may vary to fit field conditions.
3. Install a minimum of 3 flexible sediment barriers upstream of each drainage inlet to be protected.
4. Position erosion control blanket or geosynthetic fabric at edge of concrete apron and secure in trench.
5. Erosion control blanket or geosynthetic fabric is not required if the area adjacent to the drainage inlet is vegetated.

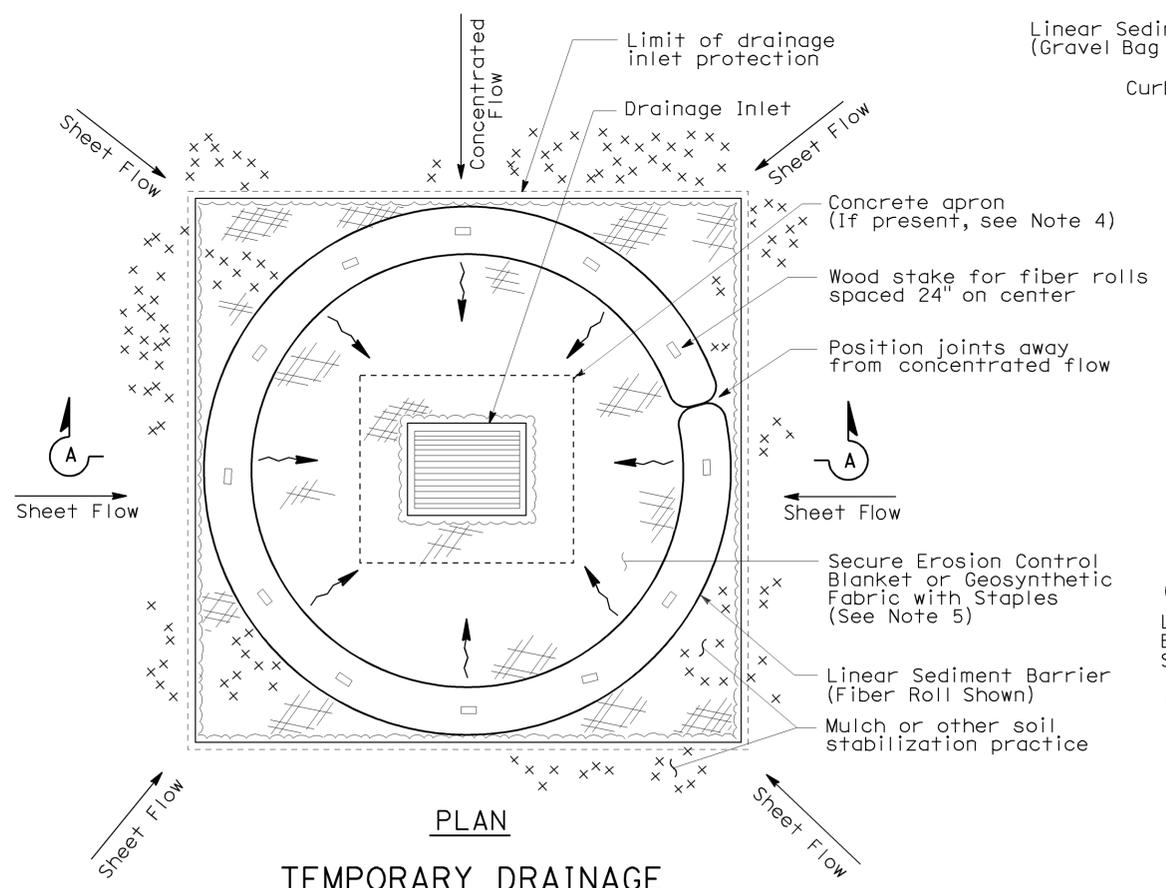


PLAN TEMPORARY DRAINAGE INLET PROTECTION (TYPE 4A)

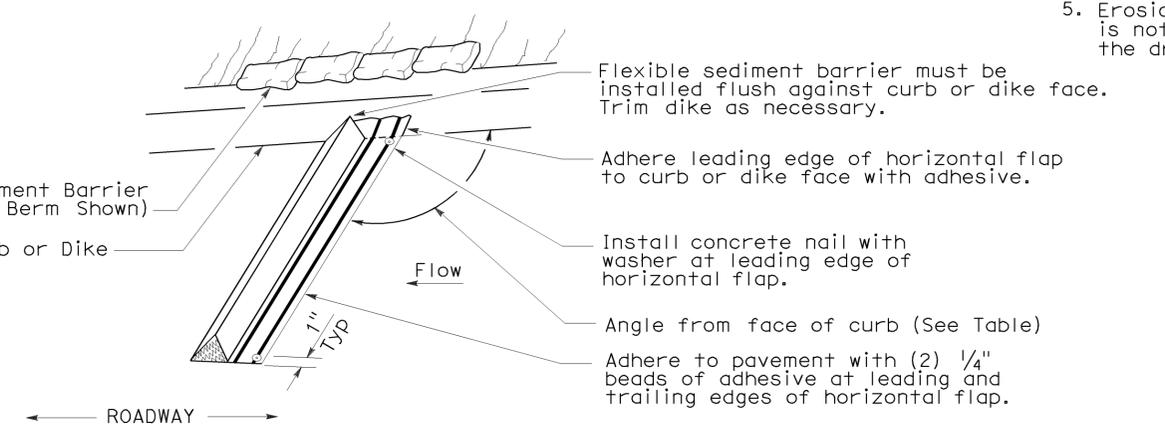

PERSPECTIVE

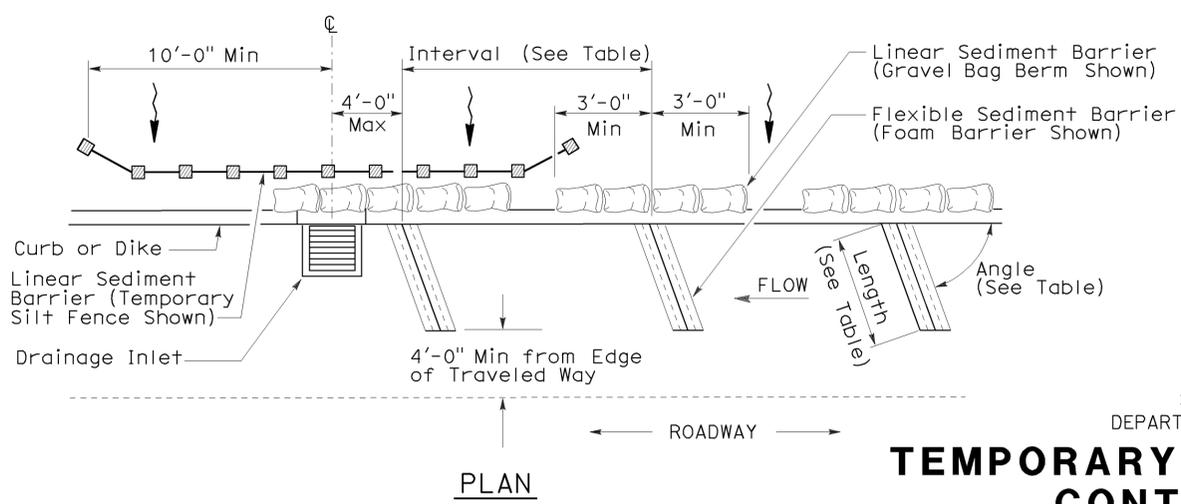

PLAN TEMPORARY DRAINAGE INLET PROTECTION (TYPE 4B) FLEXIBLE SEDIMENT BARRIER

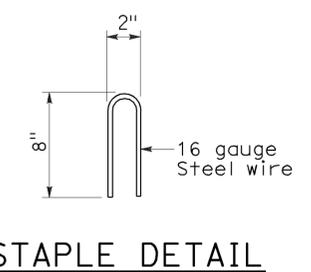

STAPLE DETAIL

STATE OF CALIFORNIA
DEPARTMENT OF TRANSPORTATION


TEMPORARY WATER POLLUTION CONTROL DETAILS (TEMPORARY DRAINAGE INLET PROTECTION)

NO SCALE
NSP T63 DATED AUGUST 15, 2008 SUPPLEMENTS THE STANDARD PLANS BOOK DATED MAY 2006.


2006 NEW STANDARD PLAN NSP T63

DIST	COUNTY	ROUTE	POST MILES TOTAL PROJECT	SHEET NO.	TOTAL SHEETS
07	LA	5,10,14, 47,60,etc	Var	72	72


Robert B. Schott
 LICENSED LANDSCAPE ARCHITECT
 August 15, 2008
 PLANS APPROVAL DATE
The State of California or its officers or agents shall not be responsible for the accuracy or completeness of electronic copies of this plan sheet.

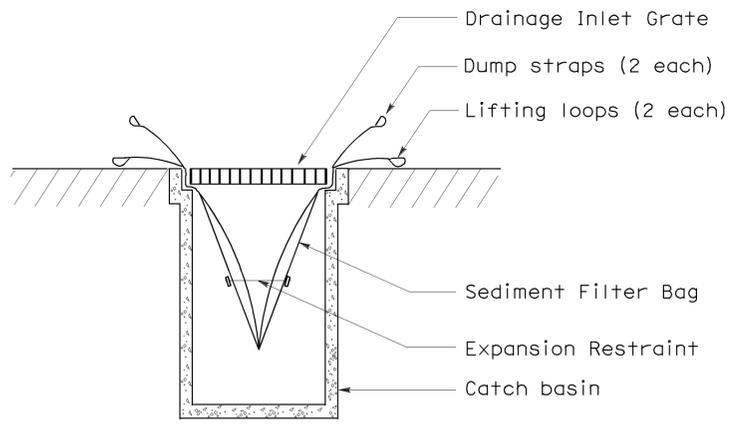


SECTION B-B
SEDIMENT FILTER BAG DETAIL

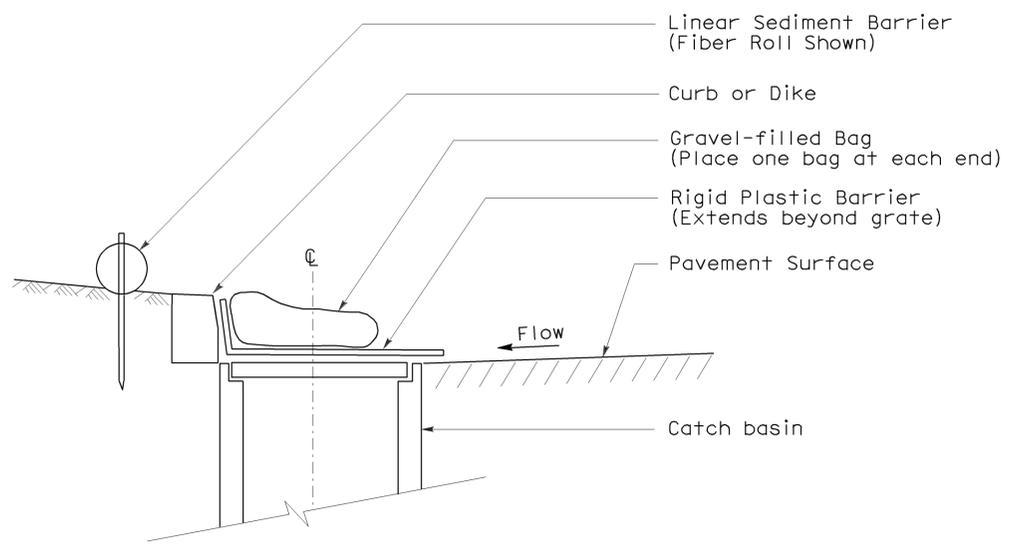


SECTION
TEMPORARY DRAINAGE
INLET PROTECTION (TYPE 6A)
(CATCH BASIN WITH GRATE)

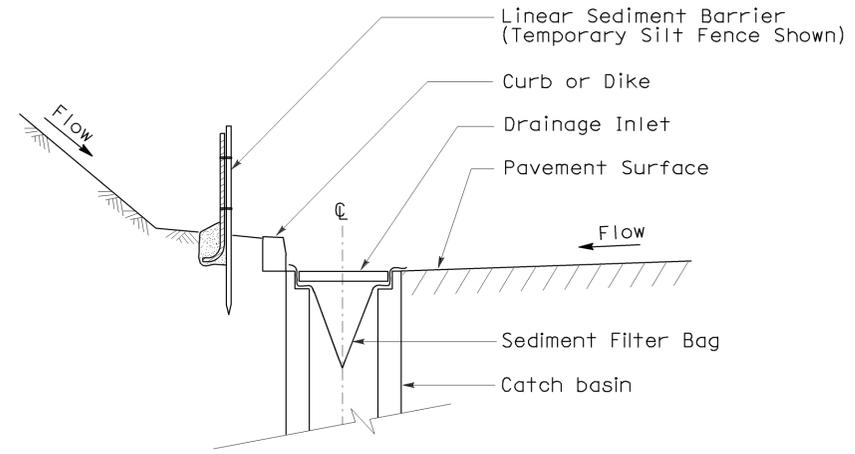

SECTION A-A

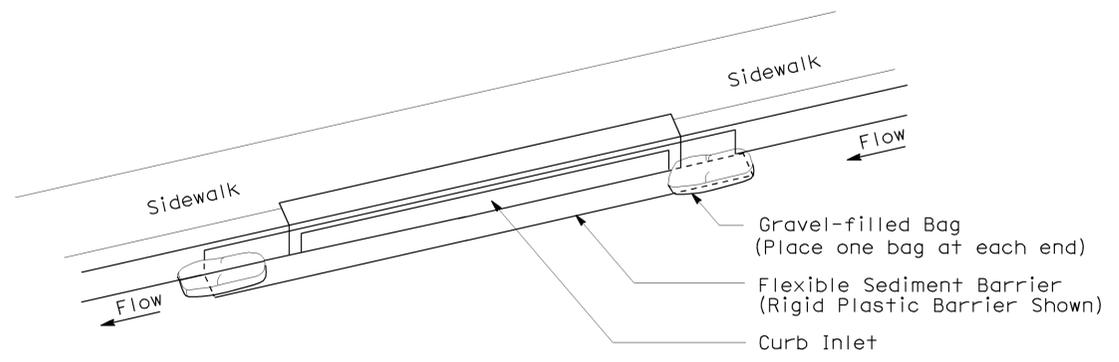

PERSPECTIVE
TEMPORARY DRAINAGE
INLET PROTECTION (TYPE 6B)
(CURB INLET WITHOUT GRATE)

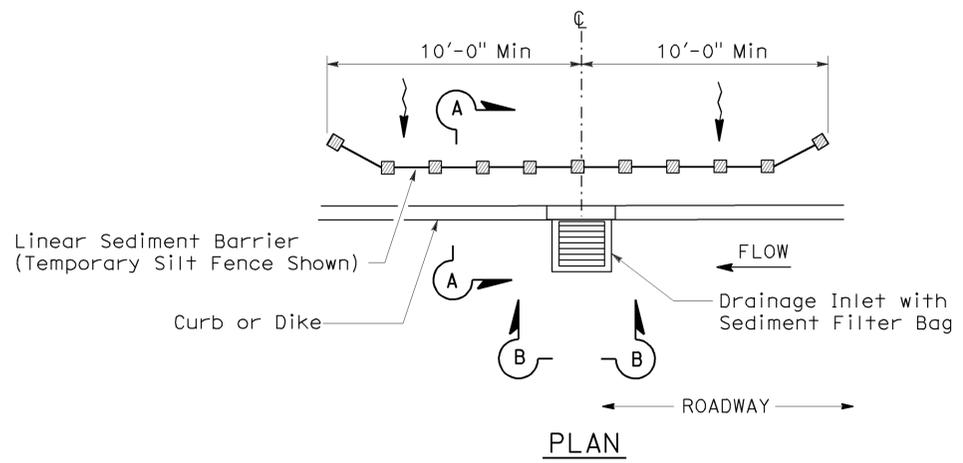

PLAN
TEMPORARY DRAINAGE
INLET PROTECTION (TYPE 5)
(SEDIMENT FILTER BAG)

NOTES:

1. See Standard Plan T51 for Temporary Silt Fence.
2. Dimensions may vary to fit field conditions.

To accompany plans dated 10-22-12

STATE OF CALIFORNIA
DEPARTMENT OF TRANSPORTATION
**TEMPORARY WATER POLLUTION
CONTROL DETAILS
(TEMPORARY DRAINAGE
INLET PROTECTION)**

NO SCALE
NSP T64 DATED AUGUST 15, 2008 SUPPLEMENTS
THE STANDARD PLANS BOOK DATED MAY 2006.